




FIRST NATIONAL BUILDING
PROPOSED EXTERIOR
MODIFICATIONS

LOCATION

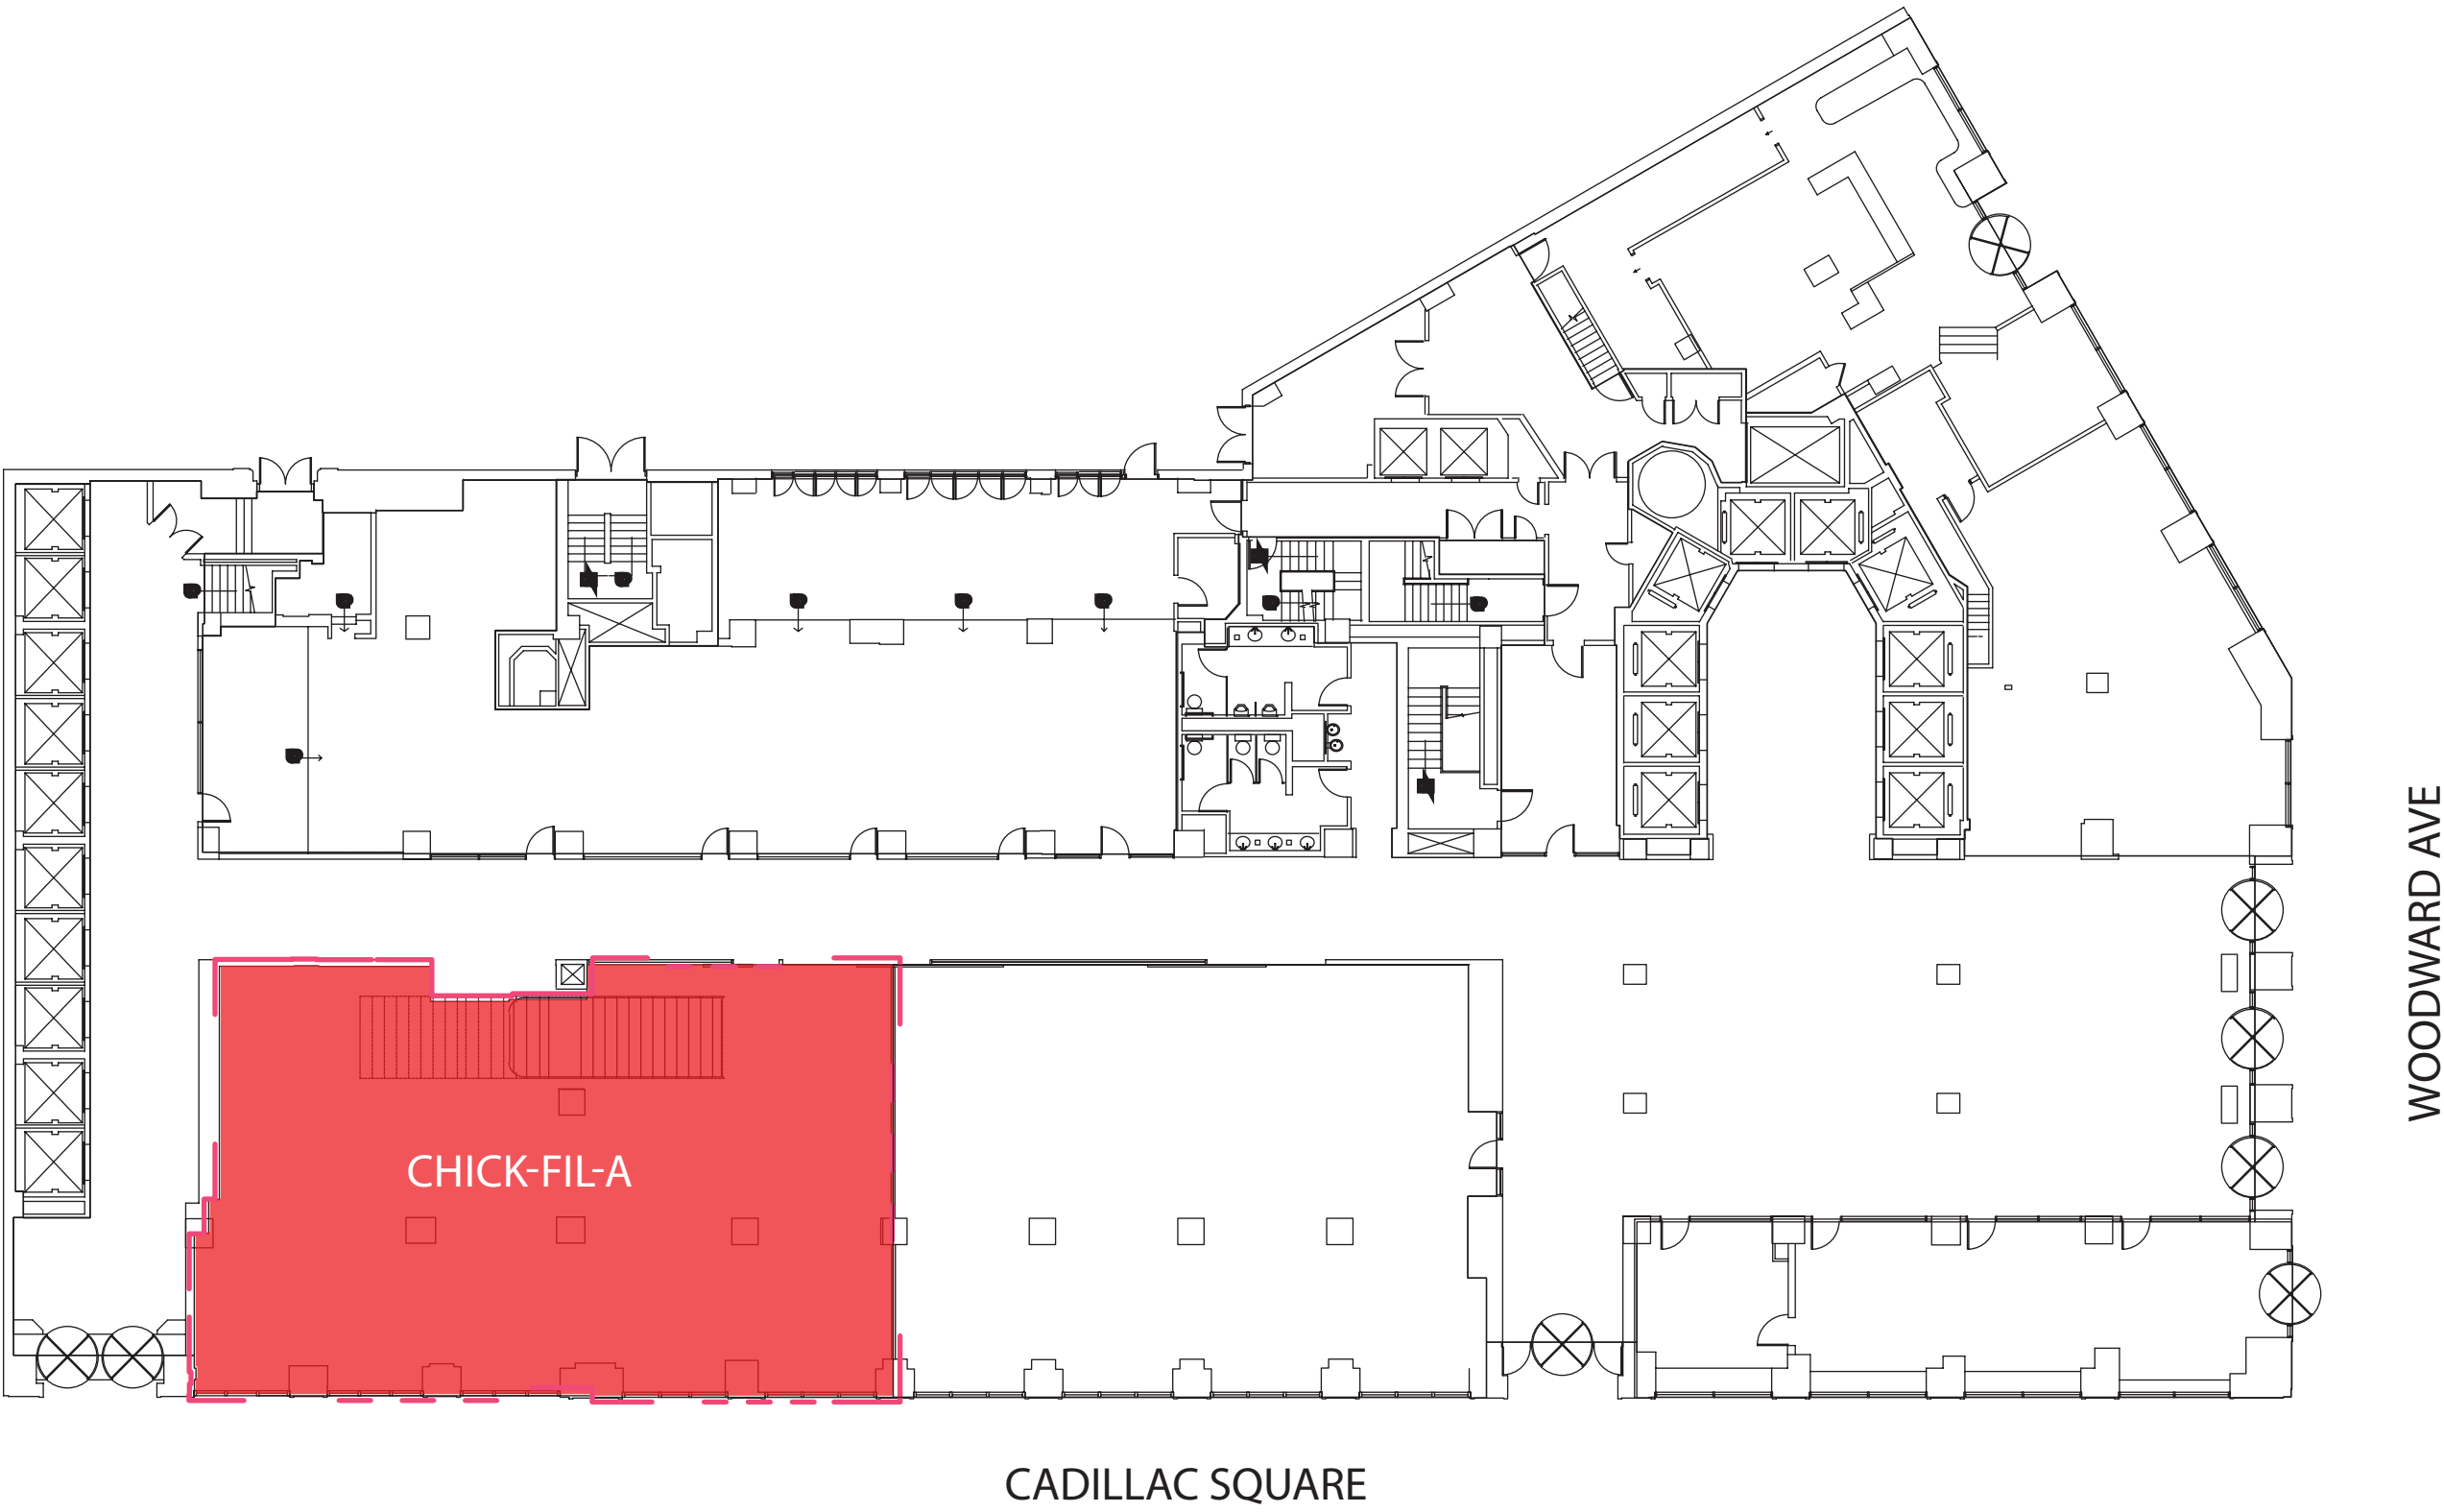

EXISTING CONDITIONS



north elevation, looking southeast



north elevation, looking southwest

EXISTING CONDITIONS




Existing storefront bay, location of proposed new door. Non-historic storefront and non-historic granite base and infill.



Location of proposed new accessible ramp. Existing permanent structure in background.


PROPOSED PLAN

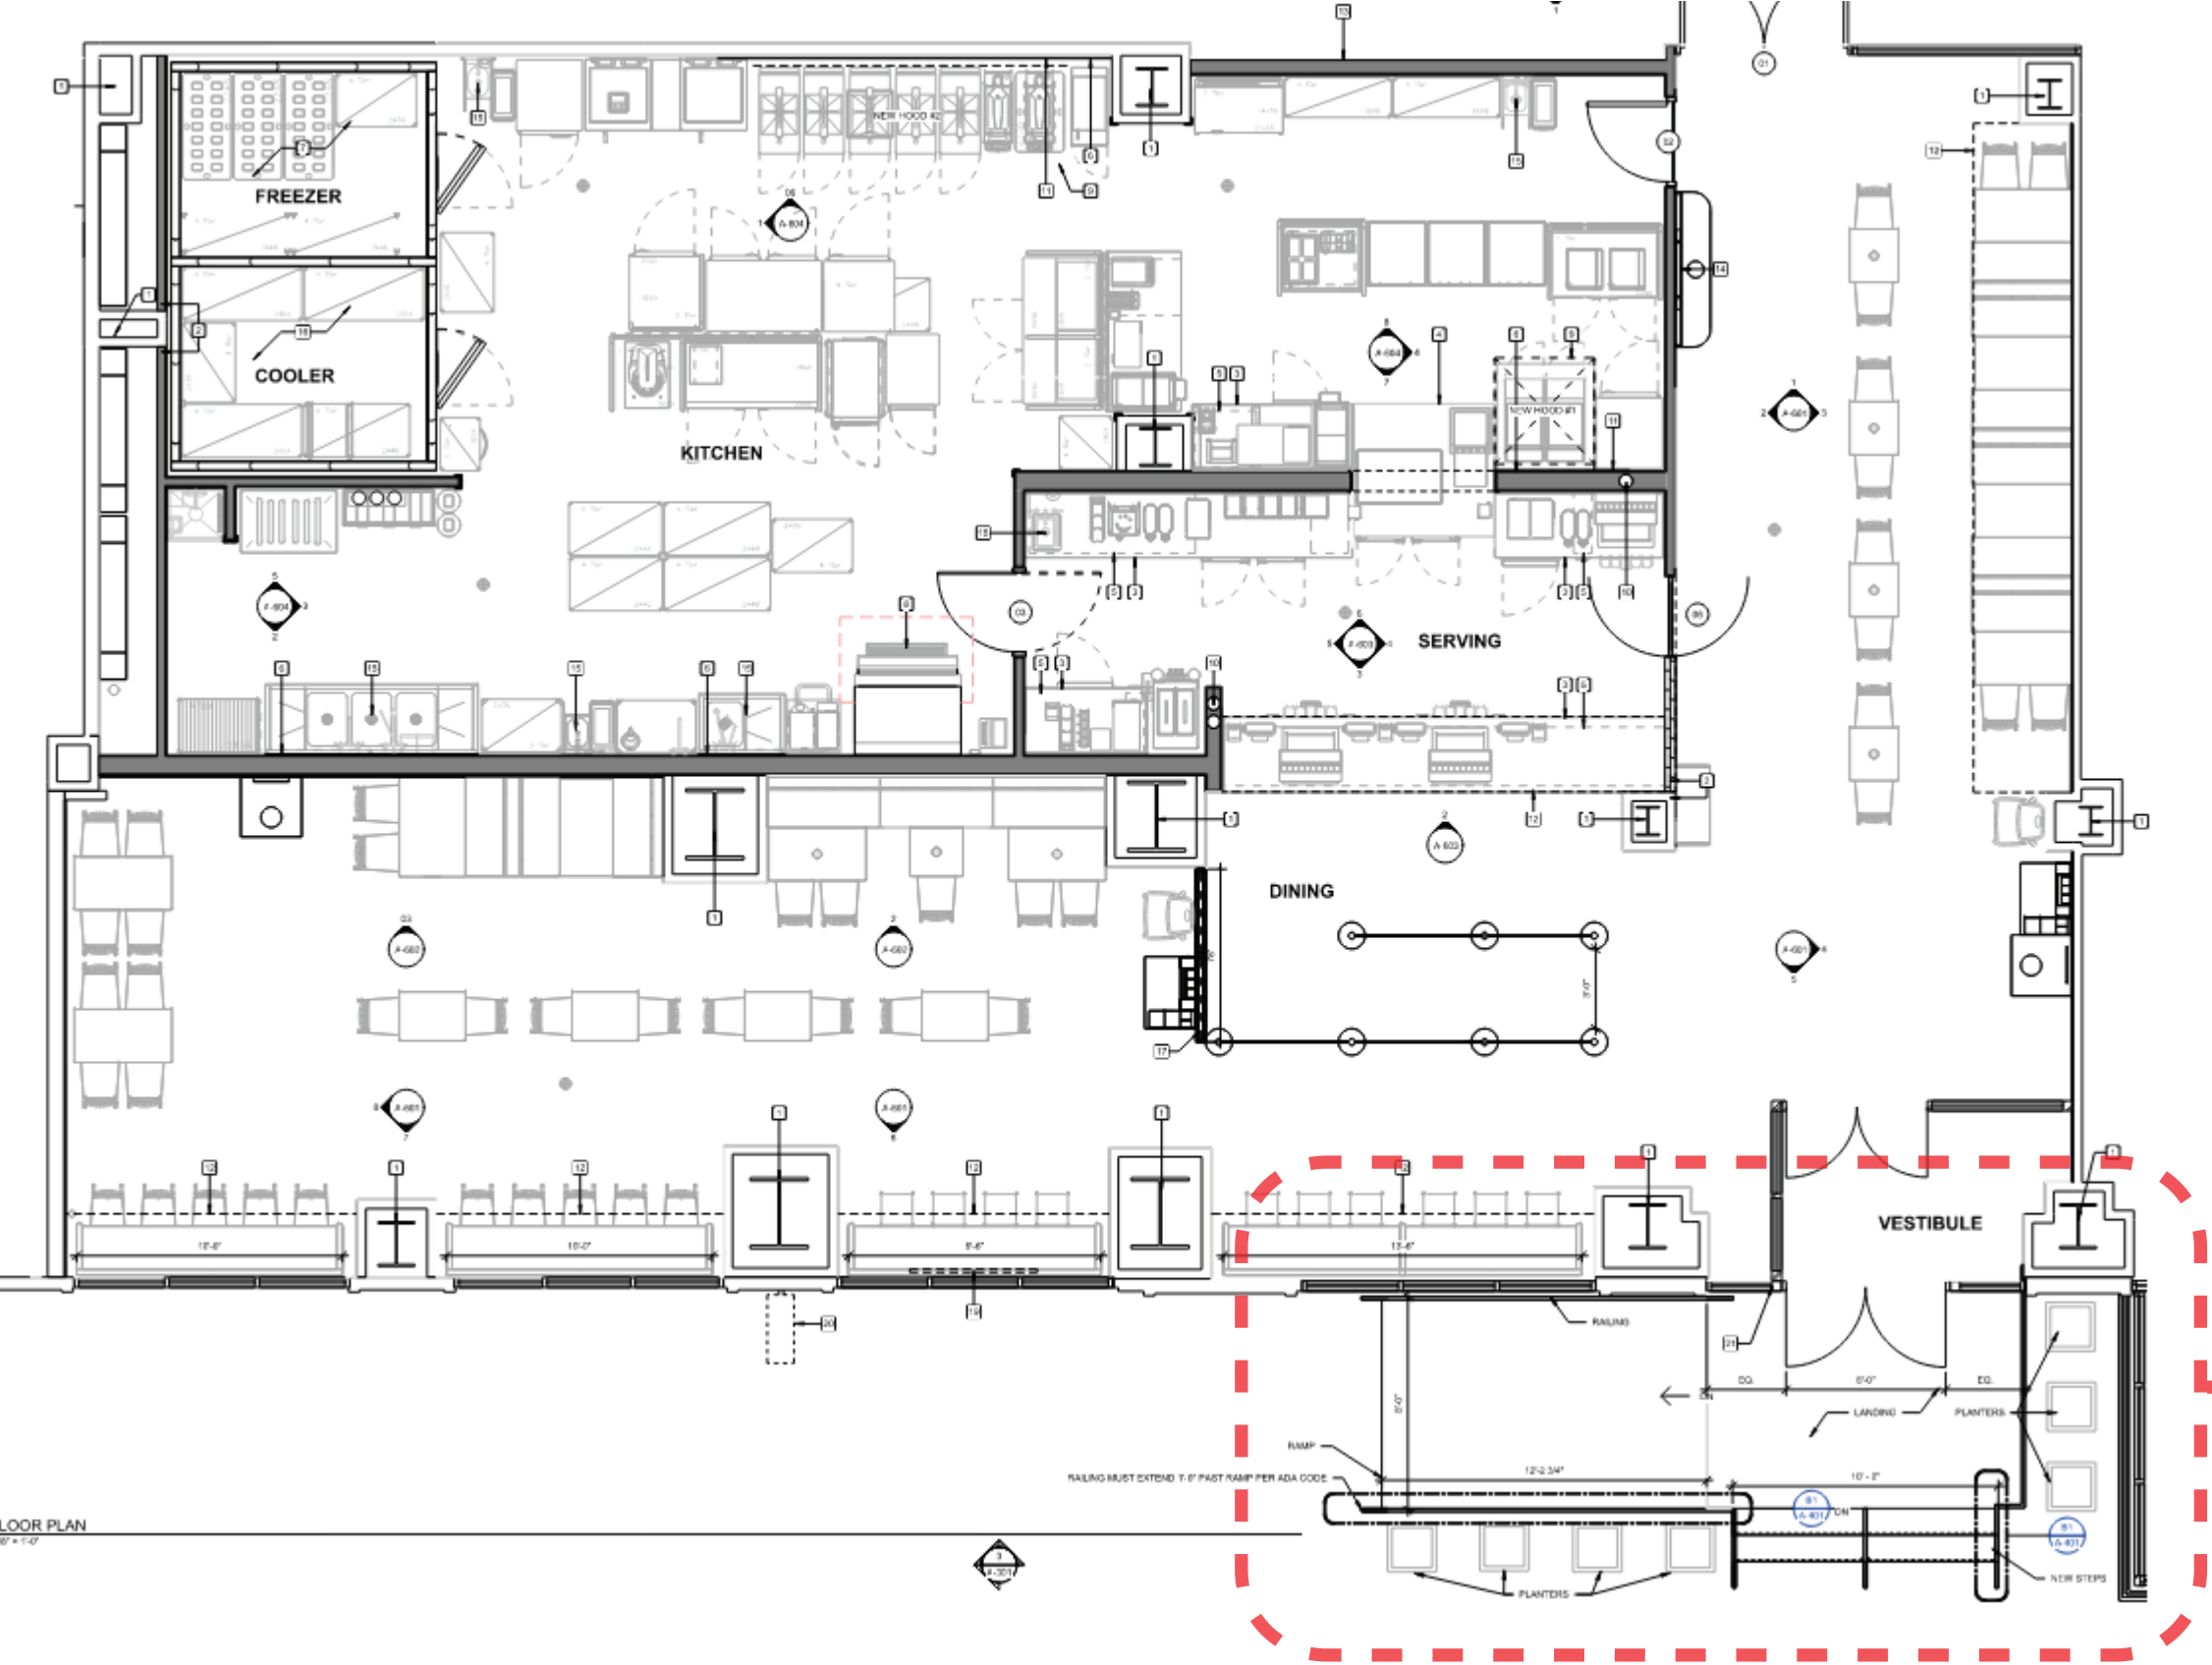

PROPOSED STOREFRONT DOOR AND RAMP

LOOR PLAN
1/8" = 1'-0"

PROPOSED PLAN

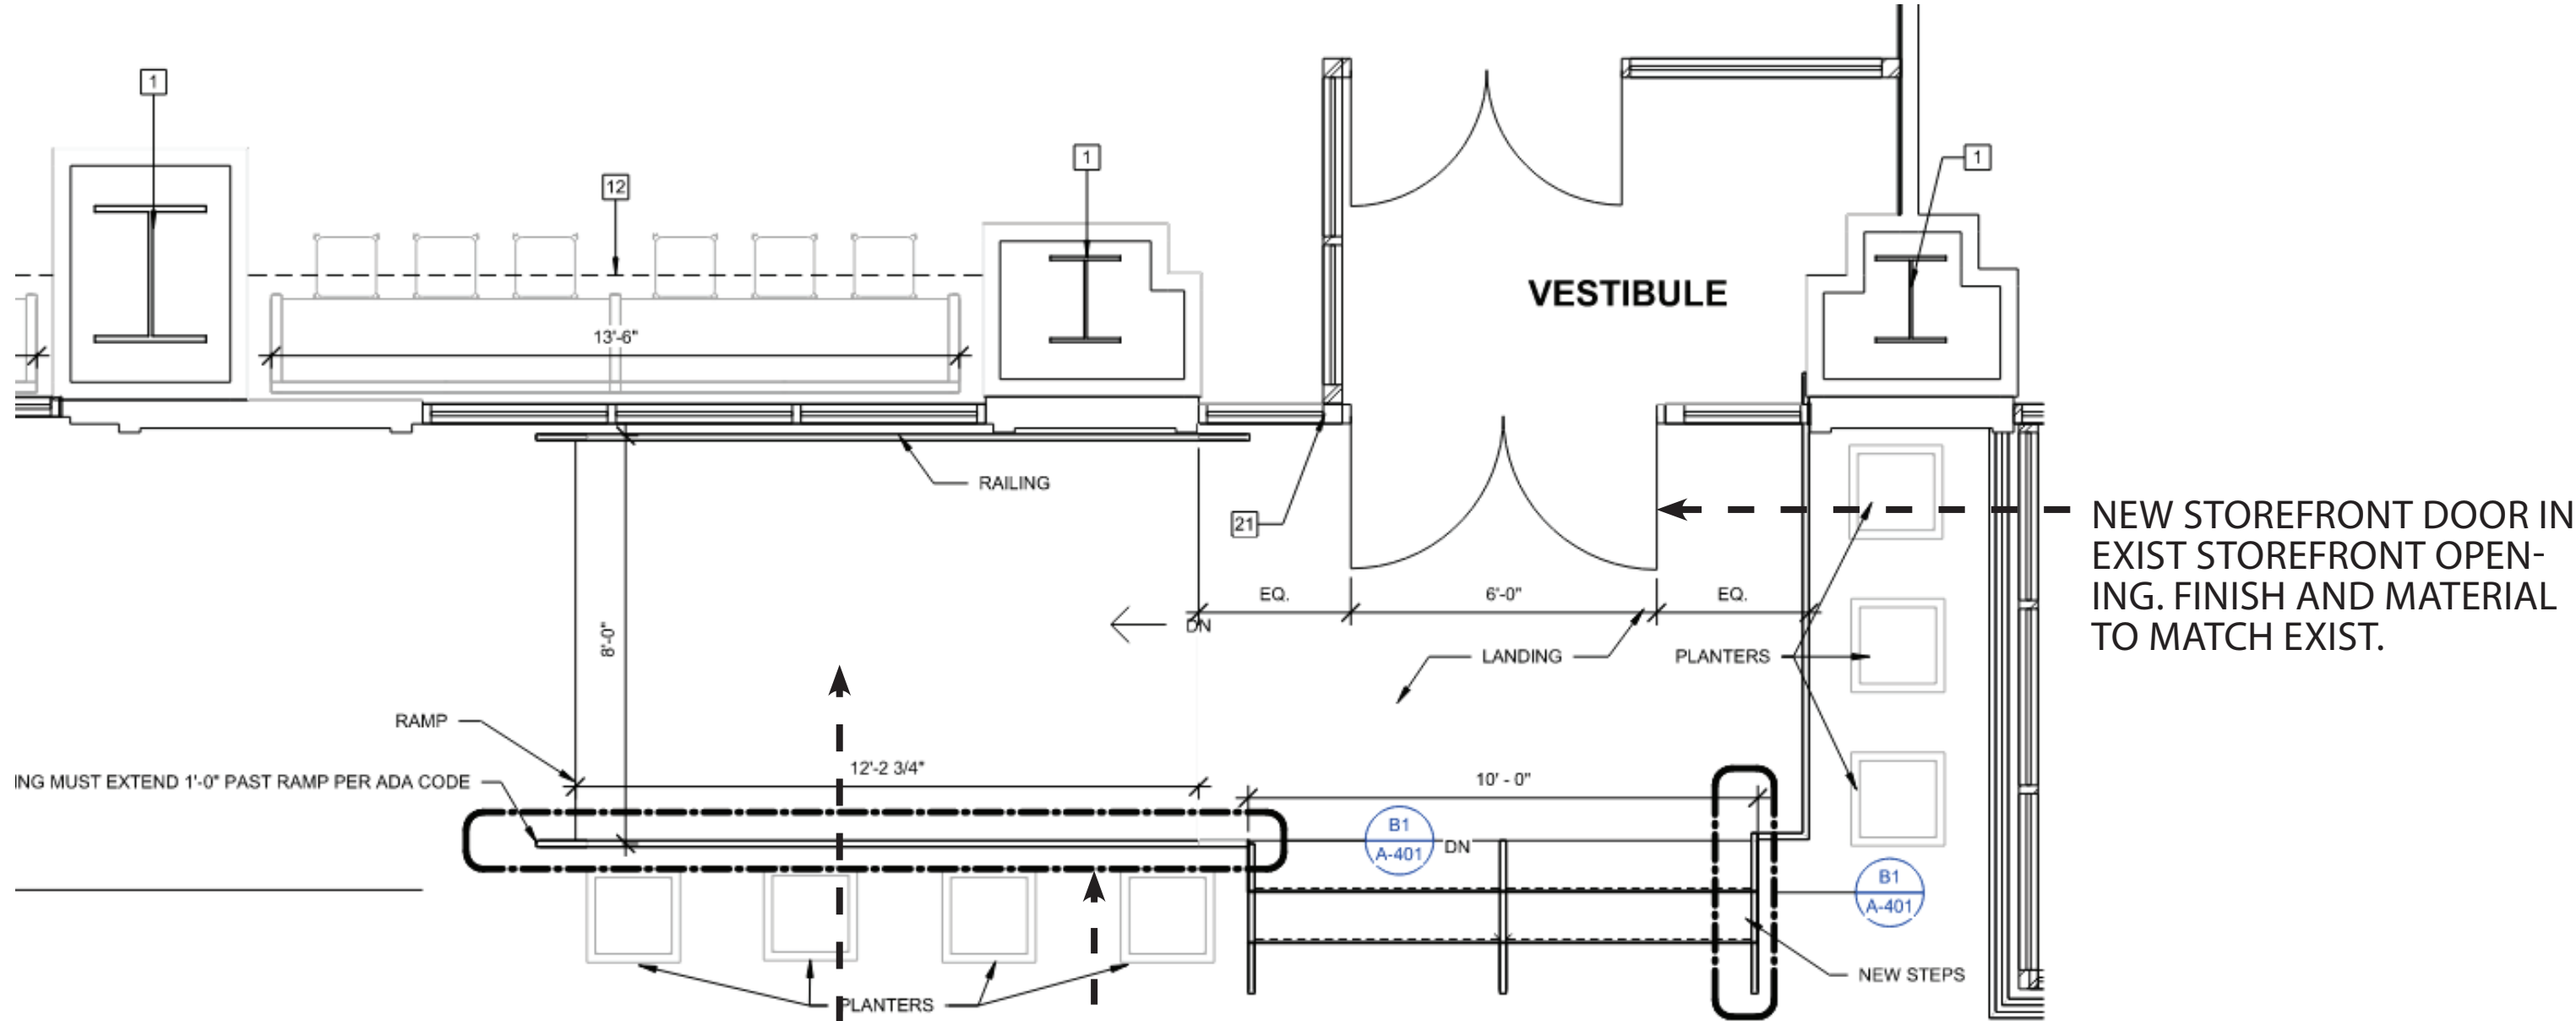

NEW RAMP (9" ELEVATION INCREASE)
REQ'D FOR ACCESSIBILITY

POWDERCOATED BRONZE TUBE STEEL
GUARDRAIL

PROPOSED ELEVATION



PROPOSED BLADE SIGN - - - - -
EXIST STOREFRONT SYSTEM - - - - -


PROPOSED SHALLOW CANOPY AND SIGNAGE - - - - -
PROPOSED RAMP + STOREFRONT DOOR - - - - -

MULLION PATTERN




PROPOSED STOREFRONT MATCHES EXIST MULLION PATTERN AND USES EXIST STOREFRONT OPENING

PROPOSED SIGNAGE

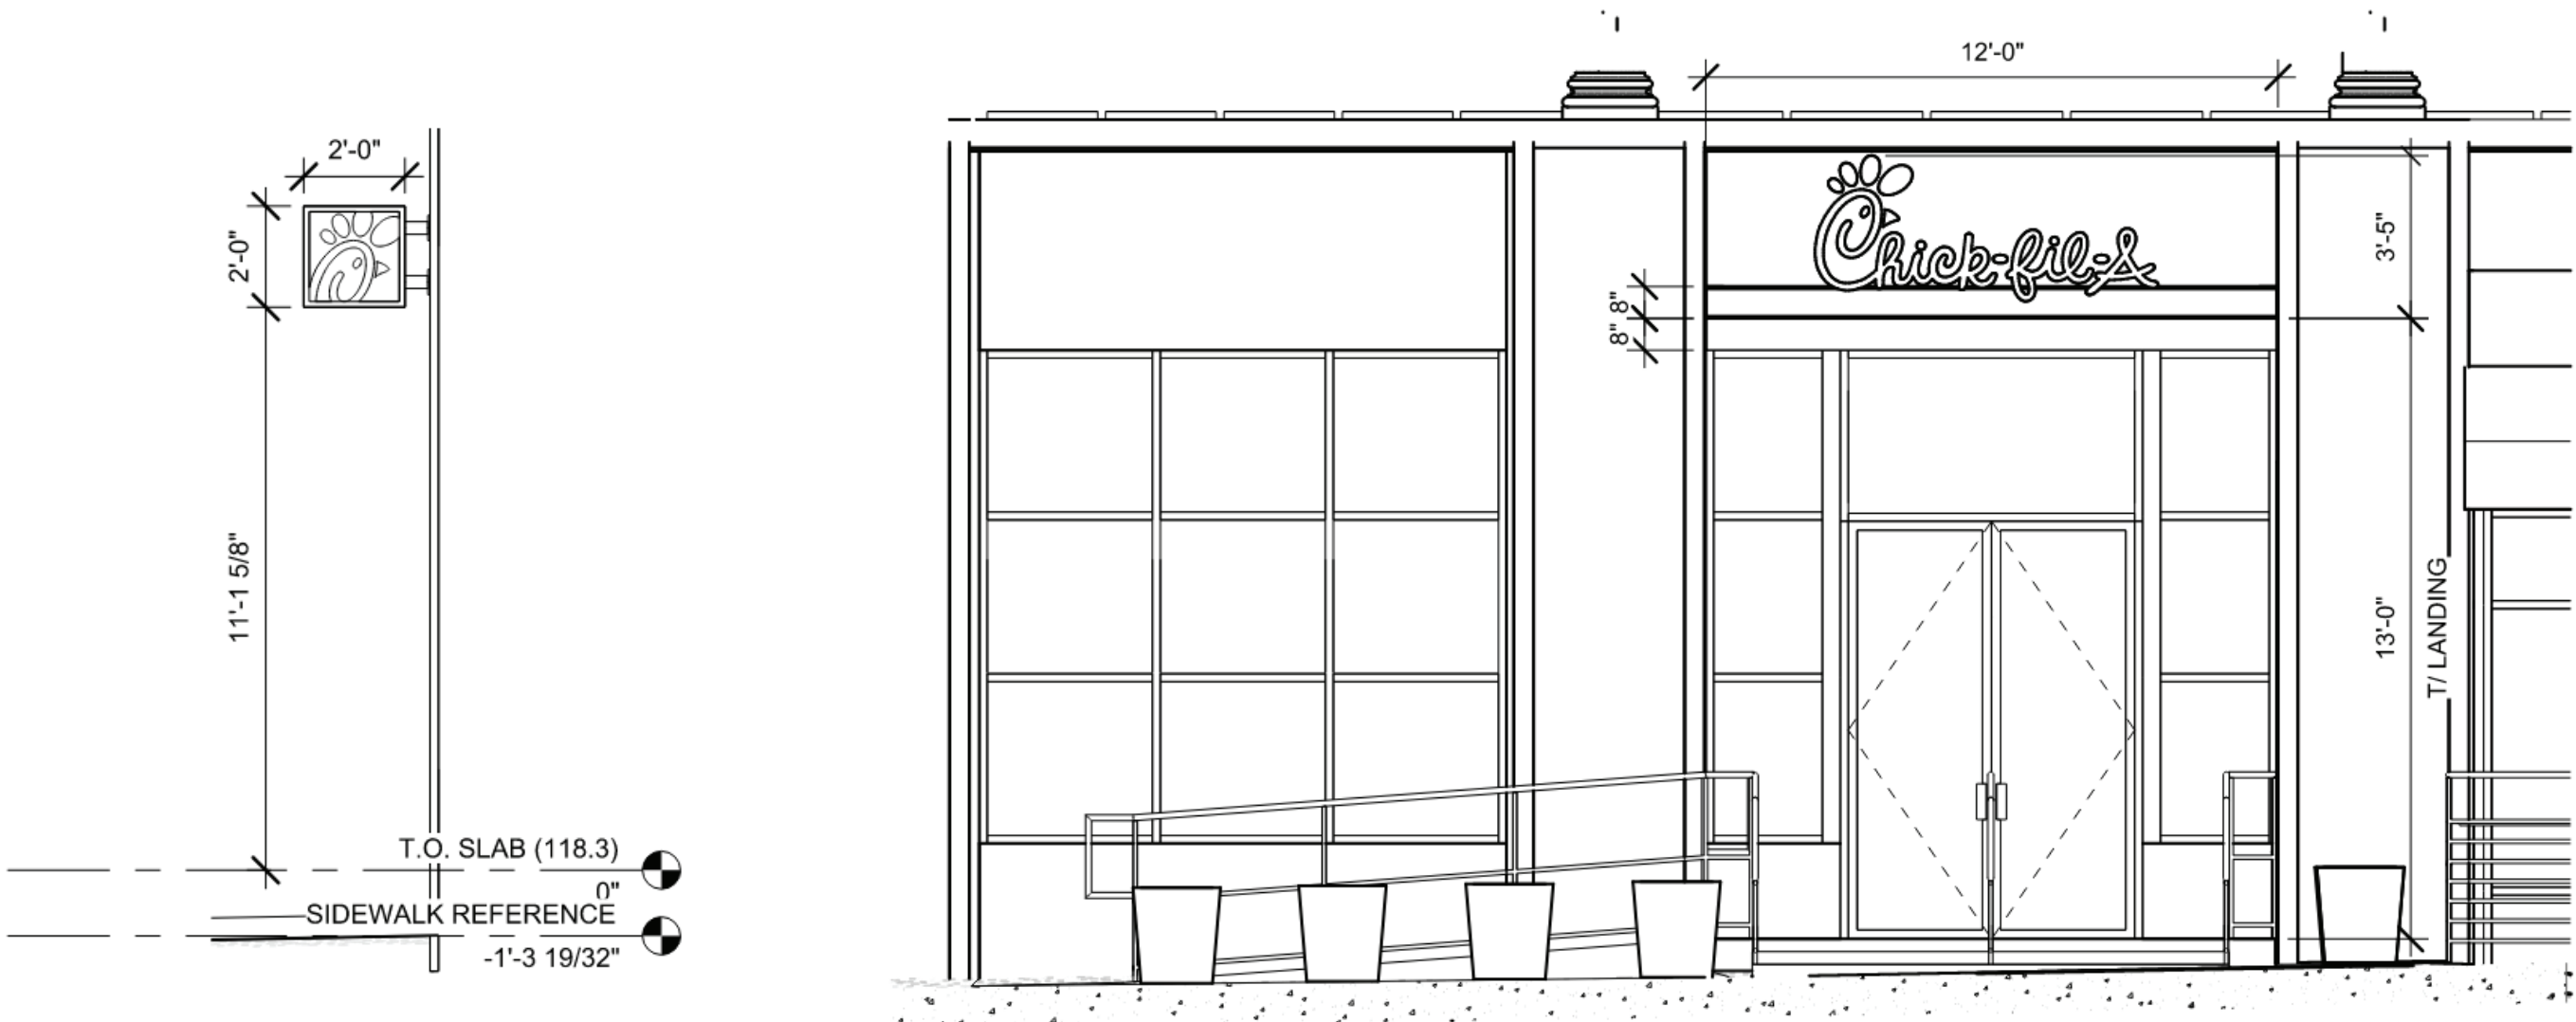


PROPOSED BLADE SIGN

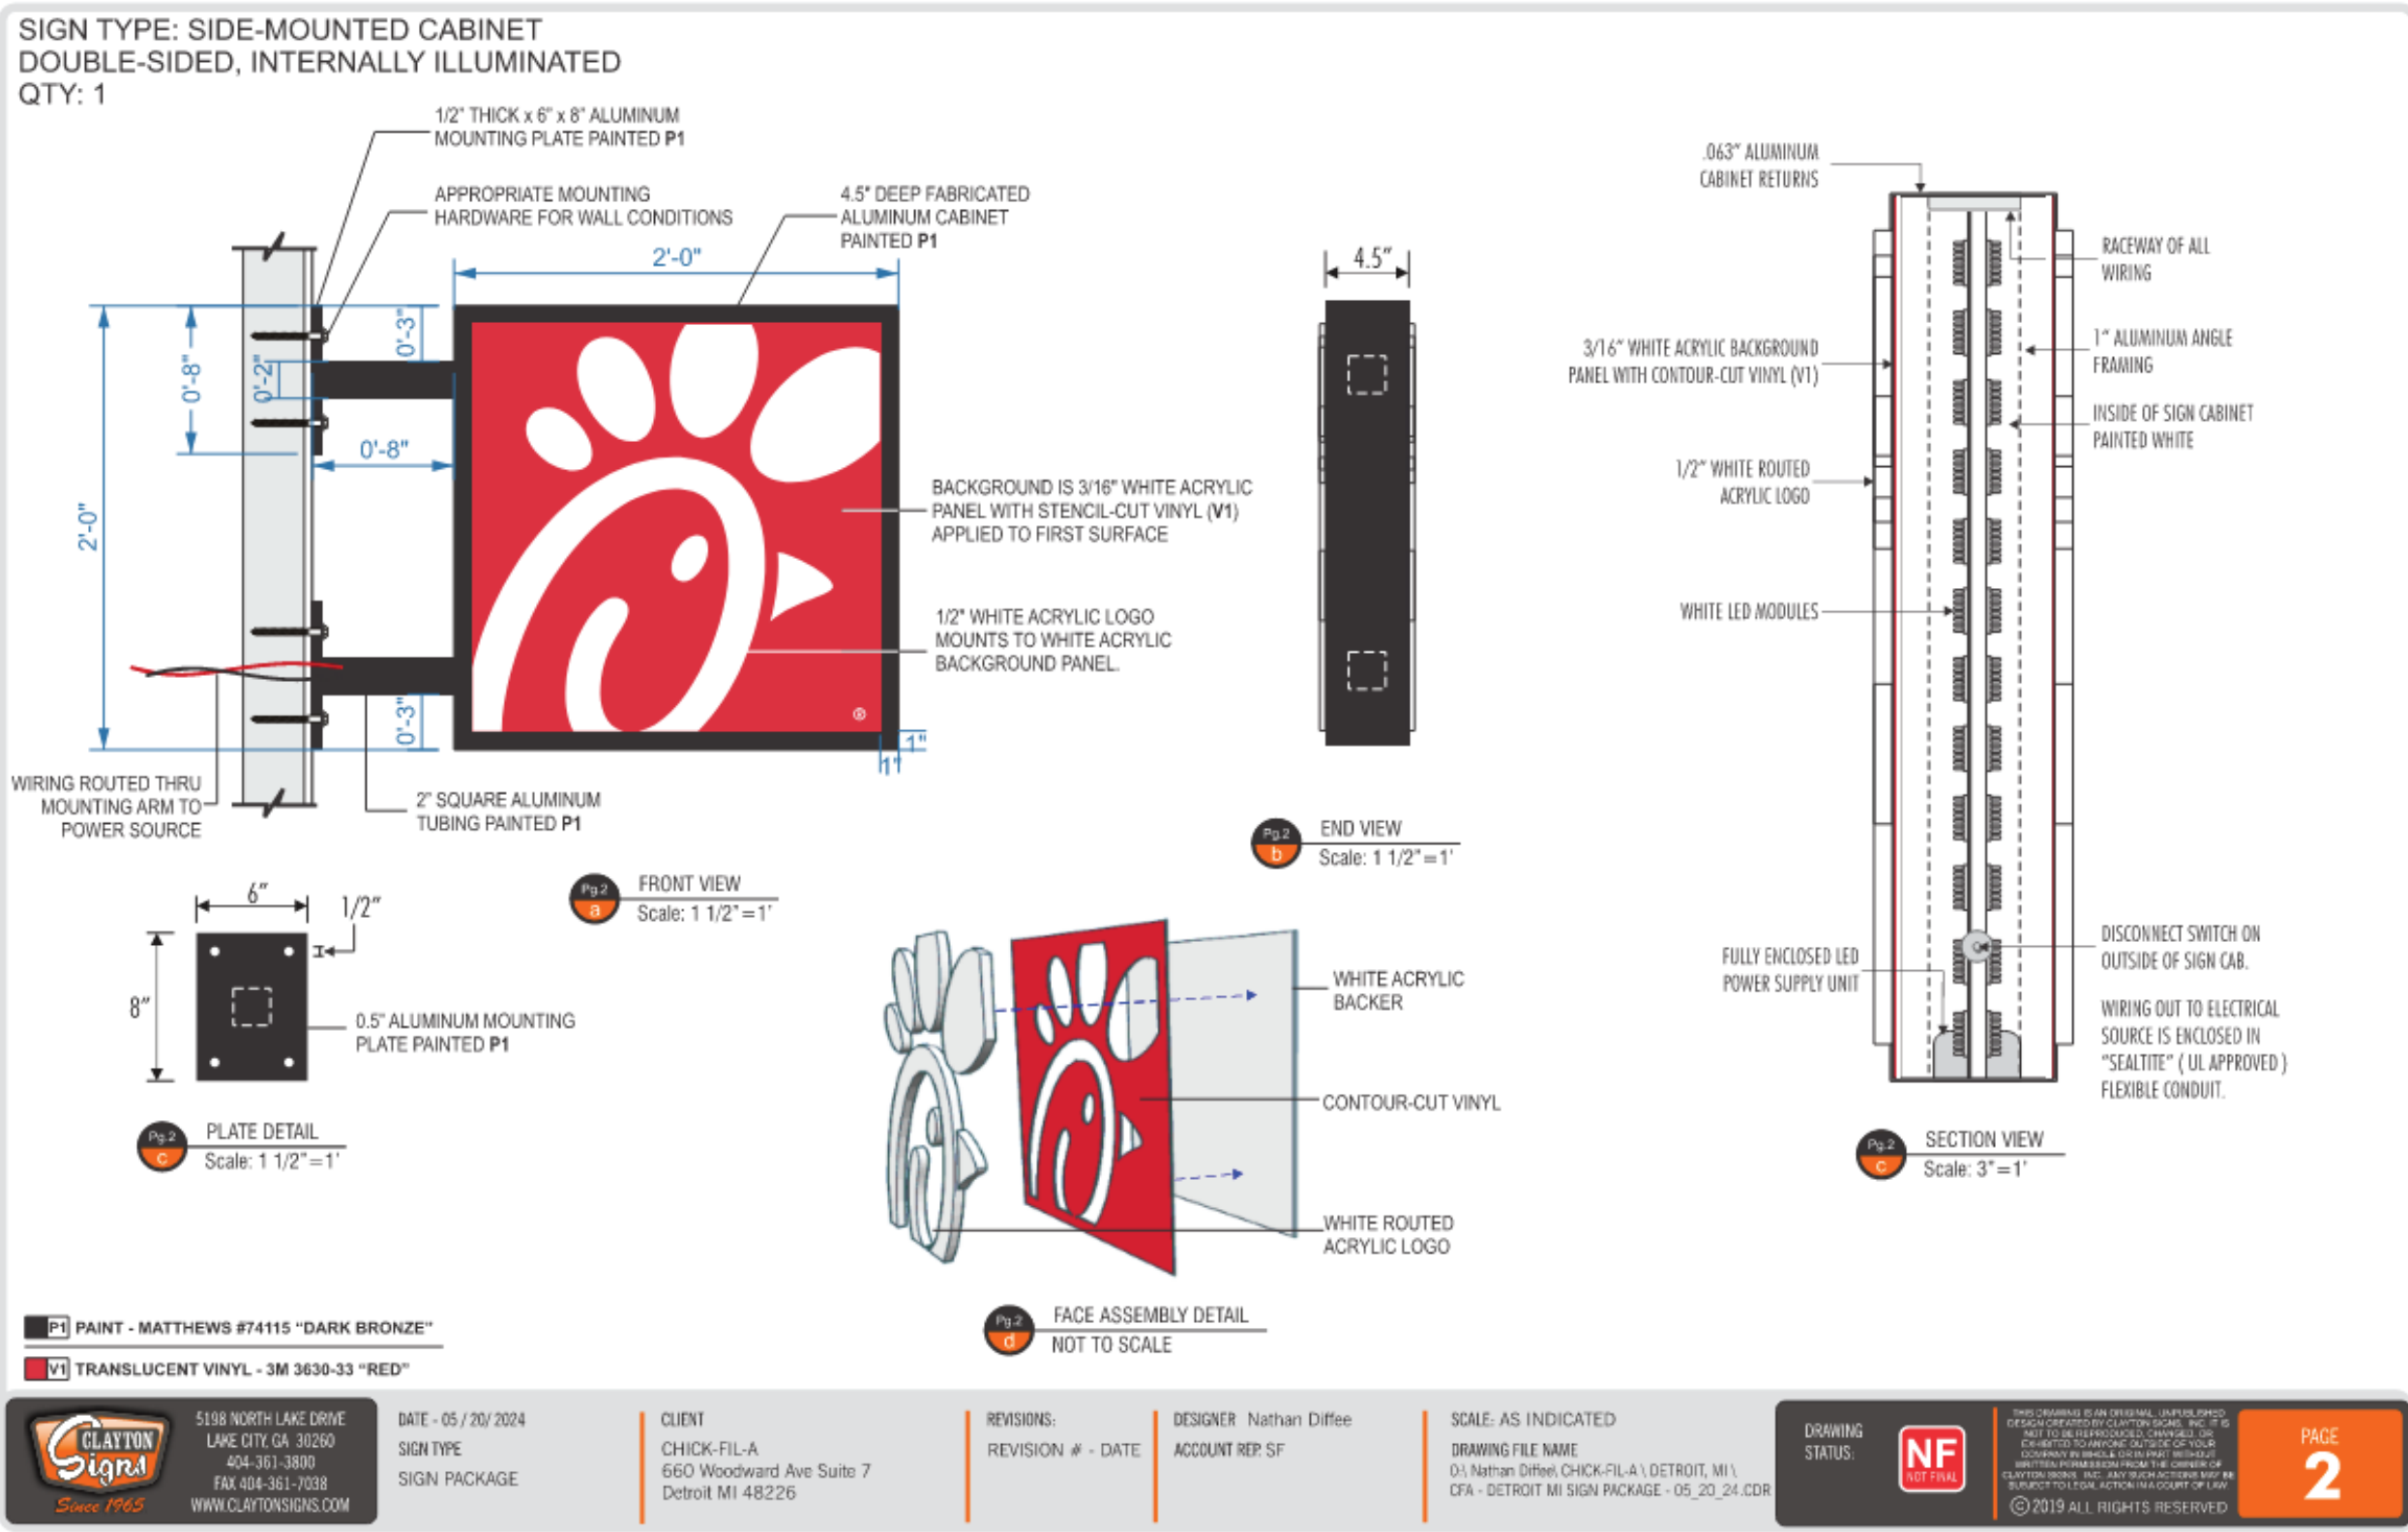

PROPOSED SCRIPT SIGN

SIGN TYPE A: 36" CHANNEL LETTERS ON I-BEAM
INTERNALLY ILLUMINATED
QTY: 1 SET

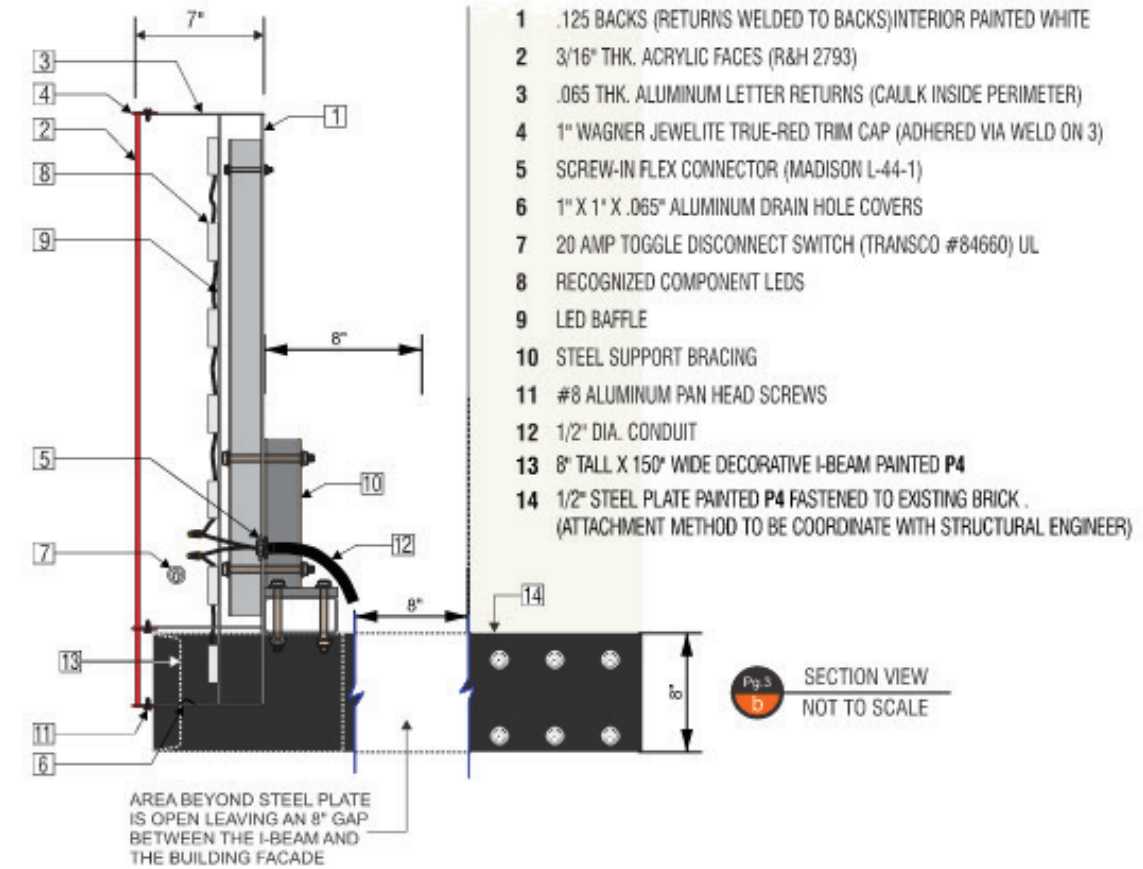

- 1 .125" BACKS (RETURNS WELDED TO BACKS) INTERIOR PAINTED WHITE
- 2 3/16" THK. ACRYLIC FACES (R&H 2793)
- 3 .065 THK. ALUMINUM LETTER RETURNS (CAULK INSIDE PERIMETER)
- 4 1" WAGNER JEWELITE TRUE-RED TRIM CAP (ADHERED VIA WELD ON 3)
- 5 SCREW-IN FLEX CONNECTOR (MADISON L-44-1)
- 6 1" X 1" X .065" ALUMINUM DRAIN HOLE COVERS
- 7 20 AMP TOGGLE DISCONNECT SWITCH (TRANSCO #84660) UL
- 8 RECOGNIZED COMPONENT LEDS
- 9 LED BAFFLE
- 10 STEEL SUPPORT BRACING
- 11 #8 ALUMINUM PAN HEAD SCREWS
- 12 1/2" DIA. CONDUIT
- 13 8" TALL X 150" WIDE DECORATIVE I-BEAM PAINTED P4
- 14 1/2" STEEL PLATE PAINTED P4 FASTENED TO EXISTING BRICK. (ATTACHMENT METHOD TO BE COORDINATE WITH STRUCTURAL ENGINEER)

P3 PAINT - TBD
P4 PAINT - TBD

V1 TRANSLUCENT VINYL - MATCH PANTONE 186 C



DATE - 05 / 20 / 2024
SIGN TYPE
SIGN PACKAGE

CLIENT
CHICK-FIL-A
660 Woodward Ave Suite 7
Detroit MI 48226

REVISIONS:
REVISION # - DATE

DESIGNER Nathan Diffee
ACCOUNT REP SF


SCALE: AS INDICATED
DRAWING FILE NAME
D:\Nathan Diffee\CHICK-FIL-A\DETROIT, MI\
CFA - DETROIT MI SIGN PACKAGE - 05_20_24.CDR

DRAWING STATUS: **NF**
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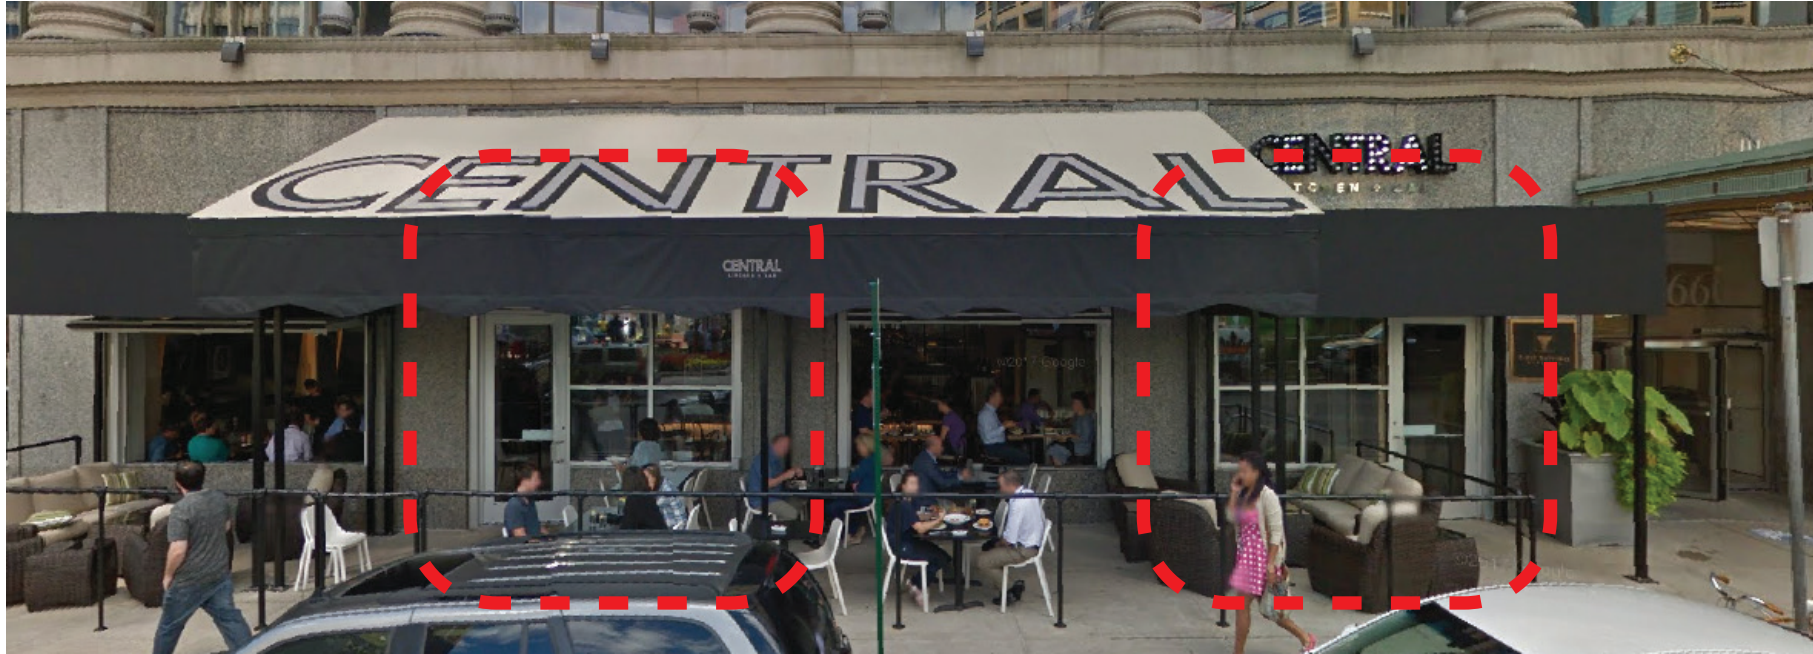
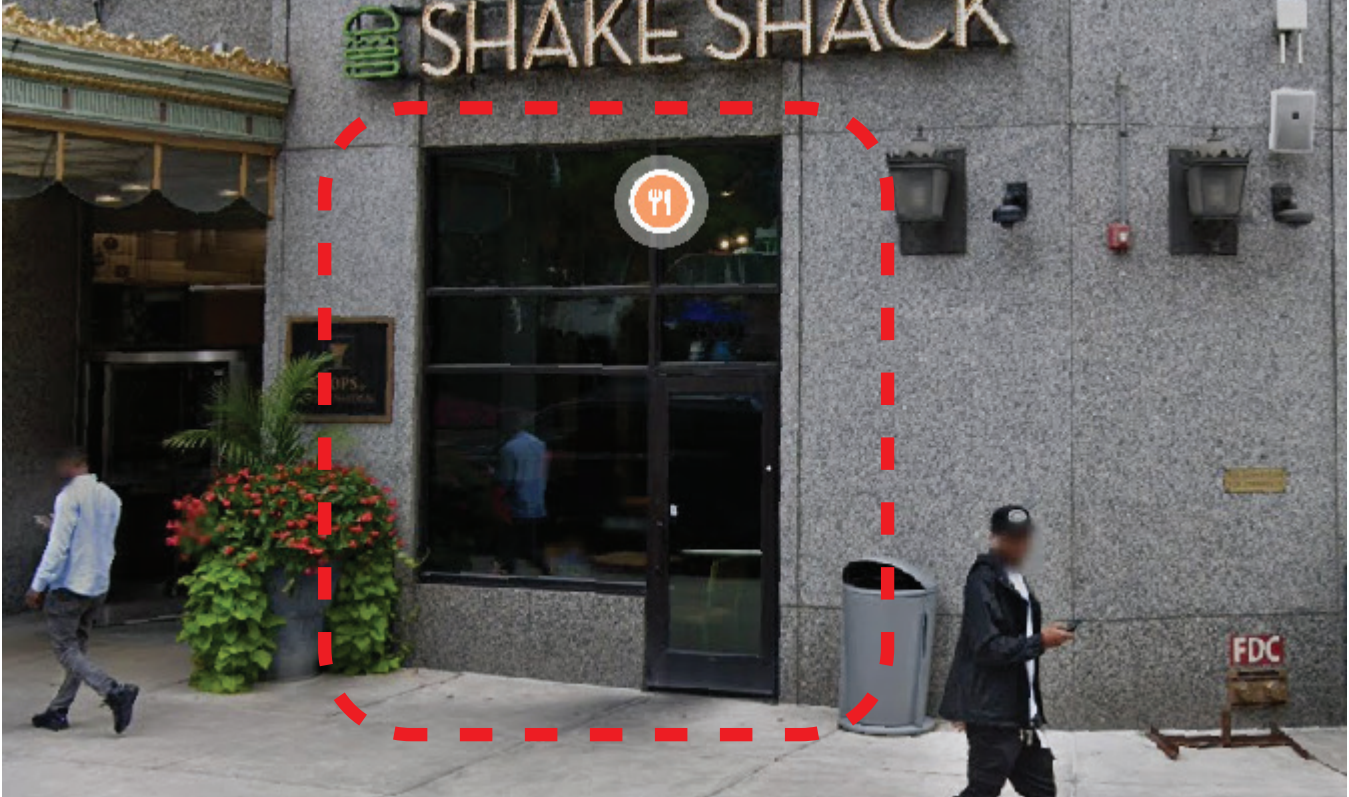
PAGE
3

PROPOSED SCRIPT SIGN

SIGN TYPE A: 36" CHANNEL LETTERS ON I-BEAM
SECTION DETAIL

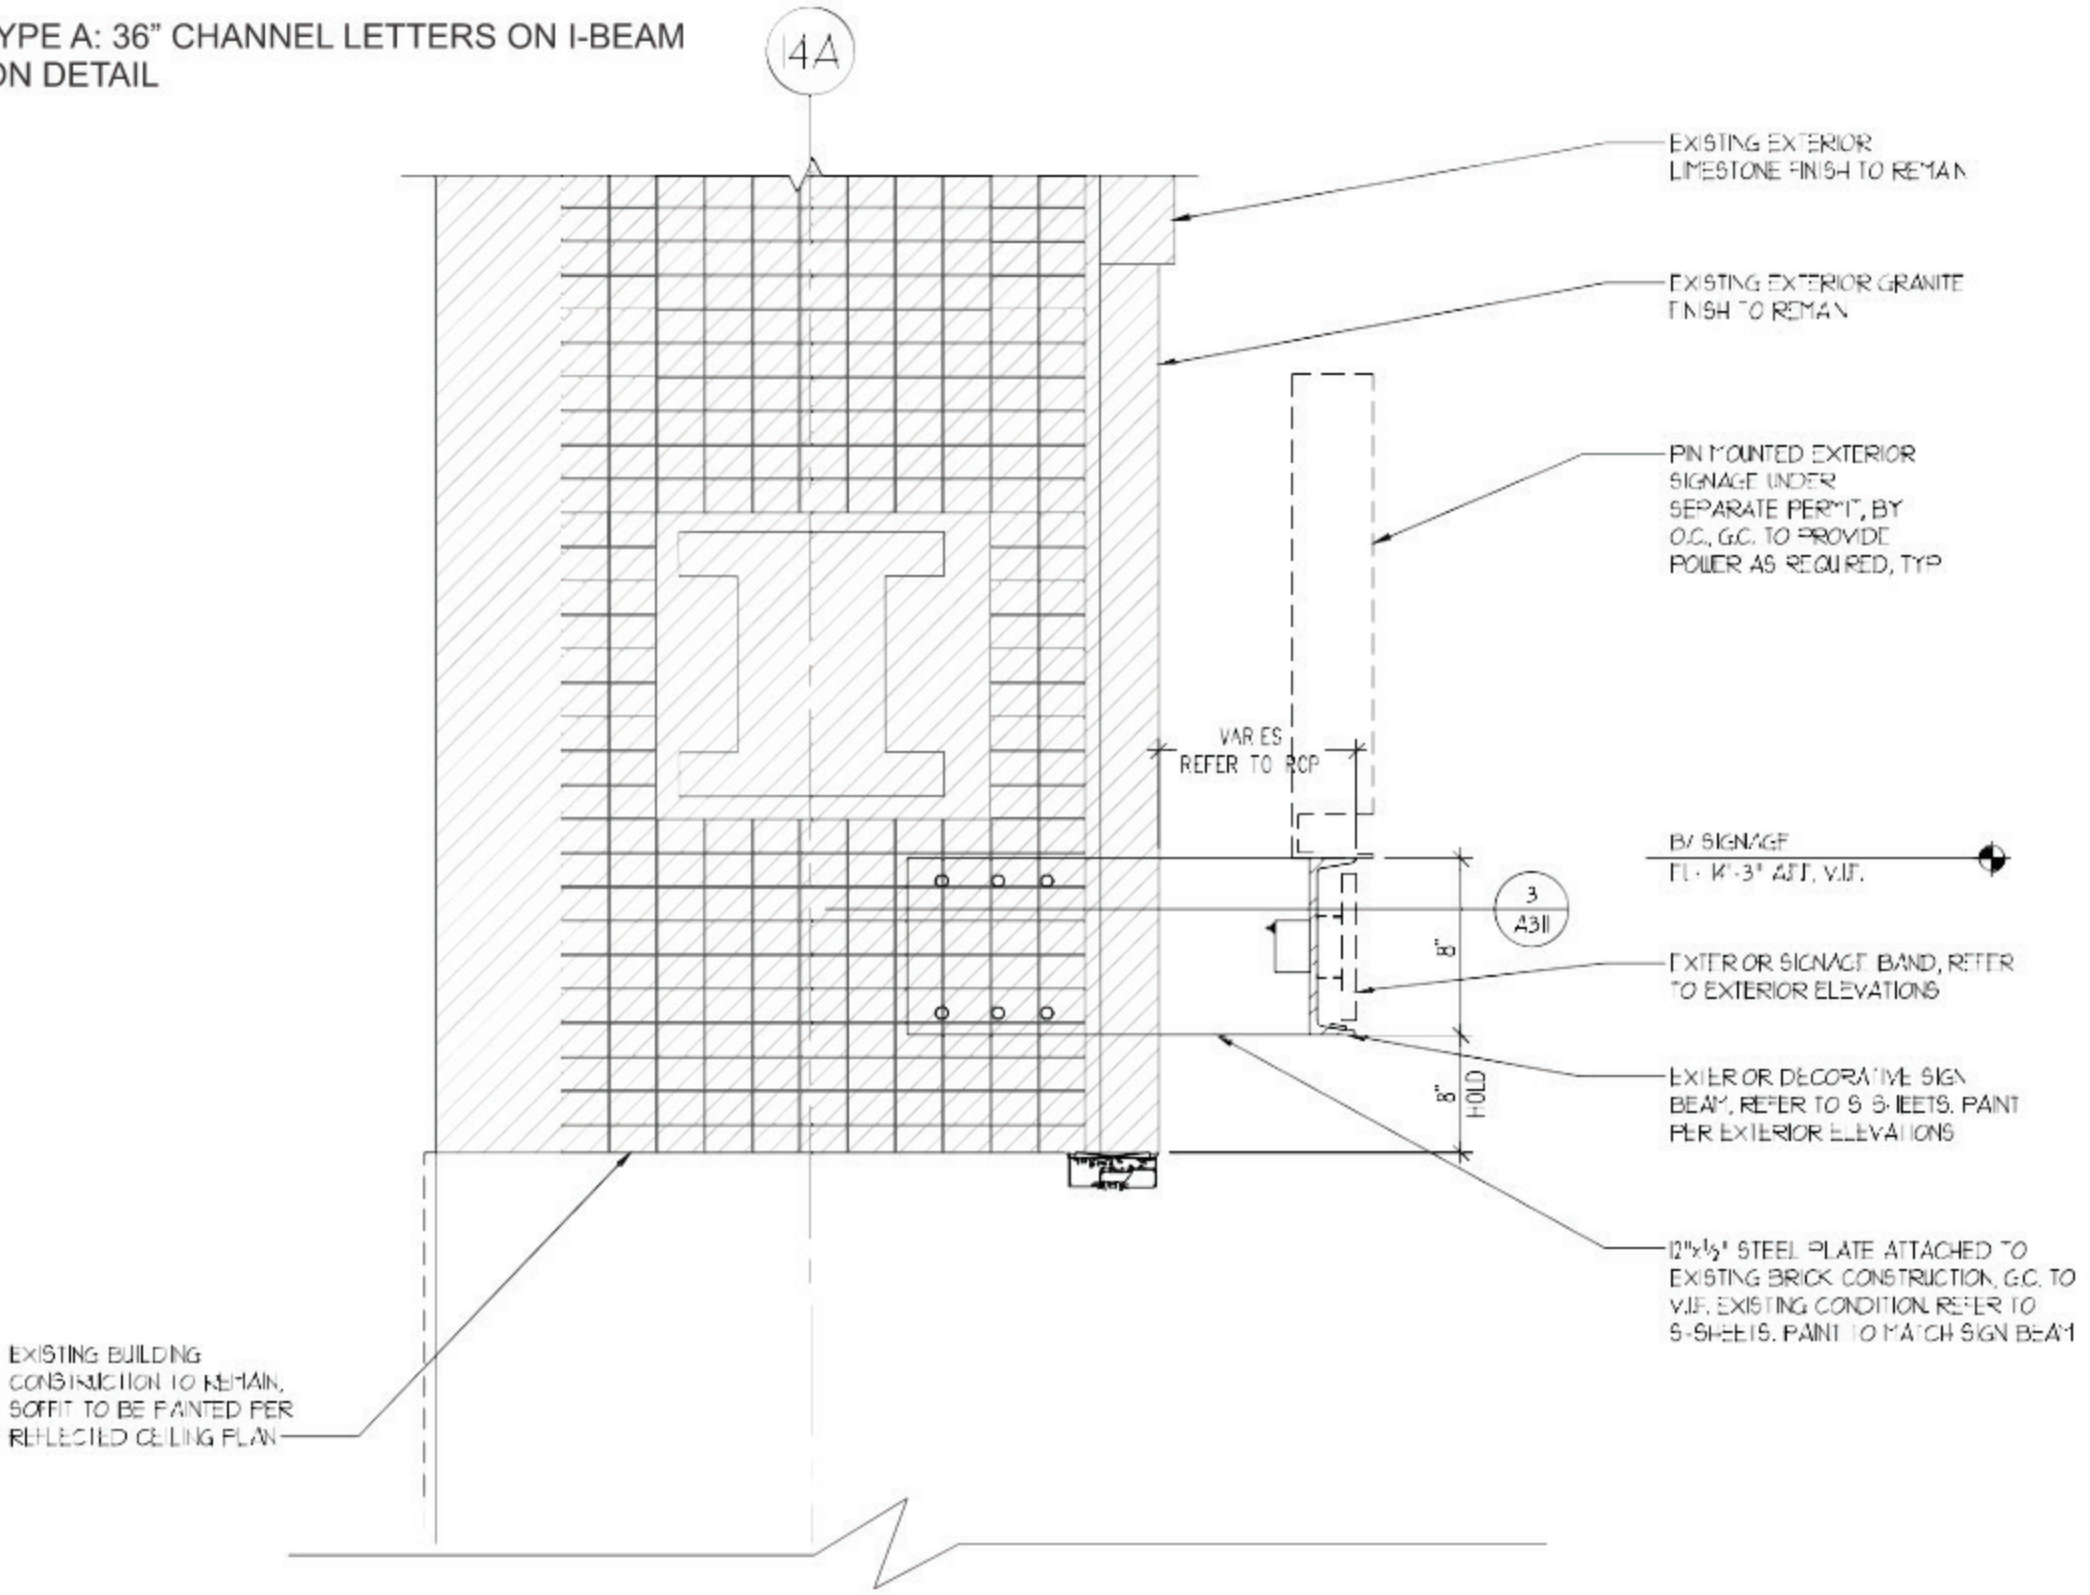


EXT STOREFRONT DOOR PRECEDENT @ FIRST NATIONAL BUILDING



HISTORIC CONDITIONS




HISTORIC GROUND FLOOR CLADDING IS LIMESTONE. EXIST GRANITE FACING ON GROUND FLOOR IS NON-HISTORIC

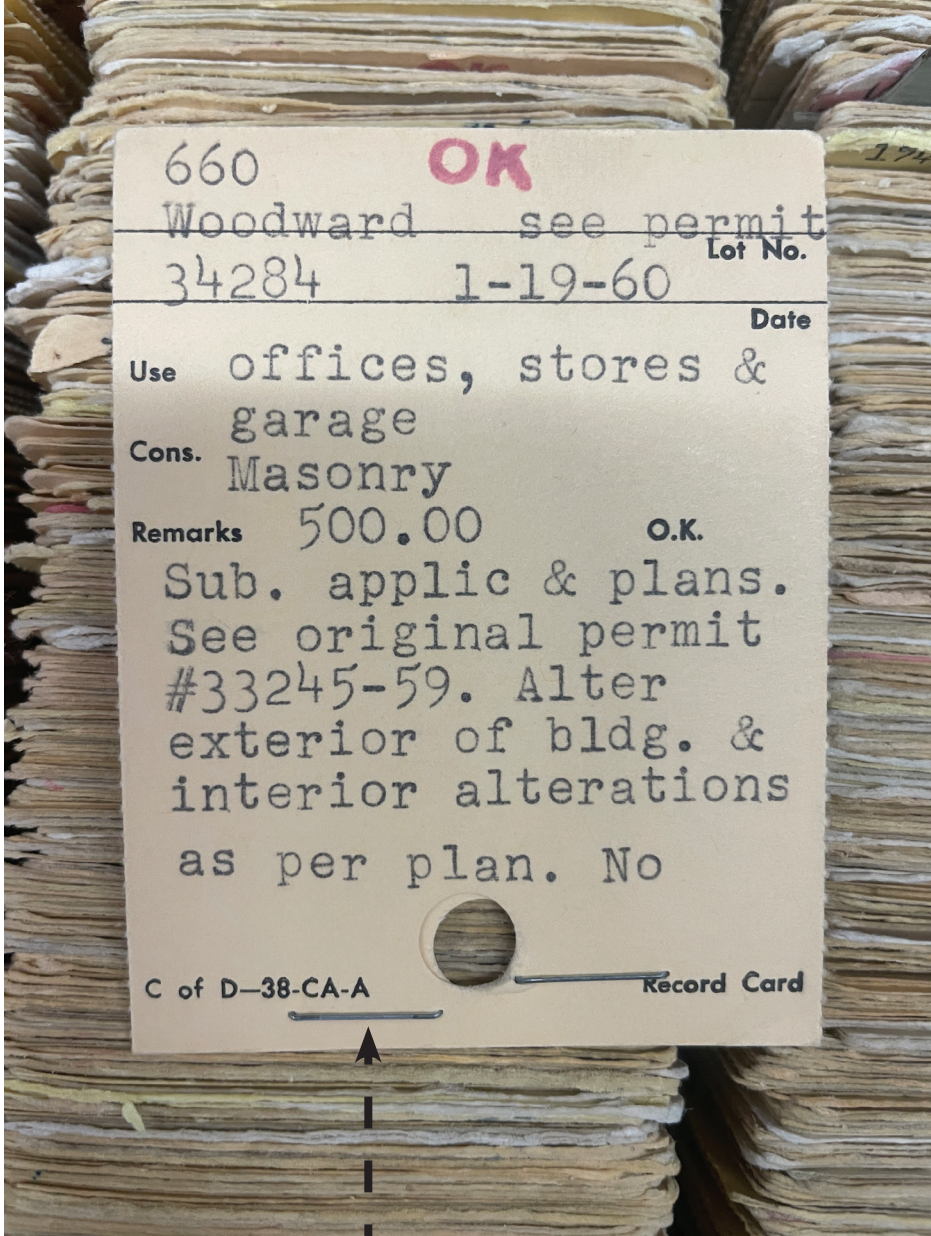

GROUND FLOOR GRANITE CLADDING LIKELY ADDED IN 1960 PER BUILDING PERMIT RECORDS (BSEED)

HISTORIC CONDITIONS

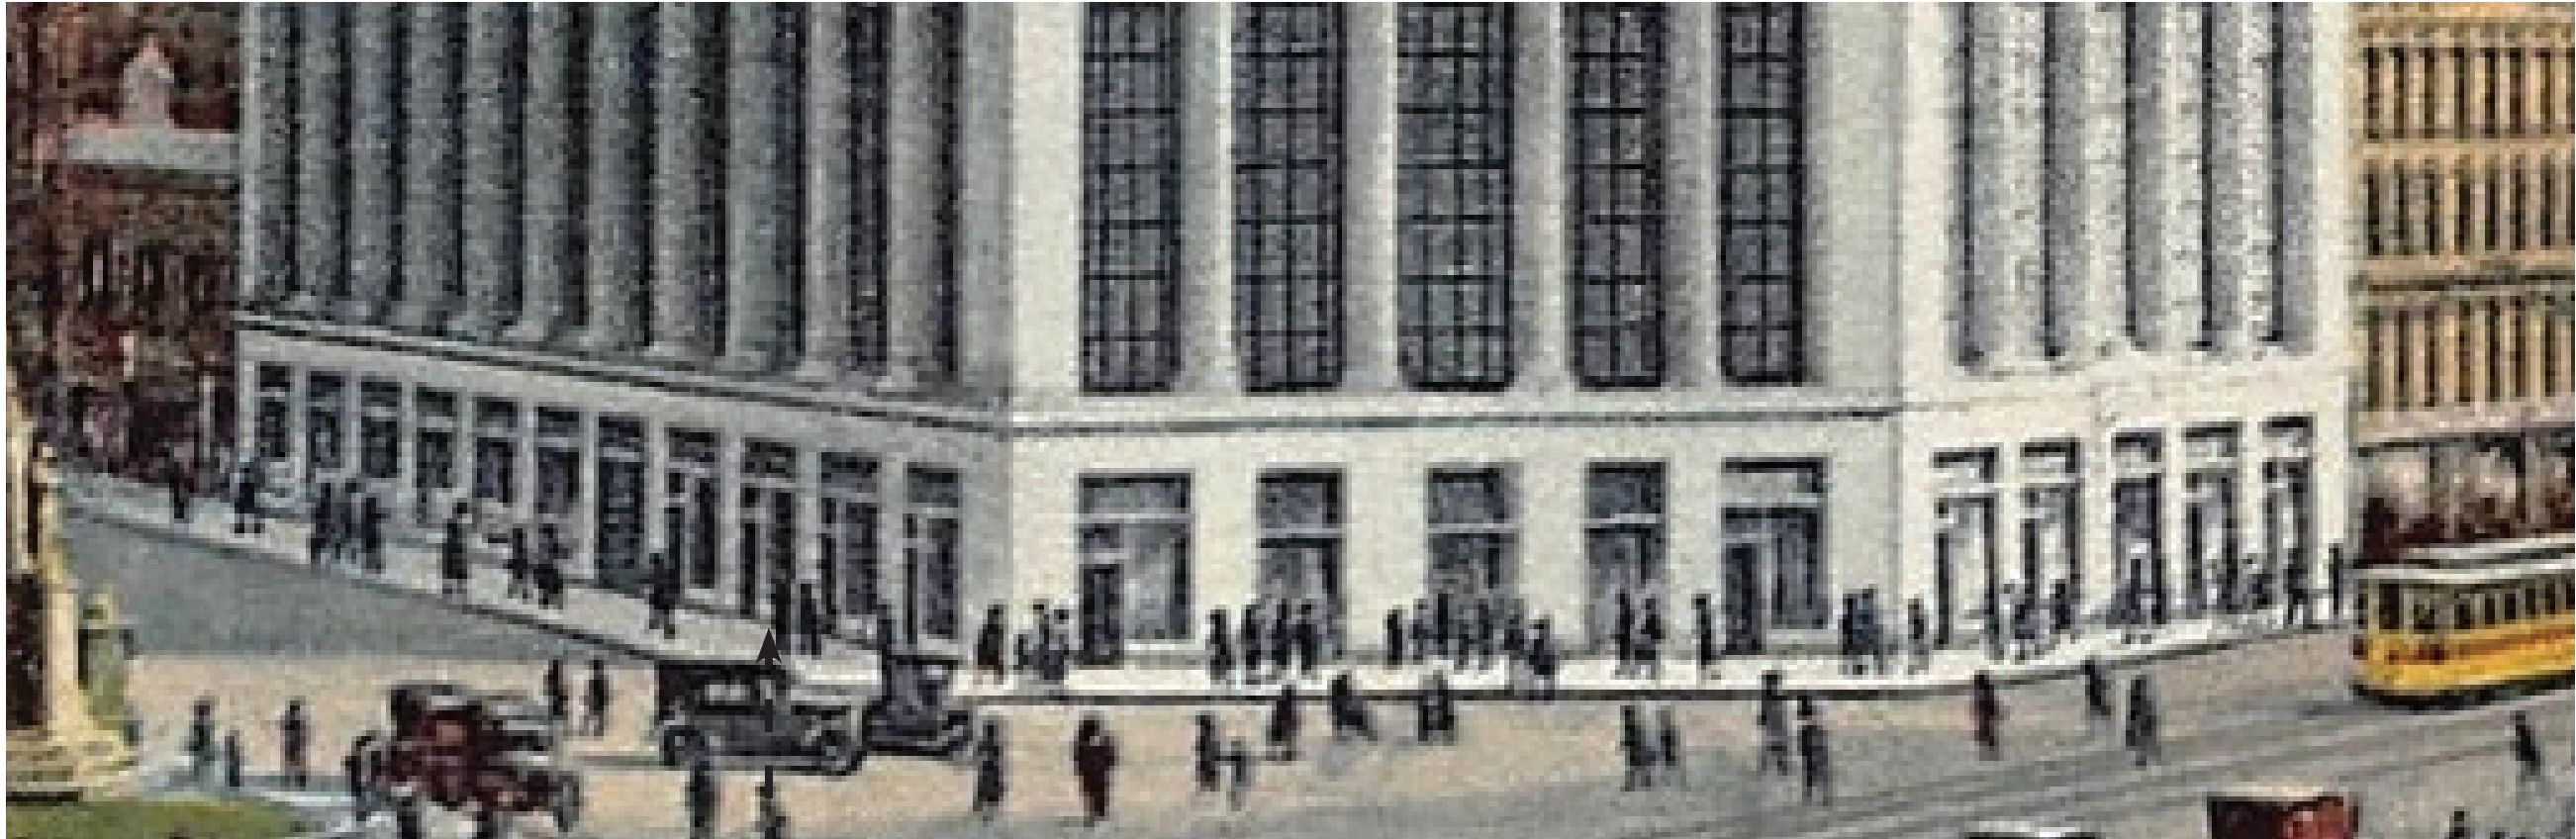

UNDATED POSTCARD


PRECEDENT OF STOREFRONT
DOORS IN VARIOUS BAYS ON THE
GROUND FLOOR

APPENDIX: ADDITIONAL ARCHITECTURAL DRAWINGS



Chick-fil-A
 5200 Buffington Road
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CHICK-FIL-A
FIRST NATIONAL BANK BUILDING
 660 WOODWARD AVE
 SUITE 7
 DETROIT, MI 48226

LCV#80819
 BUILDING TYPE / SIZE: LCV
 RELEASE: 23.02
 REVISION SCHEDULE

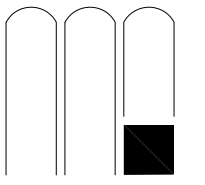SCHEMATIC DESIGN

CONSULTANT PROJECT #	23069
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DRAWN BY	Designer

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SHEET
EXTERIOR 3D
RENDERING

SHEET NUMBER
G-008

GENERAL NOTES: DEMOLITION

- PRIOR TO START OF CONSTRUCTION, GENERAL CONTRACTORS AND SUBCONTRACTORS SHALL VISIT THE SITE TO FIELD VERIFY EXISTING CONDITIONS WITH RESPECT TO THE CONSTRUCTION DOCUMENTS. EXISTING CONDITIONS INCLUDE BUT ARE NOT LIMITED TO LOCATIONS (DIMENSIONS BOTH VERTICALLY AND HORIZONTALLY), SIZES, AND CONSTRUCTION MAKE-UP OF:
 - STRUCTURAL COLUMNS AND JOISTS
 - DEMISING WALLS
 - ALL UTILITIES
 G.C. IS TO NOTIFY ARCHITECT AND PROJECT MANAGER IF ANY DIMENSIONS DO NOT MATCH THOSE SHOWN OR IF THERE ARE ANY DISCREPANCIES OR CONFLICTS WITH THE CONSTRUCTION DRAWINGS AS SOON AS POSSIBLE.
- ALL WORK SHALL BE IN COMPLIANCE WITH RECOGNIZED INDUSTRY STANDARDS, CRAFTSMANSHIP STANDARDS, MANUFACTURERS RECOMMENDATIONS AND ALL OTHER APPLICABLE CODES. THE ARCHITECT DOES NOT GUARANTEE THE PERFORMANCE OF THE PROJECT IN ANY RESPECT OTHER THAN THAT OUR ARCHITECTURAL WORK AND JUDGMENT RENDERED MEET THE STANDARDS OF CARE OF OUR PROFESSION.
- THE CONTRACTOR SHALL BE RESPONSIBLE FOR BUILDING THIS PROJECT IN ACCORDANCE WITH THE DRAWINGS AND SPECIFICATIONS UNLESS A WRITTEN NOTIFICATION FROM THE OWNER OR ARCHITECT TO THE CONTRARY IS RECEIVED. IT SHALL BE THE RESPONSIBILITY OF SUBCONTRACTOR/TRADE TO COORDINATE WITH THE OTHER SUBCONTRACTORS/TRADES. FAILURE TO DO SO, WILL NOT CONSTITUTE GROUNDS FOR A CHANGE ORDER.
- GENERAL CONTRACTOR TO PATCH AND REPAIR TO "LIKE NEW" ANY AREA THAT IS DISTURBED DURING DEMOLITION AND CONSTRUCTION.
- AS NECESSARY, THE CONTRACTOR SHALL PROVIDE ADEQUATE BRACING AND SHORING FOR ALL WORK DURING THE CONSTRUCTION PERIOD.
- COORDINATE REUSE, RELOCATION, OR DISPOSAL OF EXISTING EQUIPMENT WITH PROJECT AND FACILITIES MANAGERS AND KITCHEN SHEETS. WHERE EQUIPMENT IS TO BE RELOCATED OR REUSED, EQUIPMENT IS TO BE CLEANED TO "LIKE NEW" CONDITION AND STORED UNTIL REINSTALLATION.
- ALL MATERIALS ARE TO BE NEW UNLESS OTHERWISE NOTED.
- PROVIDE SEPARATION BETWEEN ALL DISSIMILAR METALS INCLUDING SCREWS, NAILS AND OTHER FASTENING DEVICES.
- WHERE MATERIAL FASTENERS ARE NOT INDICATED, PROVIDE AS SPECIFIED BY THE MATERIAL MANUFACTURER'S RECOMMENDATIONS AND PROCEDURES.

GENERAL NOTES: DEMOLITION


- COORDINATE ALL DEMOLITION WITH FACILITIES MANAGEMENT
- ALL DEMOLITION WORK TO COMPLY WITH CONSTRUCTION PROCEDURES AND REGULATIONS AS SET FORTH BY LOCATION IN WHICH WORK IS BEING DONE.
- COVER RETURN AIR DUCTS AS NECESSARY BEFORE AND DURING CONSTRUCTION.
- DO NOT ABANDON ANY UTILITIES WITHIN SPACE. REMOVE ALL UTILITIES CONNECTED TO ITEMS TO BE DEMOLISHED UNLESS OTHERWISE NOTED. COORDINATE WITH FIELD CONDITIONS AND PROJECT AND FACILITY MANAGERS. CAP AND SEAL OFF ANY PLUMBING PENETRATIONS AS NECESSARY. DO NOT ABANDON ANY UTILITIES OR MATERIALS WITHIN SPACE. REMOVE BACK TO THE SOURCE.
- GENERAL CONTRACTOR TO DISPOSE OF ALL CONSTRUCTION DEBRIS OR EQUIPMENT IN A MANNER APPROVED BY THE LOCAL JURISDICTION.
- GENERAL CONTRACTOR TO REMOVE AND/OR RELOCATE ANY FIRE EQUIPMENT AS NECESSARY TO SATISFY LOCAL JURISDICTION FOR LENGTH OF DEMOLITION AND CONSTRUCTION PROCESS.
- ALL EXISTING EQUIPMENT TO BE REMOVED DURING DEMOLITION. EQUIPMENT NUMBERED IS INTENDED FOR REUSE. STORE DURING DEMOLITION AND CONSTRUCTION; CLEAN TO "LIKE NEW" CONDITION.
- ALL EXISTING LIGHTING TO BE REUSED. REMOVE DURING DEMOLITION; REPLACE IN NEW LOCATION DURING CONSTRUCTION.
- ALL HVAC DIFFUSERS TO BE REUSED. REMOVE DURING DEMOLITION; REPLACE IN NEW LOCATION DURING CONSTRUCTION.
- ALL EXISTING FLOOR DRAINS AND SINKS TO REMAIN UNLESS NOTED OTHERWISE.
- ALL EXISTING CEILING GRID, TILE AND SOFFITS TO BE REMOVED UNLESS NOTED OTHERWISE.
- ALL SPRINKLER MAINS TO REMAIN UNLESS NOTED OTHERWISE. SPRINKLER HEADS TO BE RELOCATED AS NECESSARY TO ACCOMMODATE NEW HEIGHT.

DEMO PLAN LEGEND

- NOTE:
G.C. TO VERIFY WALL LOCATIONS AND CONSTRUCTION TYPES PRIOR TO START OF CONSTRUCTION; NOTIFY ARCHITECT, PROJECT MANAGER AND FACILITIES MANAGER OF ANY DISCREPANCIES
- EXISTING WALL AND FINISH TO REMAIN
 - DEMOLISH WALL AND FINISHES

D-201 - KEY NOTES - DEMOLITION PLAN

MARK	NOTES
1	EXISTING WALL SYSTEM TO REMAIN. PROTECT DURING DEMOLITION AND CONSTRUCTION. PATCH/REPAIR AS REQUIRED TO BRING TO "LIKE NEW" CONDITION.
2	EXISTING WALL SYSTEM TO REMAIN. MODIFY AS NECESSARY TO PROVIDE FOR NEW UTILITIES AND BLOCKING. COORDINATE WITH DETAIL S AND KITCHEN SHEETS. PATCH/REPAIR AS REQUIRED BRING TO "LIKE NEW" CONDITION.
3	EXISTING COLUMN TO REMAIN. PROTECT DURING CONSTRUCTION. G.C. TO VERIFY SIZE AND LOCATION PRIOR TO START OF CONSTRUCTION. NOTIFY ARCHITECT AND PROJECT AND FACILITIES MANAGERS OF ANY DISCREPANCIES.
4	REMOVE EXISTING DOOR. EXISTING FRAME TO REMAIN. G.C. TO PROTECT DURING CONSTRUCTION.
5	EXISTING WALL TO BE REMOVED TO EXTENTS SHOWN. PREP FLOOR BELOW FOR NEW FINISH.
6	EXISTING AIR DUCTS TO REMAIN. PROTECT DURING DEMOLITION AND CONSTRUCTION.
7	G.C. TO ENSURE THAT FLOOR IS SEAMLESS AND CONTINUOUS PREPARE FOR NEW FLOOR FINISH.
8	EXISTING GLAZING TO REMAIN. G.C. TO PROVIDE DURING DEMOLITION AND CONSTRUCTION.
9	EXISTING GLAZING/STORE FRONT TO BE REMOVED. G.C. TO RETAIN ROUGH OPENING PREP FOR NEW DOUBLE STOREFRONT DOOR. INFILL WALL AS NEEDED FOR CONTINUOUS APPEARANCE.
10	EXISTING STAIRS TO BE REMOVED & INFILLED AS PART OF LANDLORD SCOPE OF WORK. NOT ON THIS PROJECT SCOPE OF WORK.
11	EXISTING MASONRY TO REMAIN

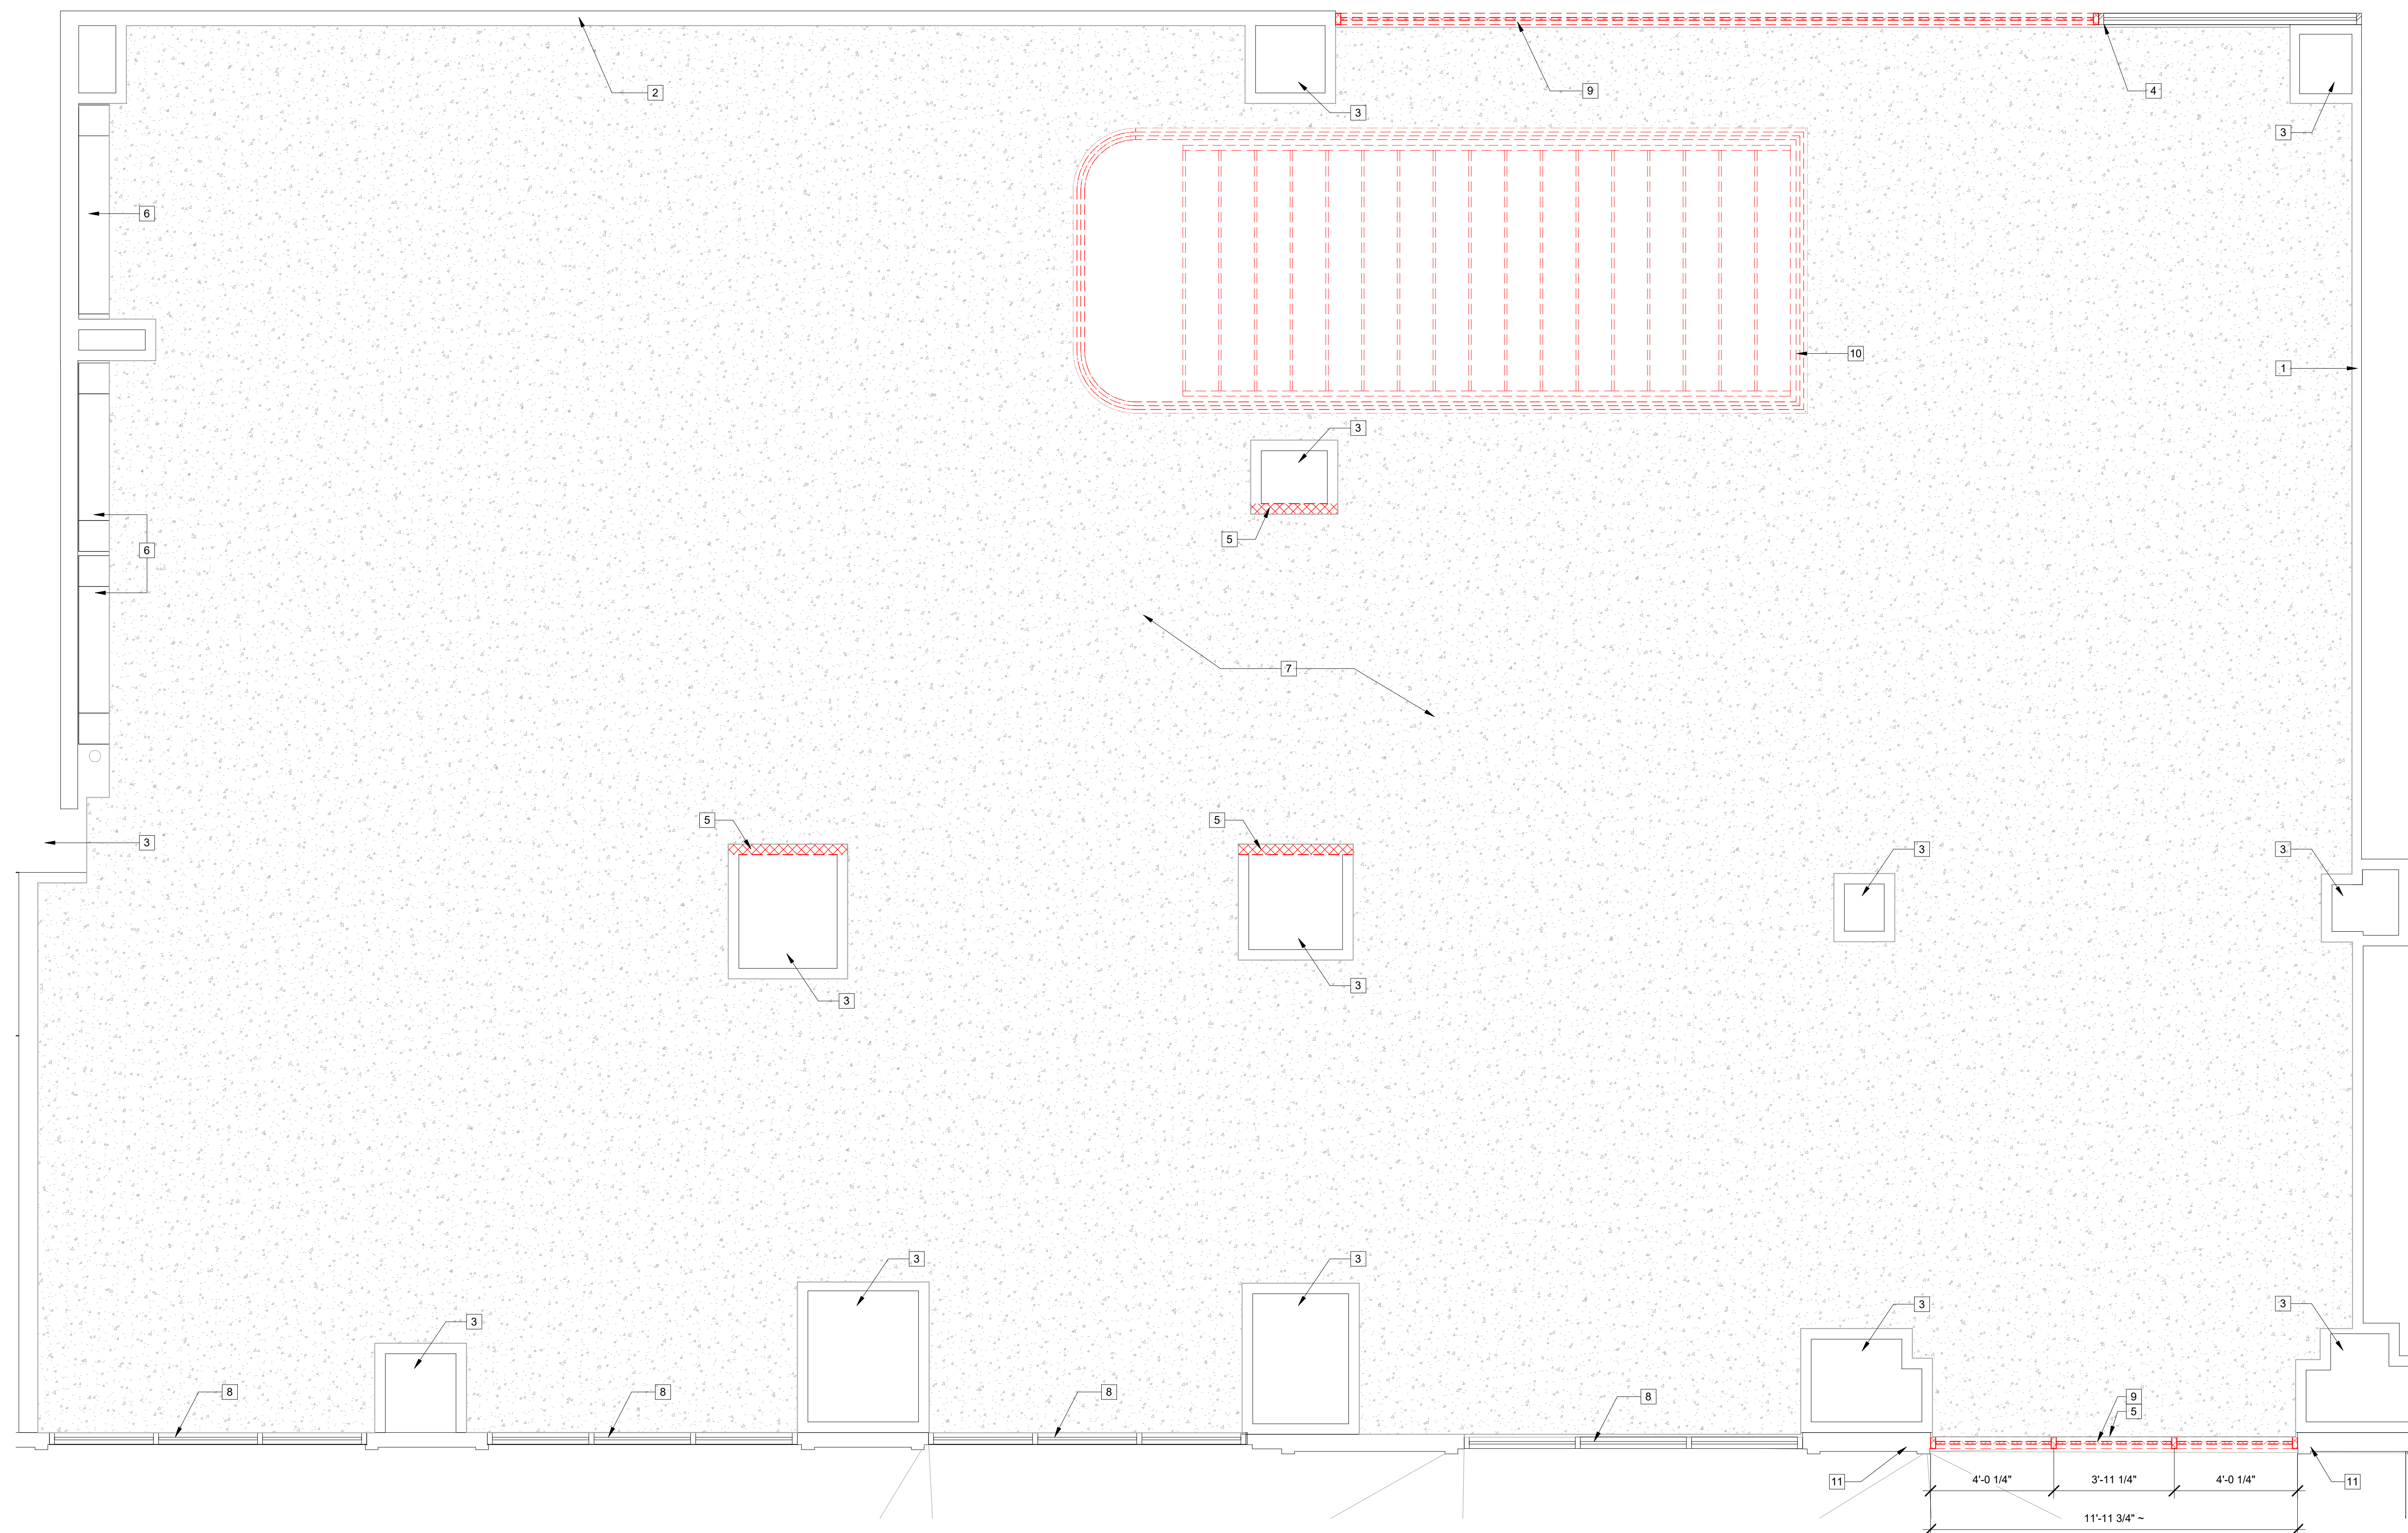

A4 DEMOLITION PLAN
3/8" = 1'-0"



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CHICK-FIL-A
FIRST NATIONAL BANK BUILDING
660 WOODWARD AVE
SUITE 7
DETROIT, MI 48226

LCV#80819
BUILDING TYPE / SIZE: LCV
RELEASE: 23.02

REVISION SCHEDULE

SCHEMATIC DESIGN


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DEMOLITION FLOOR PLAN


SHEET NUMBER
D-201

- GENERAL NOTES:**
1. PRIOR TO START OF CONSTRUCTION G.C. IS TO VERIFY THAT EXISTING CONDITIONS DO NOT IMPEDE UPON THE DESIGN INTENT OF THE PERMITTED CONSTRUCTION DOCUMENTS. IF THE EXISTING CONDITIONS DO NOT ALLOW FOR DESIGN INTENT TO BE EXECUTED, G.C. IS TO NOTIFY CHICK-FIL-A CONSTRUCTION MANAGER IMMEDIATELY AND ARCHITECT OF RECORD.
 3. G.C. TO REMOVE AND STORE ALL EQUIPMENT LOCATED IN THE AREAS OF REMODEL OR ANY AREA THAT WILL BE DIRECTLY IMPACTED BY DEMOLITION AND CONSTRUCTION. ALL OTHER ITEMS ARE TO BE PROTECTED DURING DEMOLITION AND CONSTRUCTION. COORDINATE STORAGE REQUIREMENTS WITH CHICK-FIL-A CONSTRUCTION MANAGER.
 4. DEMOLITION WORK SHALL INCLUDE ANY AND ALL WORK REQUIRED TO ACCOMPLISH THE WORK SHOWN OR REQUIRED BY THESE DOCUMENTS.
 5. G.C. IS TO DISPOSE OF ALL CONSTRUCTION DEBRIS OR EQUIPMENT IN A MANNER APPROVED BY THE LOCAL JURISDICTION.
 7. G.C. TO REUSE AND RELOCATE EXISTING LIGHTING TO MATCH NEW KITCHEN LAYOUT. RE: TO E201 LIGHTING PLAN.
 9. PATCH EXISTING DRAFTSTOP WALL BETWEEN KITCHEN AND SERVICE AT NEW BEVERAGE CHASES.
 13. WORK AREA SHALL BE CLEAN AT ALL TIMES AND DEBRIS SHALL BE REMOVED IMMEDIATELY.



D-202 - KEY NOTES - DEMO RCP

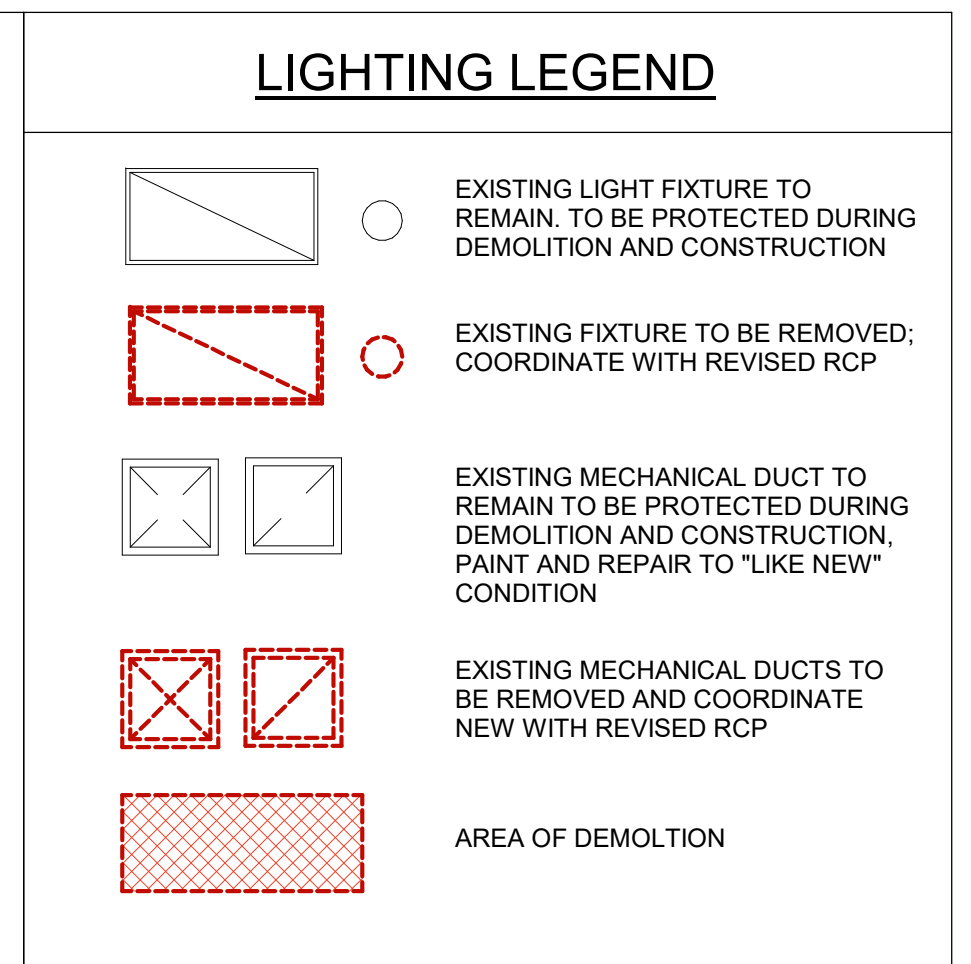MARK	NOTES
1	EXISTING DUCT PIPES TO REMAIN. PROTECT DURING DEMO AND CONSTRUCTION. G.C. TO CLEAN TO "LIKE NEW" CONDITION.
2	EXISTING HISTORIC COPPER CEILING TO REMAIN. G.C. TO PROTECT DURING DEMO AND CONSTRUCTION.
3	EXISTING BULKHEAD TO REMAIN PREP FOR FRESH COAT OF PAINT TO MATCH EXISTING. G.C. TO PROTECT DURING DEMO AND CONSTRUCTION.
4	DEMO BULKHEAD AS NEEDED FOR NEW HOOD AND KITCHEN EQUIPMENT
5	EXISTING RECESSED CAN LIGHTS TO REMAIN. G.C. TO ENSURE LED IS IN WORKING CONDITION. PROTECT DURING DEMOLITION AND CONSTRUCTION
6	PATCH AND REPAIR EXISTING BULKHEAD. ENSURE THAT ALL GAPS ARE SEALED TO MATCH NEW BULKHEAD FINISH RE: FLOOR FINISH PLAN
7	REMOVE EXISTING CAN LIGHTS. INFILL AND REPAIR BULKHEAD TO "LIKE NEW" CONDITION
8	DEMO BULKHEAD AS NEEDED FOR NEW VESTIBULE

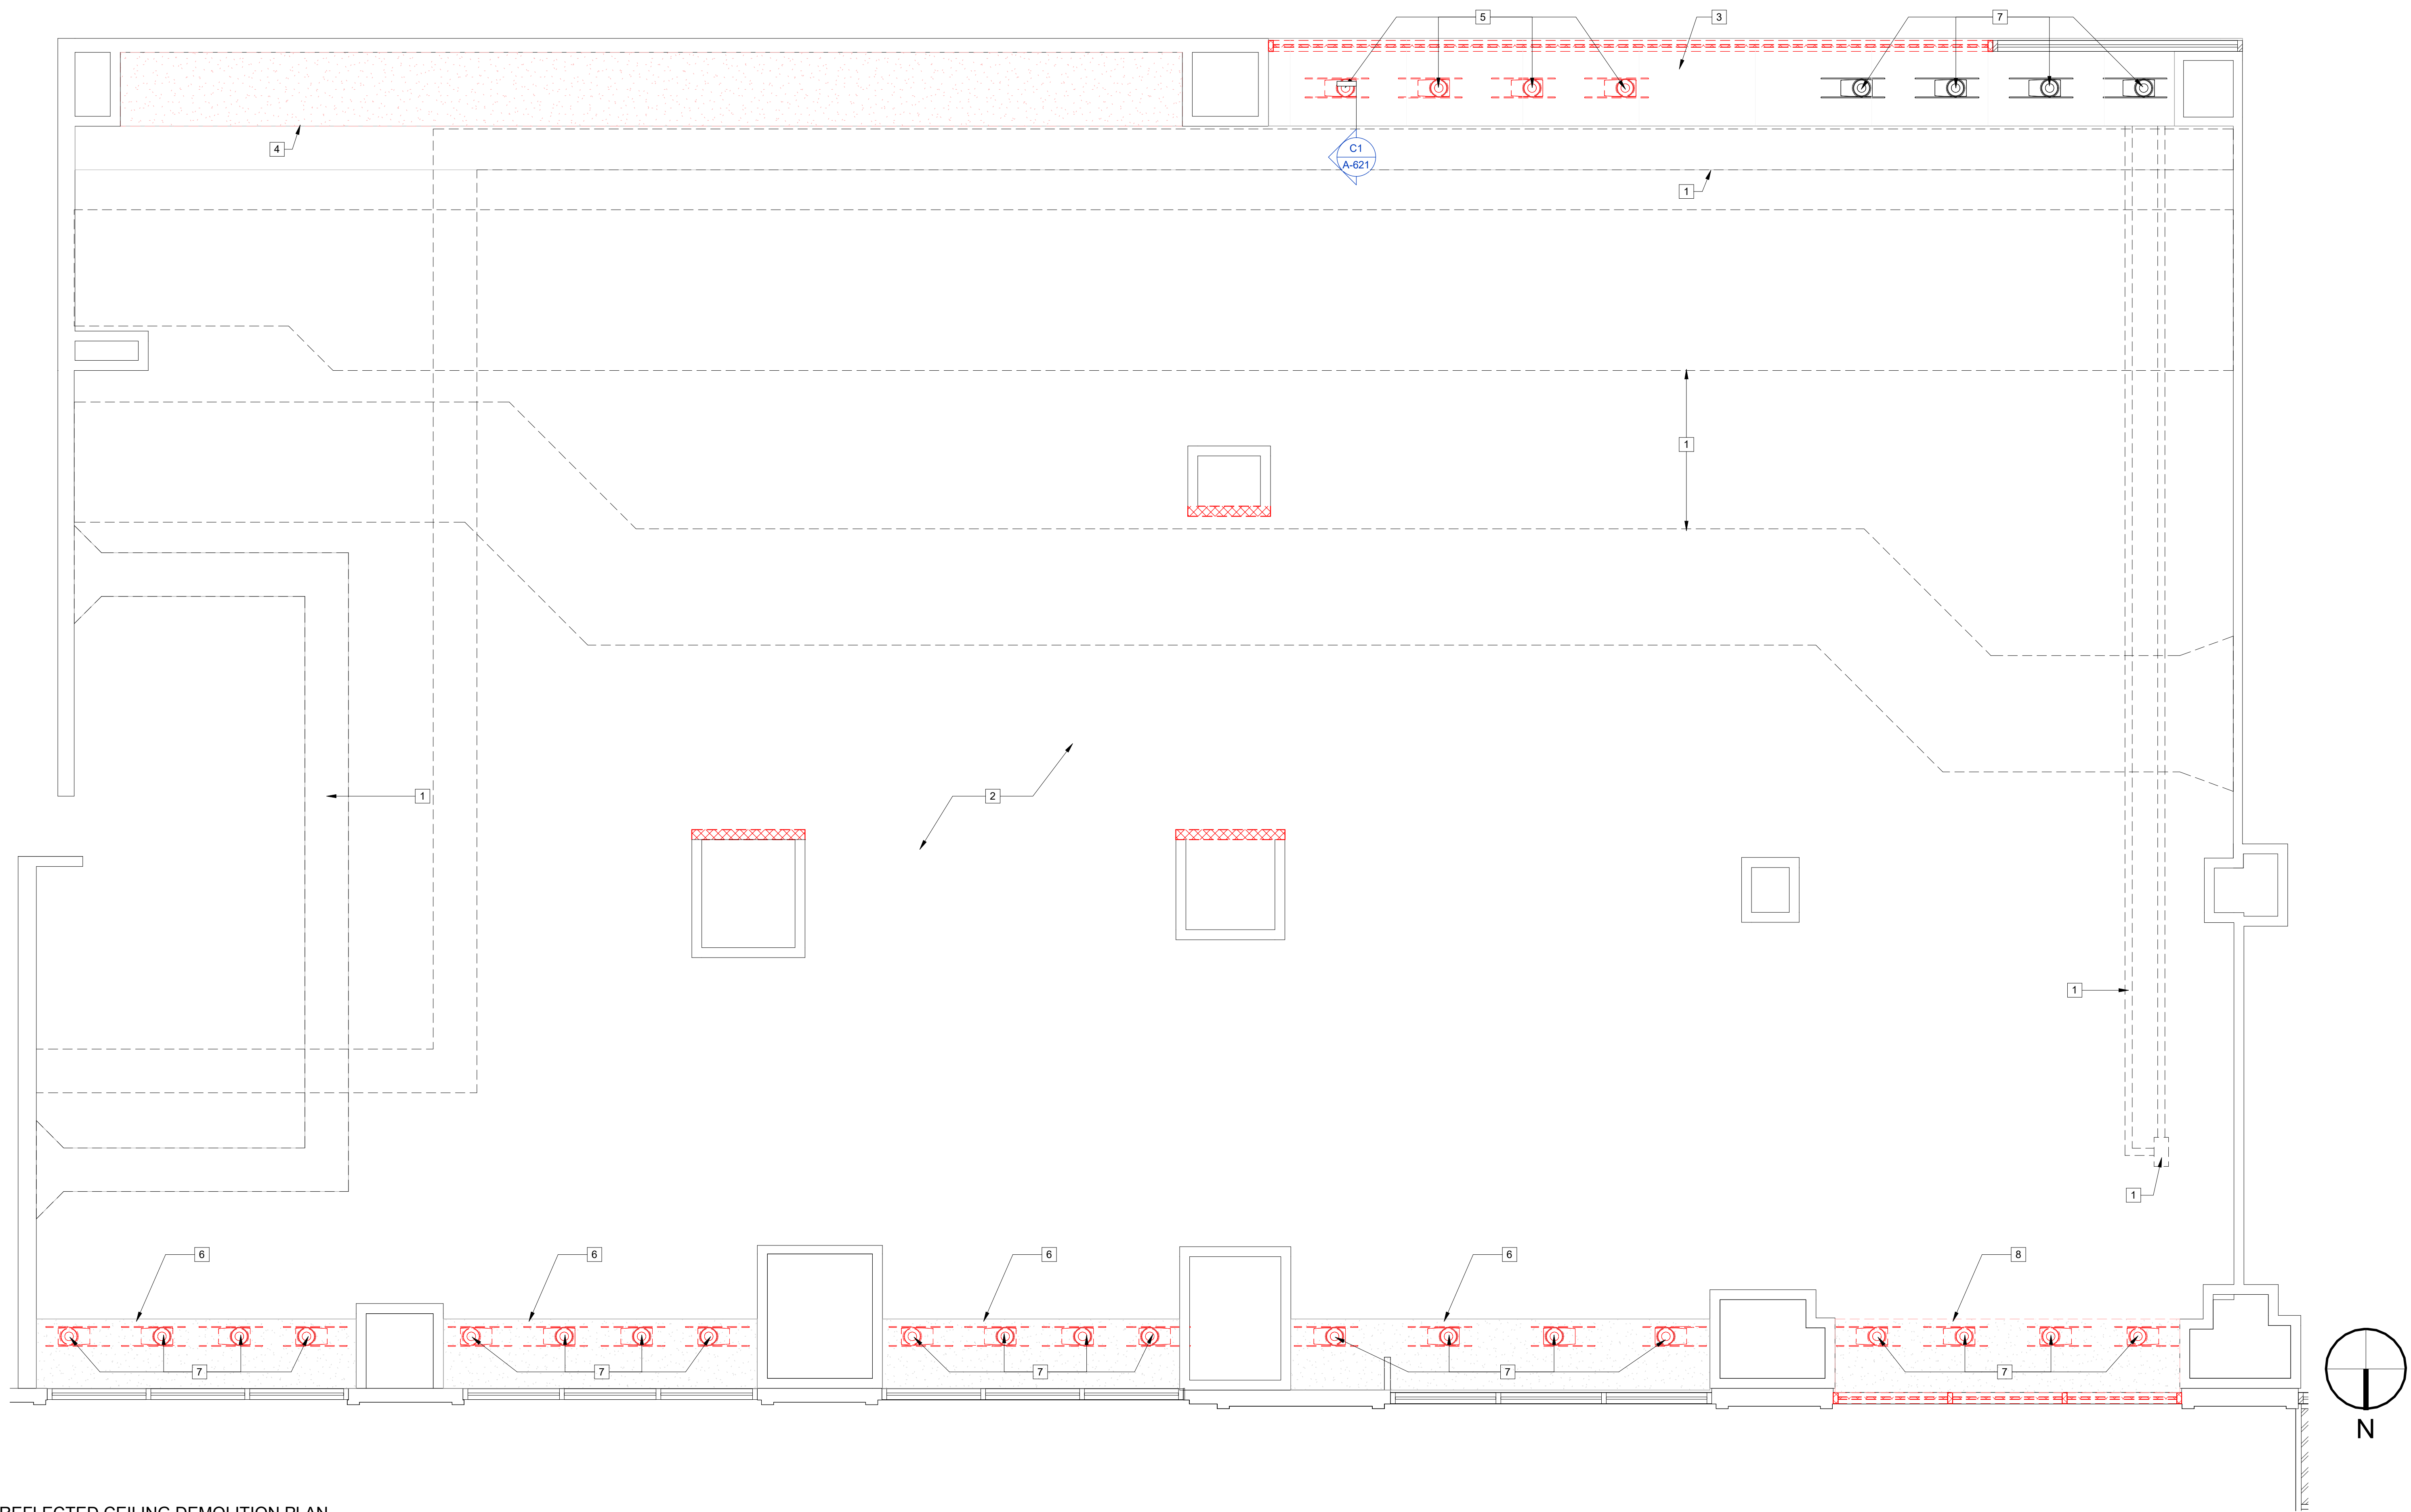

A4 REFLECTED CEILING DEMOLITION PLAN
3/8" = 1'-0"



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FIRST NATIONAL BANK BUILDING
660 WOODWARD AVE
SUITE 7
DETROIT, MI 48226

LCV#80819
BUILDING TYPE / SIZE: LCV
RELEASE: 23.02
REVISION SCHEDULE

SCHEMATIC DESIGN

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DEMOLITION REFLECTED CEILING PLAN

SHEET NUMBER
D-221

Autodesk Docs://M1_00000_First National Bank Building_2023_5_SAT000000_First National Bank Building_ARC.rvt
5/31/2024 4:55:12 PM
80819-D-221-DEMOLITION REFLECTED CEILING PLAN


CONSTRUCTION NOTES: FLOOR PLAN

1. PROVIDE TEMPORARY BARRICADE DURING CONSTRUCTION AS NECESSARY BY LOCAL ORDINANCES; COORDINATE WITH PROJECT AND FACILITIES MANAGERS.
2. SOFFITS AND SUSPENDED CEILINGS SHALL BE SECURED TO STRUCTURAL FRAMING ONLY; SEE DETAILS.
3. ALL MECHANICAL DEVICES (TIME CLOCKS, GRILLE LOCKS, CONTROLS, ETC.) SHALL BE CONCEALED WITHIN STOREFRONT CONSTRUCTION. ELECTRONIC SURVEILLANCE OR THEFT DETECTION DEVICES SHALL NOT BE VISIBLE. ANY APPROVED SYSTEMS MUST BE COMPLETELY INCORPORATED INTO STOREFRONT DESIGN. COVER PLATES AND SWITCHES FOR GRILLE EMERGENCY RELEASE (WHERE REQUIRED BY CODE TO BE ACCESSIBLE) MUST BE FINISHED TO MATCH ADJACENT SURFACE AND EMPLOY CONCEALED HARDWARE ONLY.
4. PROVIDE WATERPROOF MEMBRANE AS REQUIRED BY GOVERNING JURISDICTION AND ENTITY WITH CONTROL OVER PREMISES. EXTEND MINIMUM 12" UP WALLS. INSTALLATION OF WATERPROOFING MUST BE DONE PER GOVERNING ENTITIES SPECIFICATIONS; COORDINATE WITH GOVERNING ENTITY.
5. FLOOR DRAINS REQUIRED IN ALL KITCHENS, FOOD PREPARATION AREAS, ANY OTHER LOCATIONS WHERE WATER IS USED.
6. PROTECT AND MAINTAIN ACCESS TO ANY EXISTING HVAC, ELECTRICAL AND PLUMBING SYSTEMS INCLUDING, BUT NOT LIMITED TO, CLEANOUTS, VALVES, DAMPERS, JUNCTION BOXES, SMOKE DETECTORS, ETC.
7. ALL TRANSITIONS BETWEEN DISSIMILAR FLOOR MATERIALS MUST BE FLUSH AND LEVEL.

SHEET NOTES: FLOOR PLAN

1. ALL PERIMETER WALLS AND STRUCTURAL COLUMNS ARE ASSUMED. GENERAL CONTRACTOR TO FIELD VERIFY ALL LOCATIONS AND WALL CONSTRUCTION AND NOTIFY ARCHITECT AND PROJECT AND FACILITY MANAGERS OF ANY DISCREPANCIES AS SOON AS POSSIBLE.
2. DEMISING WALLS ARE NOT STRUCTURAL. PROVIDE ALL ADDITIONAL IN-WALL BLOCKING OR SUPPORT AS REQUIRED.
3. ALL FASTENERS, ANCHORS, CLIPS, STRAPS, ETC. WHICH ARE IN CONTACT WITH COPPER BASED TREATED WOOD AND ARE LESS THAN 3/8" THICK SHALL BE G85 COATED GALVANIZED, STAINLESS STEEL OR AN APPROVED EQUAL.
4. LIMITED COMBUSTIBLE CONSTRUCTION SHALL CONSIST OF METAL STUDS, 5/8" DURAROCK, 5/8" FIRE-RETARDANT CDX PLYWOOD AND STAINLESS STEEL.
5. ALL WOOD TO BE NON-COMBUSTIBLE TYPE ONLY (FIRE-RETARDANT TREATED); UNLESS NOTED OTHERWISE.
6. LIMITED COMBUSTION CONSTRUCTION SHALL BE USED WITHIN 18" BEHIND AND UNDER ALL HOODS.
7. SEE METAL STUD SCHEDULE ON G-001 FOR GAUGES OF METAL STUDS IF NOT OTHERWISE SPECIFIED.

PARTITION TYPE LEGEND

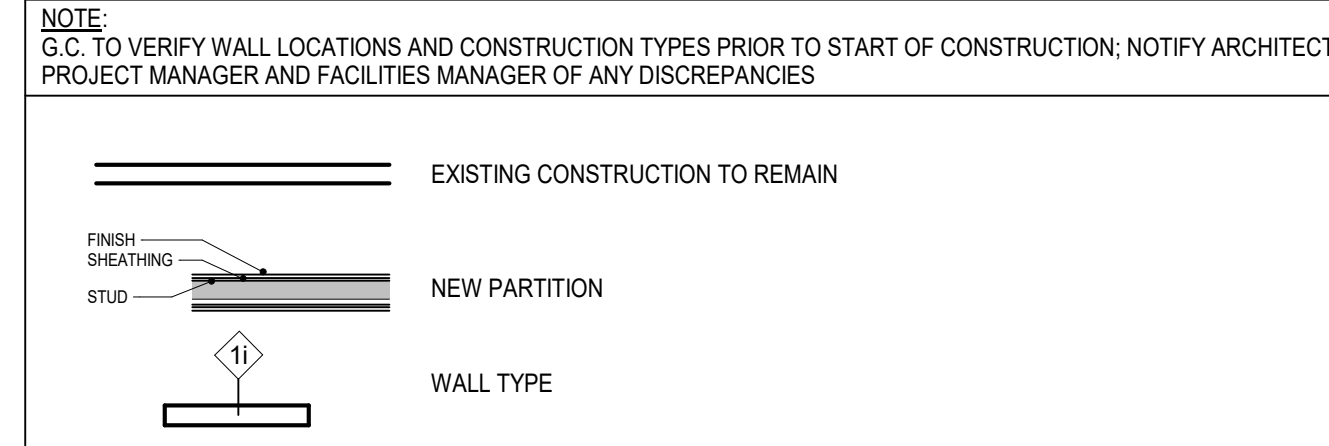

PARTITION SCHEDULE


MARK	TYPE DESCRIPTION
F3	F3 - 3-5/8" MTL STUD WITH (1) GWB ONE SIDE
P3	P3 - 3-5/8" MTL STUD WITH (1) GWB EACH SIDE
P6	P6 - 6" MTL STUD WITH (1) GWB EACH SIDE
P8	P8 - 8" MTL STUD WITH (1) GWB EACH SIDE

KEY NOTES - FLOOR PLAN

- | MARK | NOTES |
|------|--|
| 1 | EXISTING COLUMN TO REMAIN. PROTECT DURING CONSTRUCTION. G.C. TO VERIFY SIZE AND LOCATION PRIOR TO START OF CONSTRUCTION. NOTIFY ARCHITECT AND PROJECT AND FACILITIES MANAGERS OF ANY DISCREPANCIES. |
| 2 | ALIGN FACE OF NEW SHEATHING WITH FACE OF EXISTING SHEATHING. |
| 3 | LINE OF MILLWORK WITH SOLID SURFACE TOP. COORDINATE WITH MILLWORK SHOP DRAWINGS FOR FINAL INSTALLATION INSTRUCTIONS. |
| 4 | STAINLESS STEEL COUNTERTOP MILLWORK BY CLAYTON FIXTURE AS PART OF PASS-THRU CABINET FIXTURE; COORDINATE WITH EQUIPMENT CUT SHEET. |
| 5 | LINE OF PRESSURE TREATED CURB BELOW, CURBSC CONSTRUCTED BY G.C. AND INSTALLED DIRECTLY ON SLAB. COORDINATE FIELD CONDITIONS, AND MILLWORK MANUFACTURER SHOP DRAWINGS. CURBS ARE NOT FIRE-RETARDANT TREATED UNLESS REQUIRED BY AHJ; NOTIFY ARCHITECT FOR ADDITIONAL DETAILS IF REQUIRED BY AHJ. |
| 6 | LOCATION OF STAINLESS STEEL PANELS (S-1), COORDINATE WITH FINISH PLAN A-211 AND K-SHEET. PROVIDE 18" MIN AT EACH END WHERE WALL IS ADJACENT TO HOOD. |
| 7 | FREEZER FLOOR TO SIT DIRECTLY ON FLOORING; DO NOT PUNCTURE FLOORING OR WATERPROOFING DURING INSTALLATION. |

KEY NOTES - FLOOR PLAN

- | MARK | NOTES |
|------|---|
| 8 | G.C. TO ENSURE THAT FLOOR SINK IS HALF VISIBLE UNDER ICE MAKER. |
| 9 | KITCHEN EXHAUST HOOD ABOVE. COORDINATION WITH KITCHEN AND MECHANICAL SHEETS. G.C. TO SUBMIT SHOP DRAWINGS TO ARCHITECT FOR REVIEW. |
| 10 | (3) 6" PVC BEVERAGE CHASES, ROUTE FROM 6" BELOW CEILING AT BIG RACK, OVER CEILING AND THROUGH WALL TO MILLWORK AT CHICK-FIL-A FRONT COUNTER. |
| 11 | NEW ANSUL CABINET BOX. |
| 12 | SOFFIT ABOVE. COORDINATE WITH RCP ON A-221 AND DETAILS ON A-600 SHEETS. |
| 13 | CHICK-FIL-A LOW PROFILE SCRIPT SIGN. RE: INTERIOR ELEVATIONS & BRANDING PLAN. |
| 14 | CFA ICON SIGN. REF: INTERIOR ELEVATIONS. |
| 15 | PLUMBING FIXTURE. COORDINATE WITH KITCHEN AND PLUMBING SHEETS. |
| 16 | NEW WALK-IN COOLER. |
| 17 | NEW LOW STEEL WALL RE: FURNITURE. |
| 19 | SUSPENDED SIGN @ WINDOW. RE: F-101. |
| 20 | NEW SQUARE BLADE SIGN. |
| 21 | EXISTING COLUMN TO REMAIN. PROTECT DURING CONSTRUCTION. G.C. TO VERIFY SIZE AND LOCATION PRIOR TO START OF CONSTRUCTION. NOTIFY ARCHITECT AND PROJECT AND FACILITIES MANAGERS OF ANY DISCREPANCIES. |

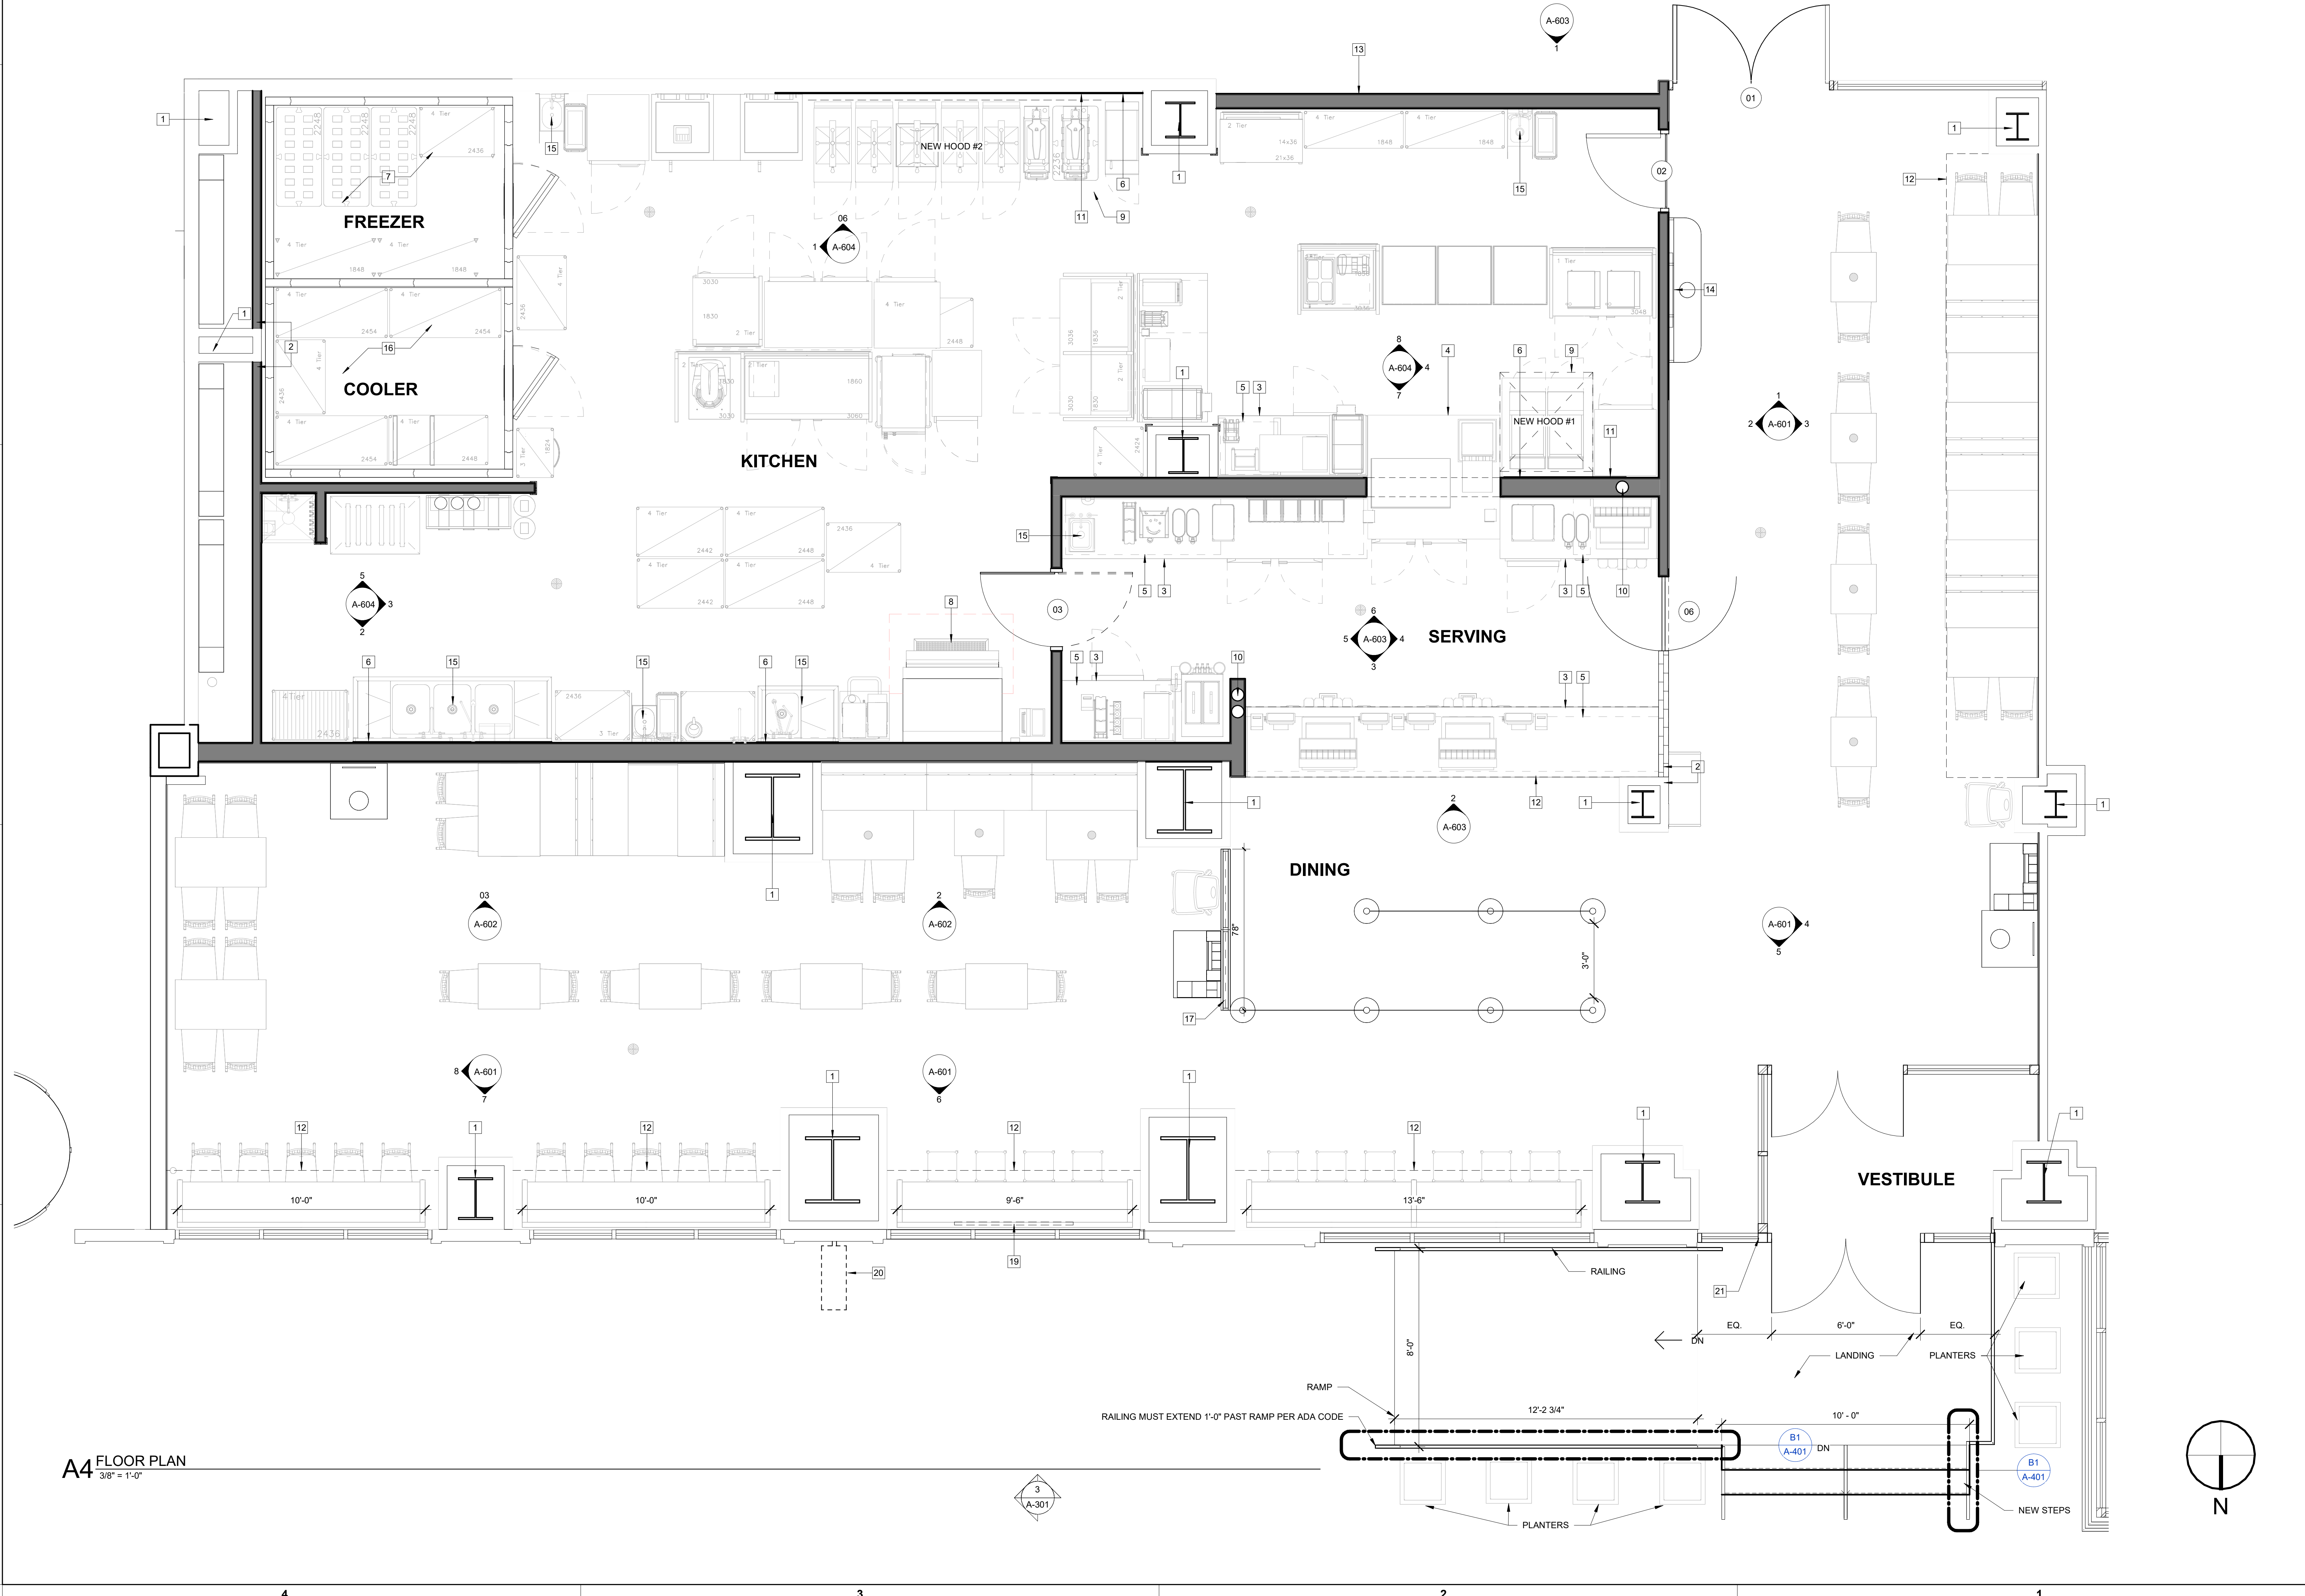

A4 FLOOR PLAN
3/8" = 1'-0"



Chick-fil-A

Chick-fil-A
5200 Buffington Road
Atlanta, Georgia
30349-2998

MAYSE & ASSOCIATES INC.
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Phone: (972) 386-0338 Fax: (972) 386-0276
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PROTOTYPICAL SET

NOT FOR
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CONSTRUCTION™

CHICK-FIL-A
FIRST NATIONAL BANK BUILDING
660 WOODWARD AVE
SUITE 7
DETROIT, MI 48226

LCV#80819
BUILDING TYPE / SIZE: LCV
RELEASE: 23.02
REVISION SCHEDULE

SCHEMATIC DESIGN

CONSULTANT PROJECT # 23069
PRINTED FOR SCHEMATIC DESIGN
DATE 5/31/2024 4:55:02 PM
DRAWN BY BV

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FLOOR PLAN


SHEET NUMBER
A-201

Autodesk Docs://MIL_000000_First National Bank Building_2023_5_SAT000000_First National Bank Building_ARC.rvt
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80819-A-201-FLOOR PLAN



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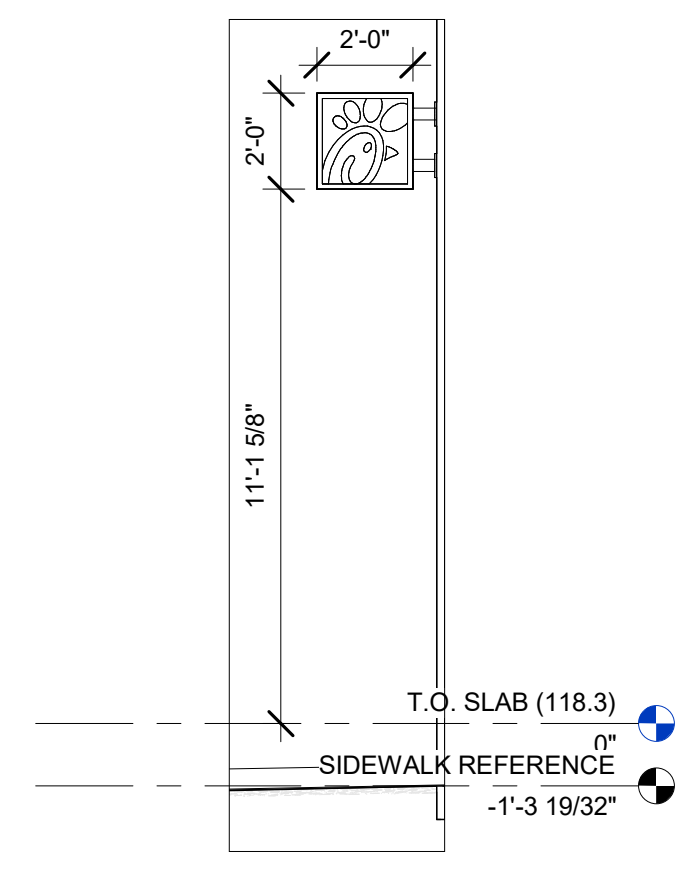
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SHEET EXTERIOR ELEVATIONS


SHEET NUMBER

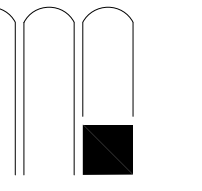A-301



1 EXTERIOR ELEVATION
 1/4" = 1'-0"


2 EXTERIOR BLADE SIGN
 1/4" = 1'-0"

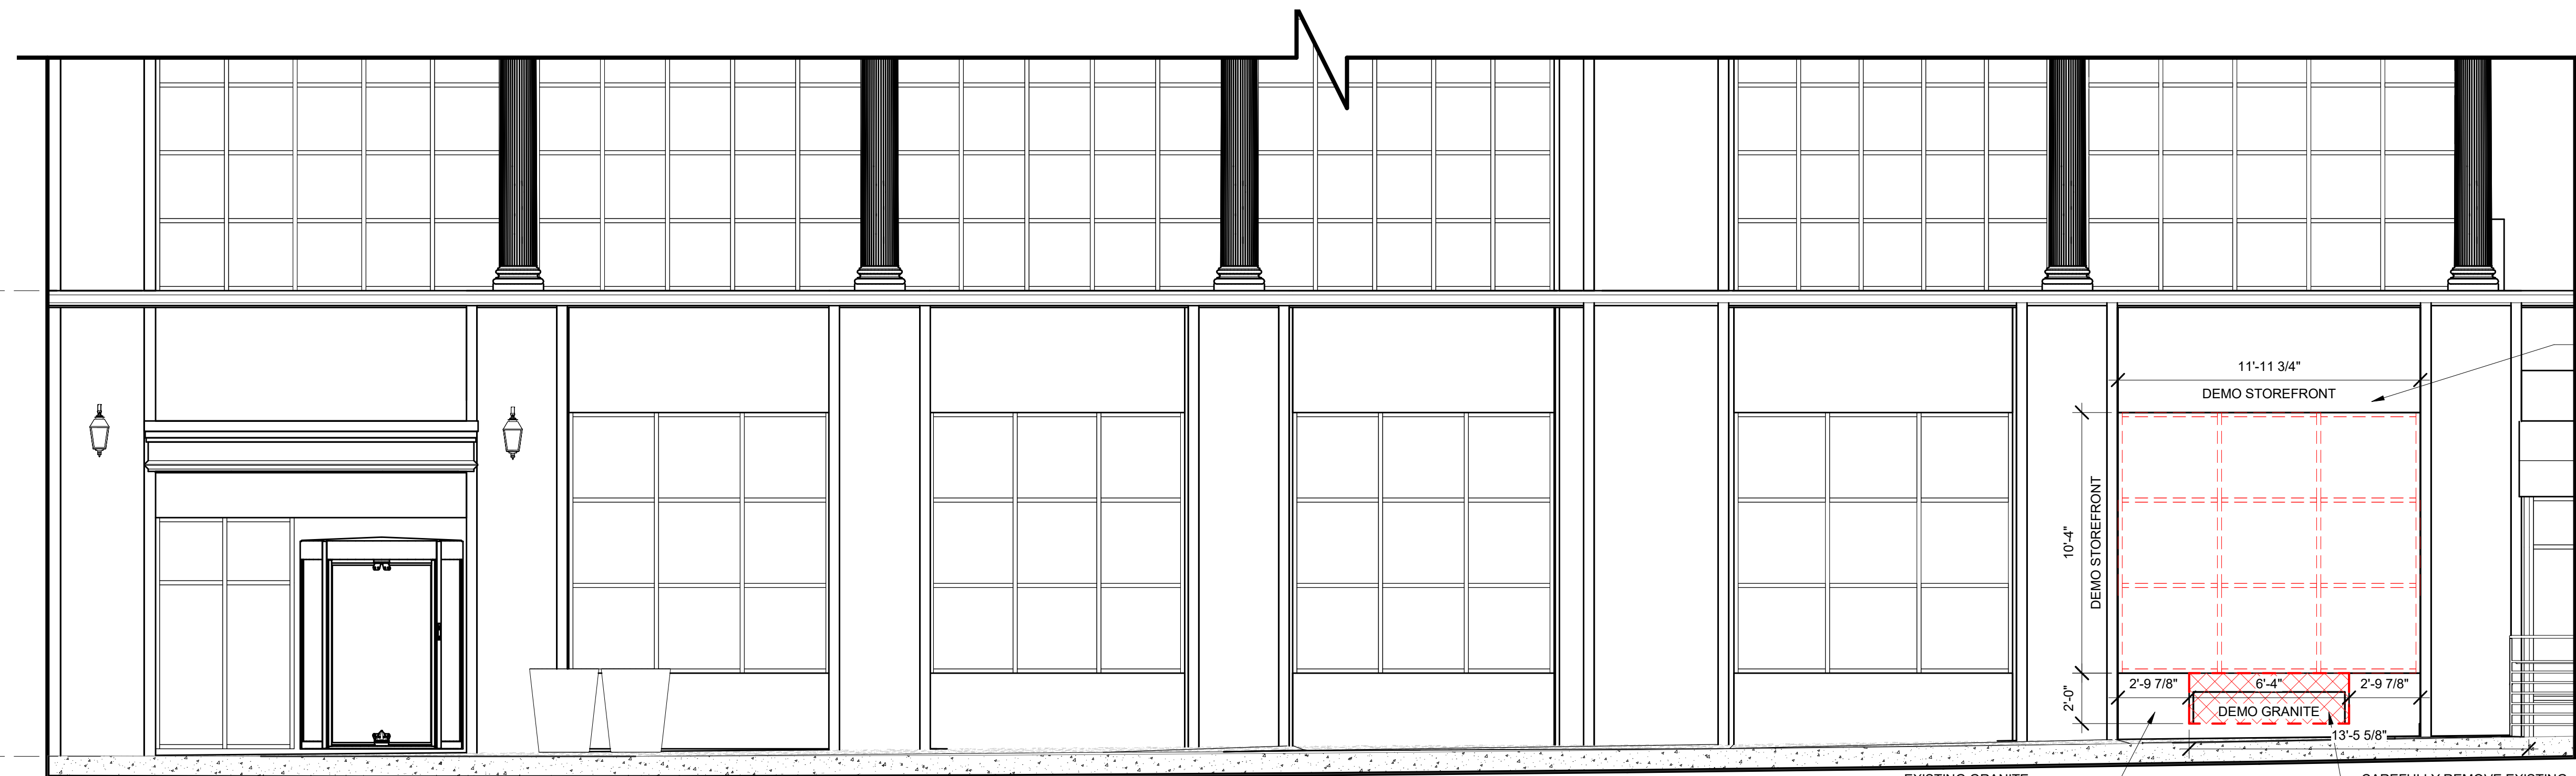


3 EXTERIOR ELEVATION DEMO
 1/4" = 1'-0"




FINISH TYPE: EXTERIOR WALL
GRANITE
 DEMO EXTENT: 13 SQ. FT.

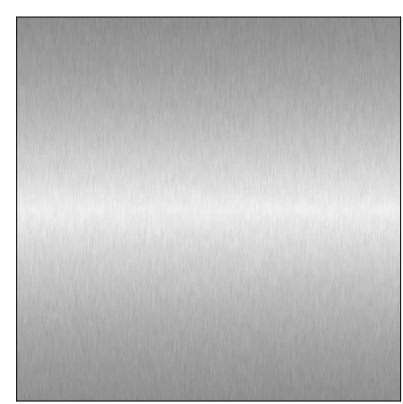

FINISH TYPE: STOREFRONT
METAL
 DEMO EXTENT: 7 LINEAR FEET

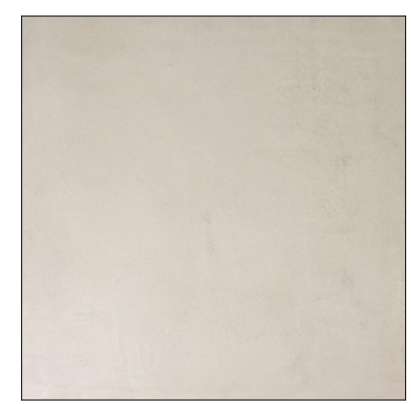

FINISH TYPE: EXTERIOR WALL
ST-1
 DEMO EXTENT: 0 SQ. FT.

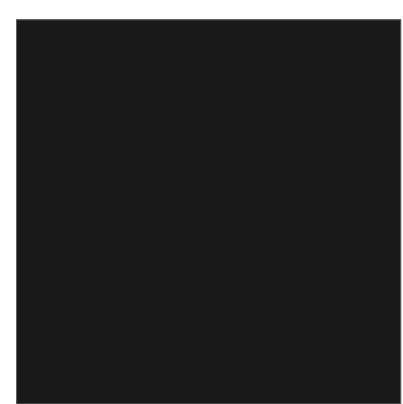


FINISH TYPE: GLAZING
GS-1
 DEMO EXTENT: 9 SQ. FT.



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REVISION SCHEDULE

SCHEMATIC DESIGN

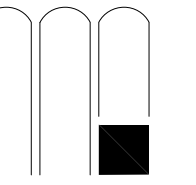
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SHEET STOREFRONT DETAILS


SHEET NUMBER

A-401



A1 STAIR HANDRAIL LONGITUDINAL
1 1/2" = 1'-0"

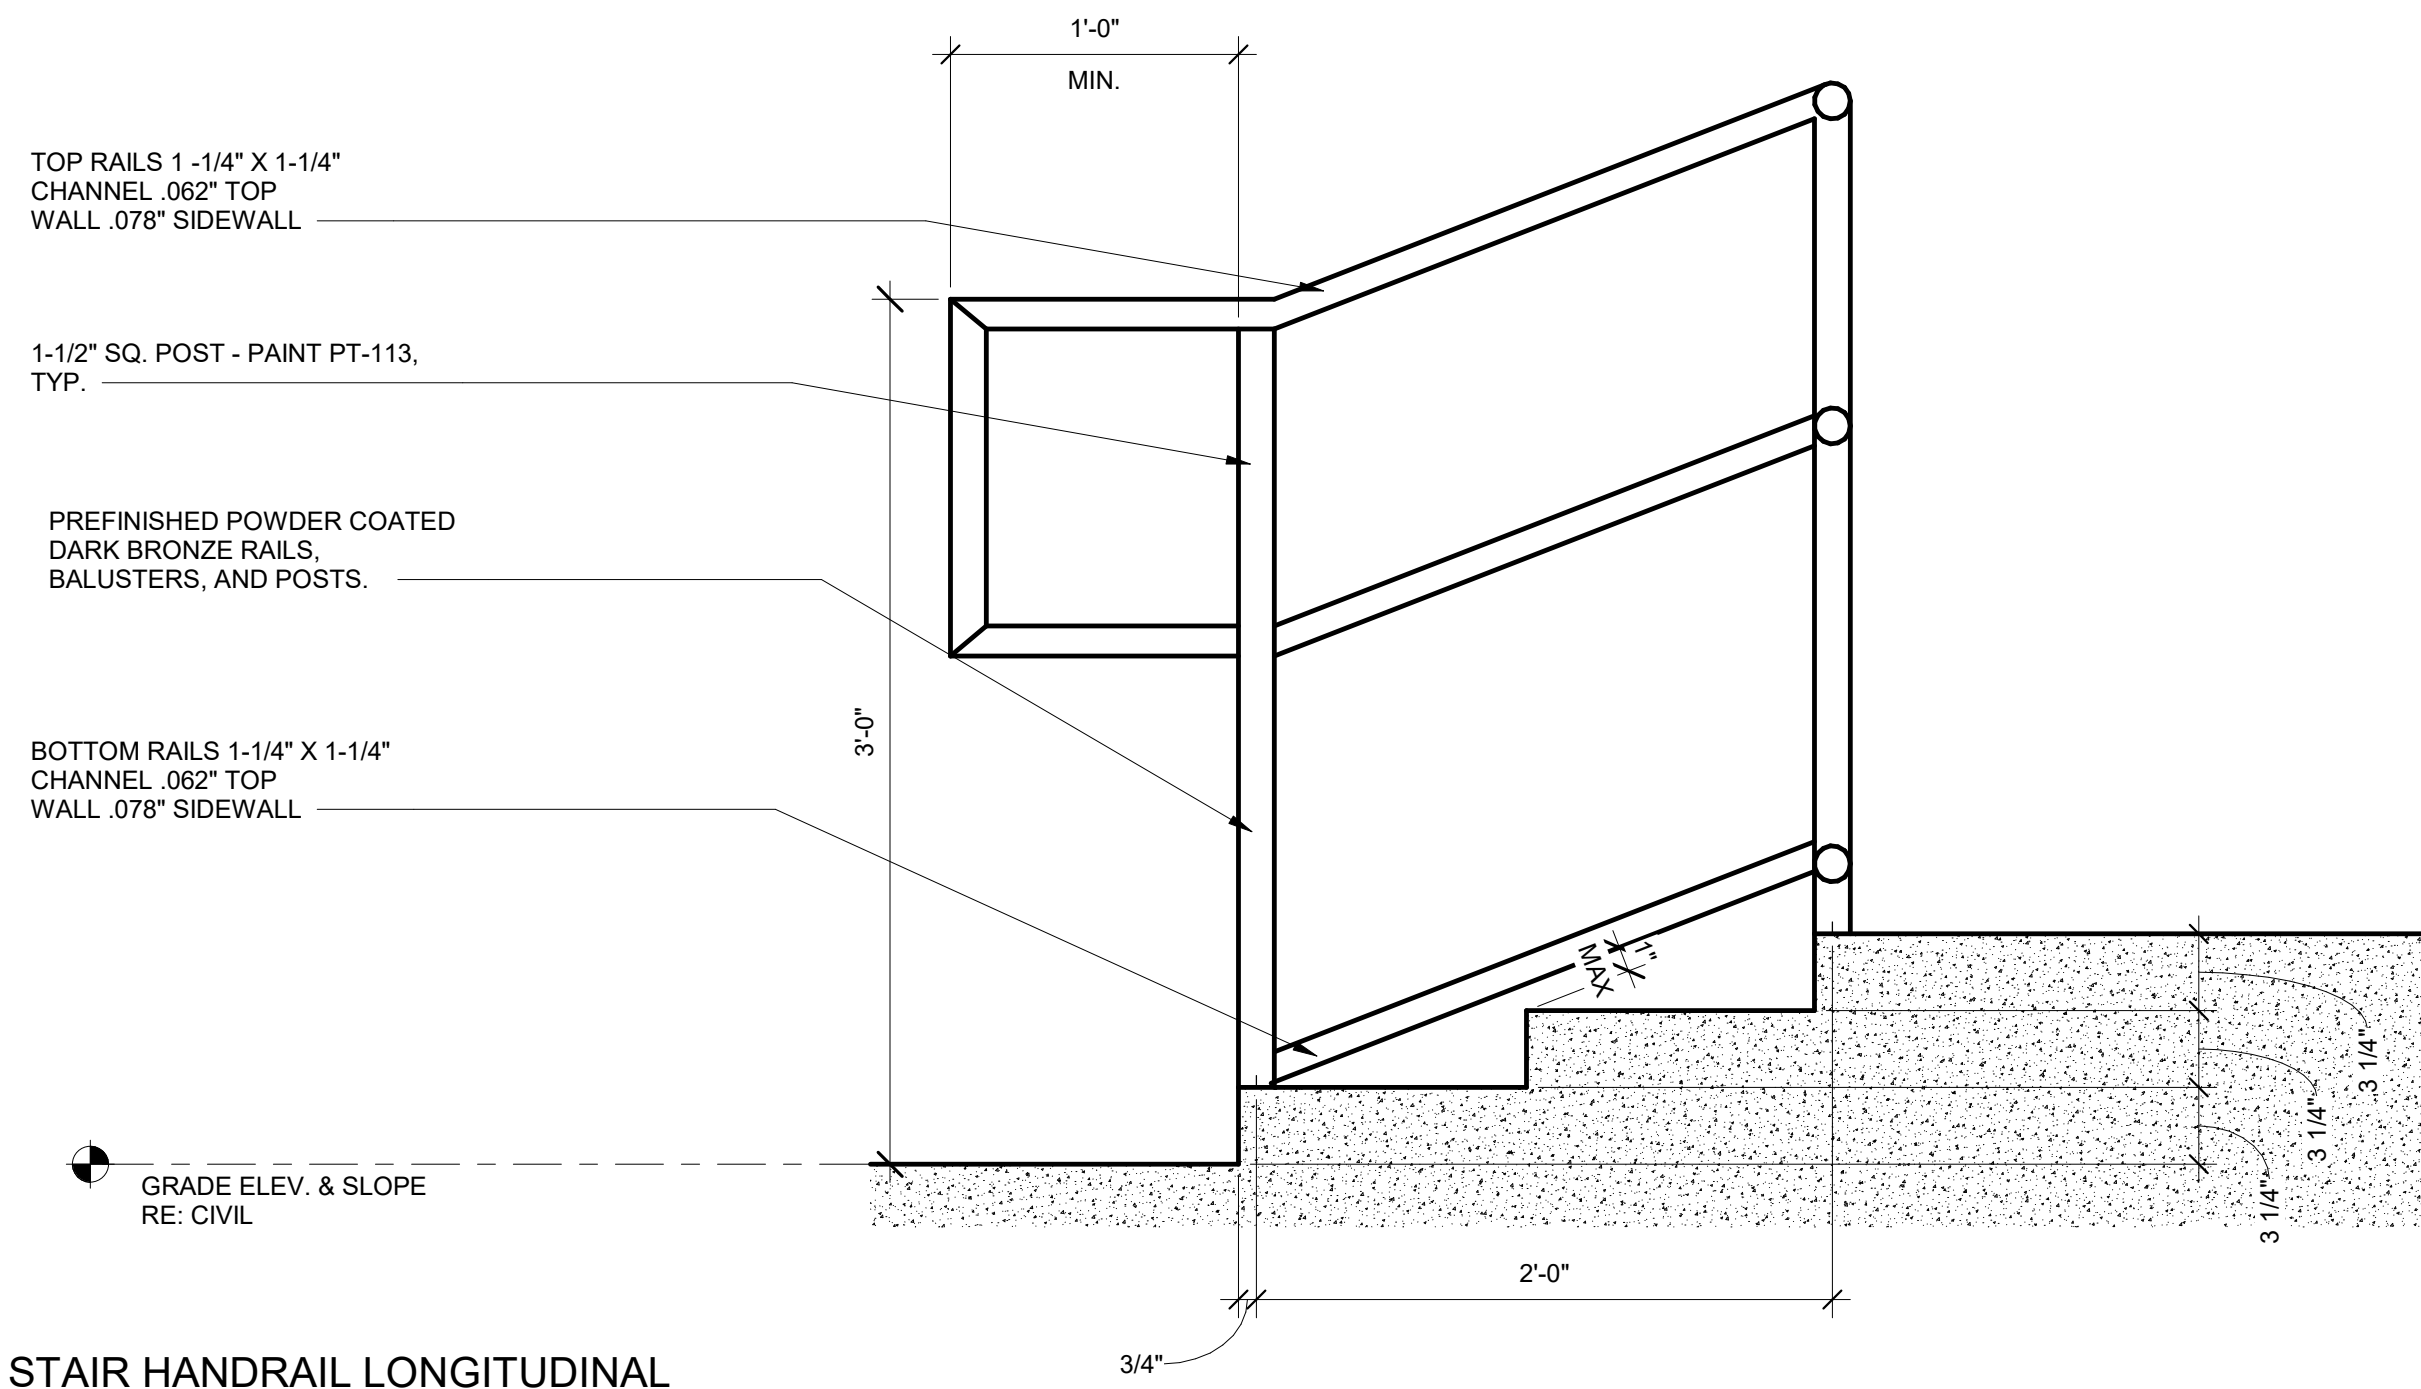NOTES:
1. ALL ALUMINUM TO BE .062" TOP WALL, .078 SIDE WALL

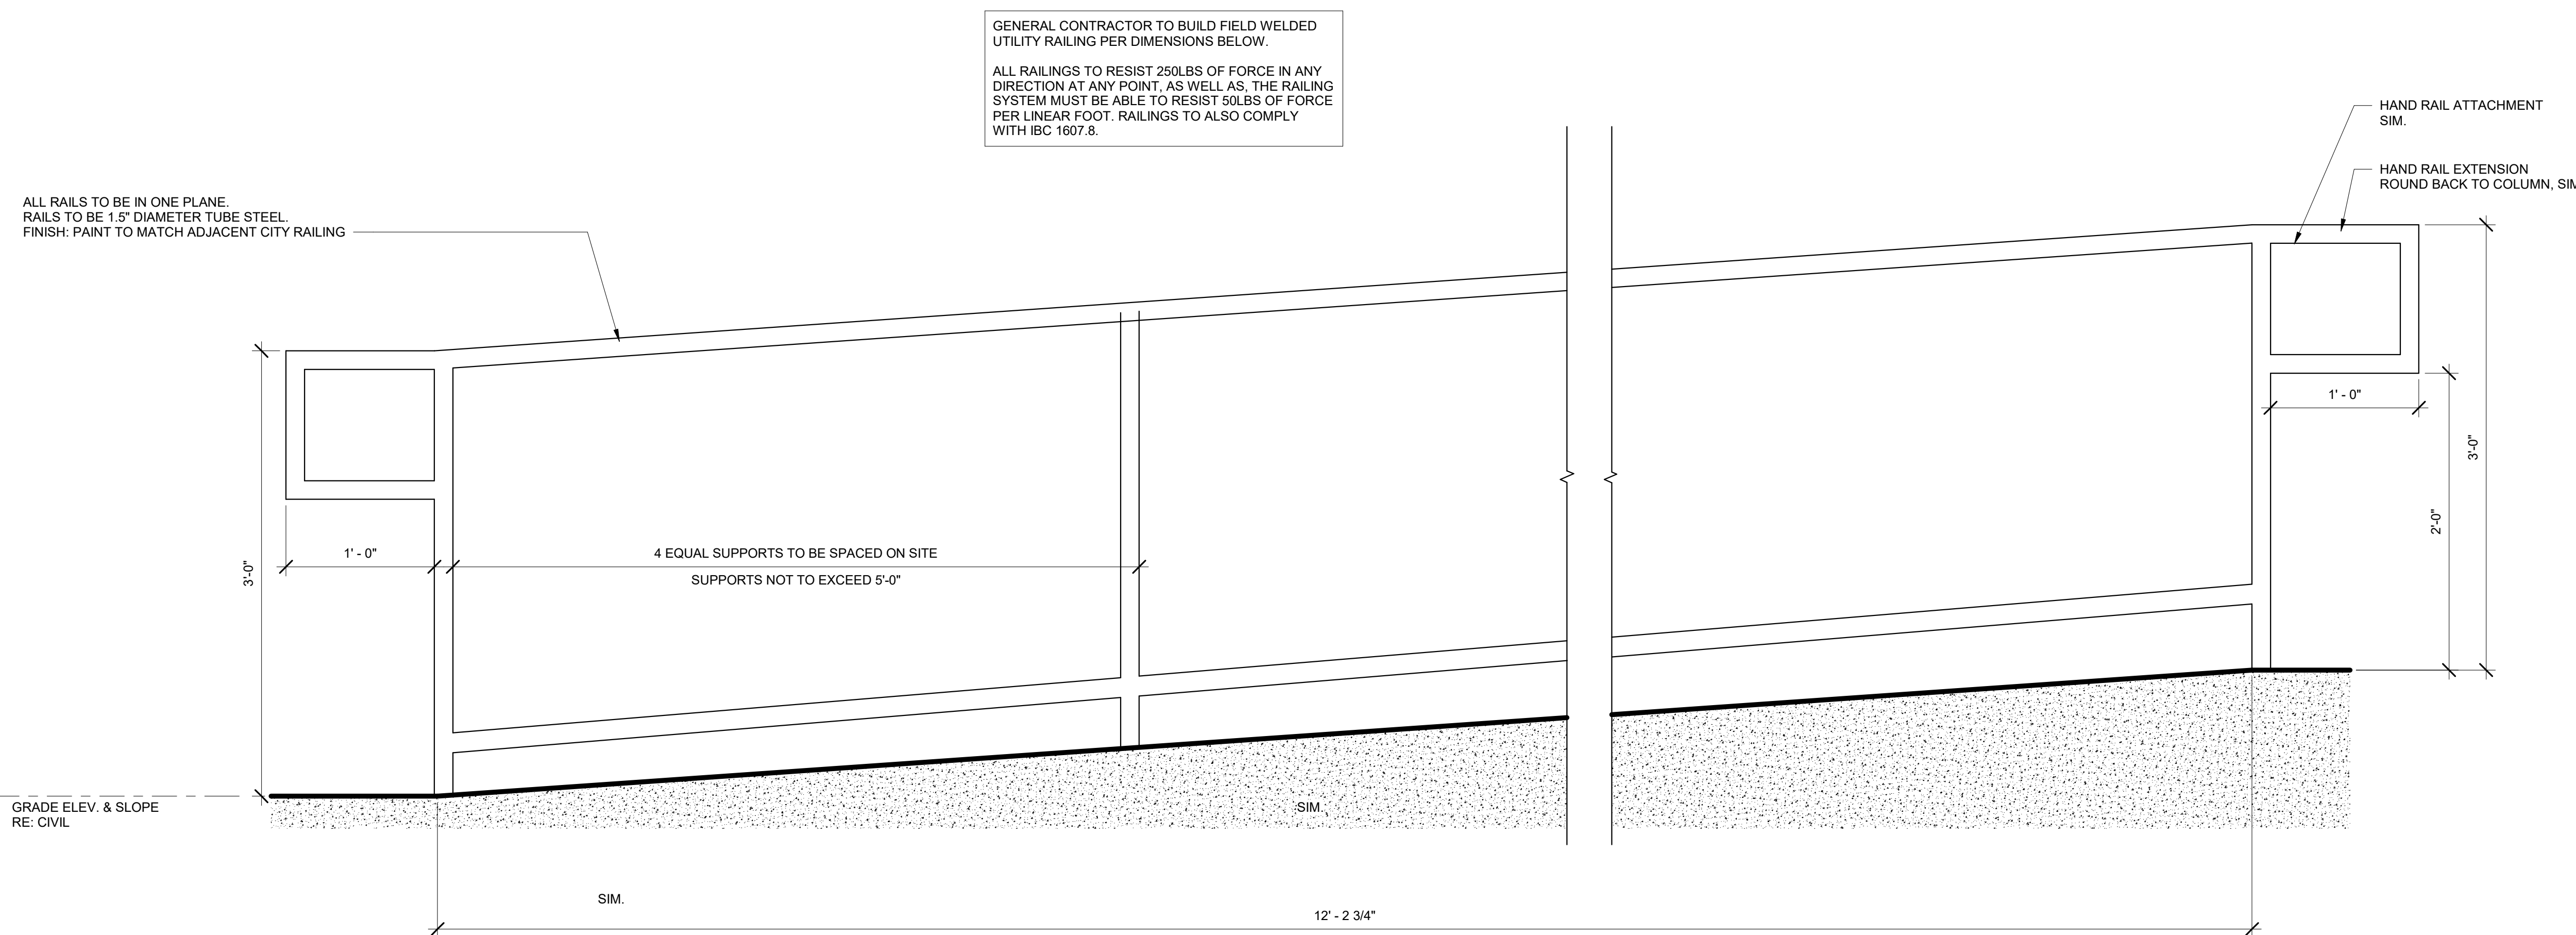

B1 UTILITY HANDRAIL
1 1/2" = 1'-0"

GENERAL CONTRACTOR TO BUILD FIELD WELDED UTILITY RAILING PER DIMENSIONS BELOW.
ALL RAILINGS TO RESIST 250LBS OF FORCE IN ANY DIRECTION AT ANY POINT, AS WELL AS, THE RAILING SYSTEM MUST BE ABLE TO RESIST 50LBS OF FORCE PER LINEAR FOOT. RAILINGS TO ALSO COMPLY WITH IBC 1607.8.


ALL RAILS TO BE IN ONE PLANE.
RAILS TO BE 1.5" DIAMETER TUBE STEEL.
FINISH: PAINT TO MATCH ADJACENT CITY RAILING

Autodesk Docs://M1_00000_First National Bank Building_2023.5_SAT000000_First National Bank Building_ARC.rvt
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80819-A-401-STOREFRONT DETAILS



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SHEET EXTERIOR DETAILS

SHEET NUMBER

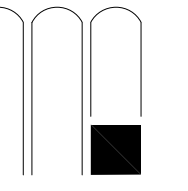A-501

