

# PROPOSED EXTERIOR LIGHTING AND SIGNAGE

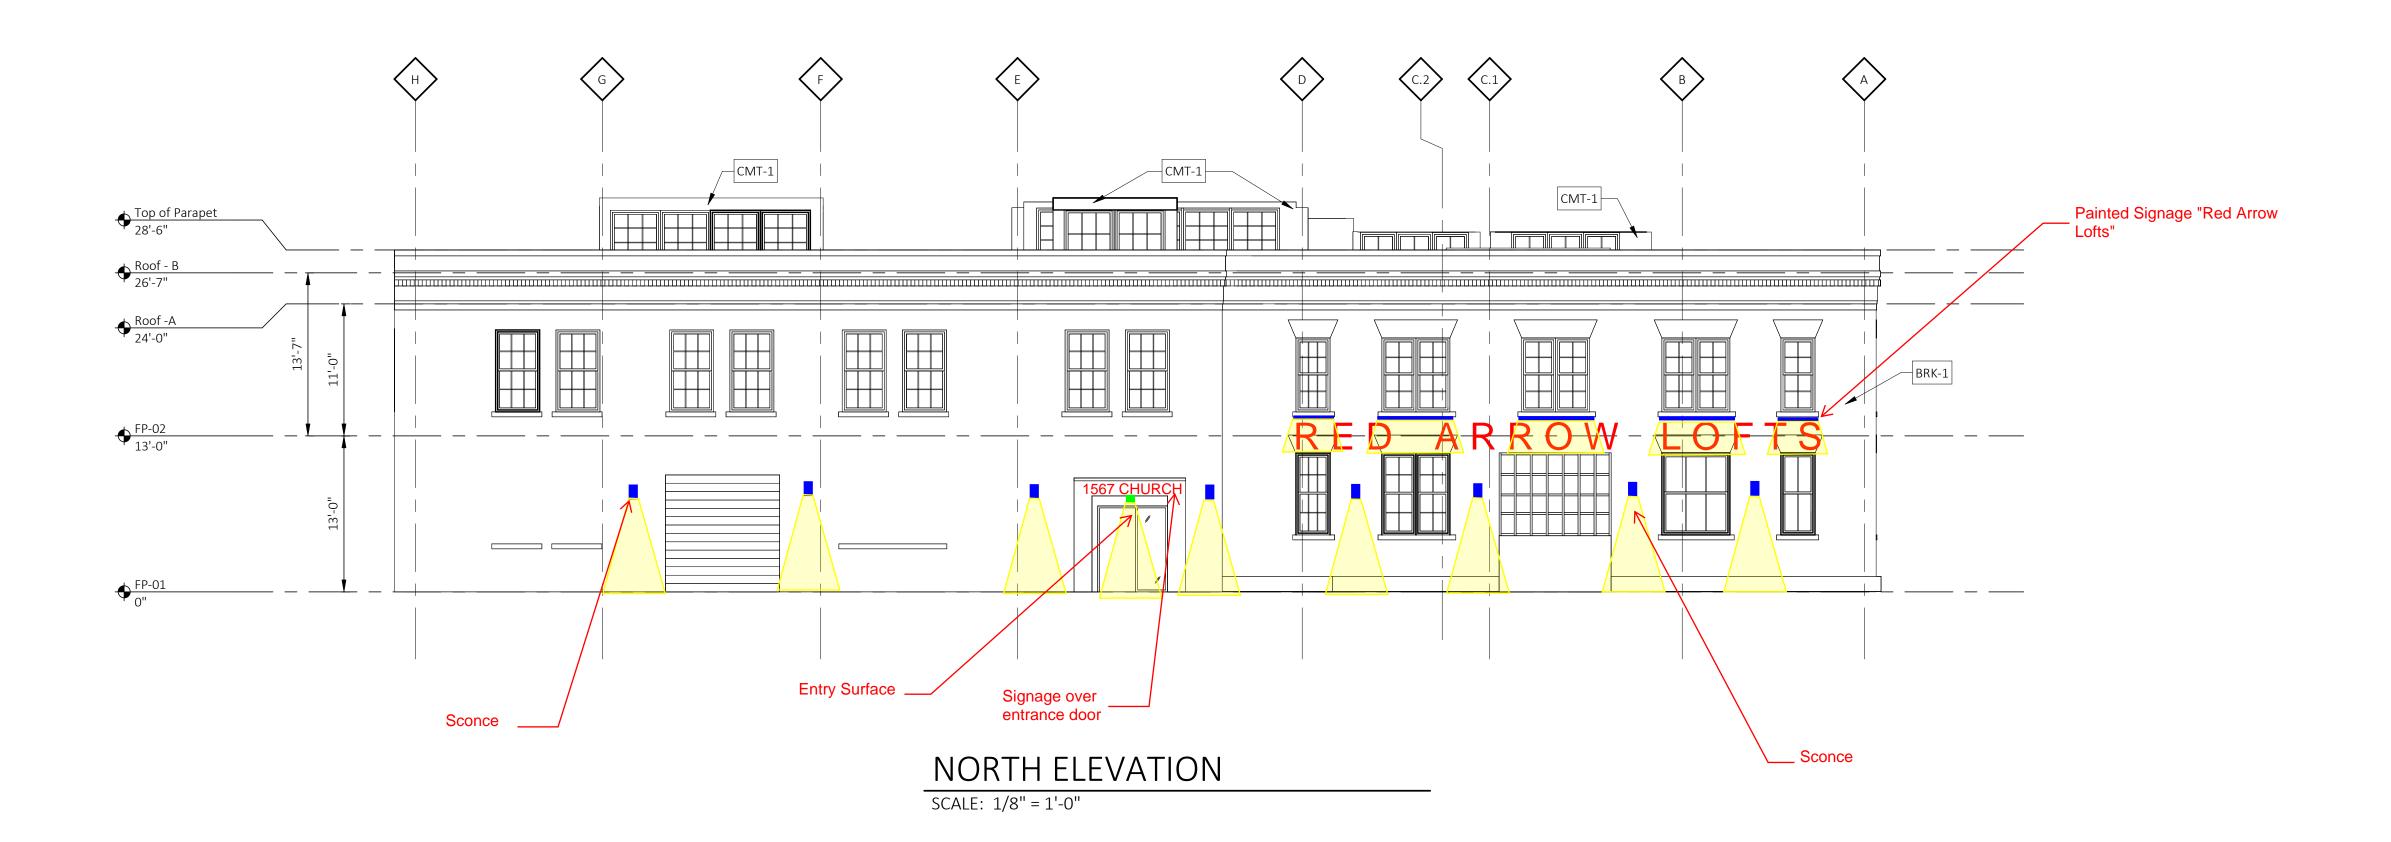

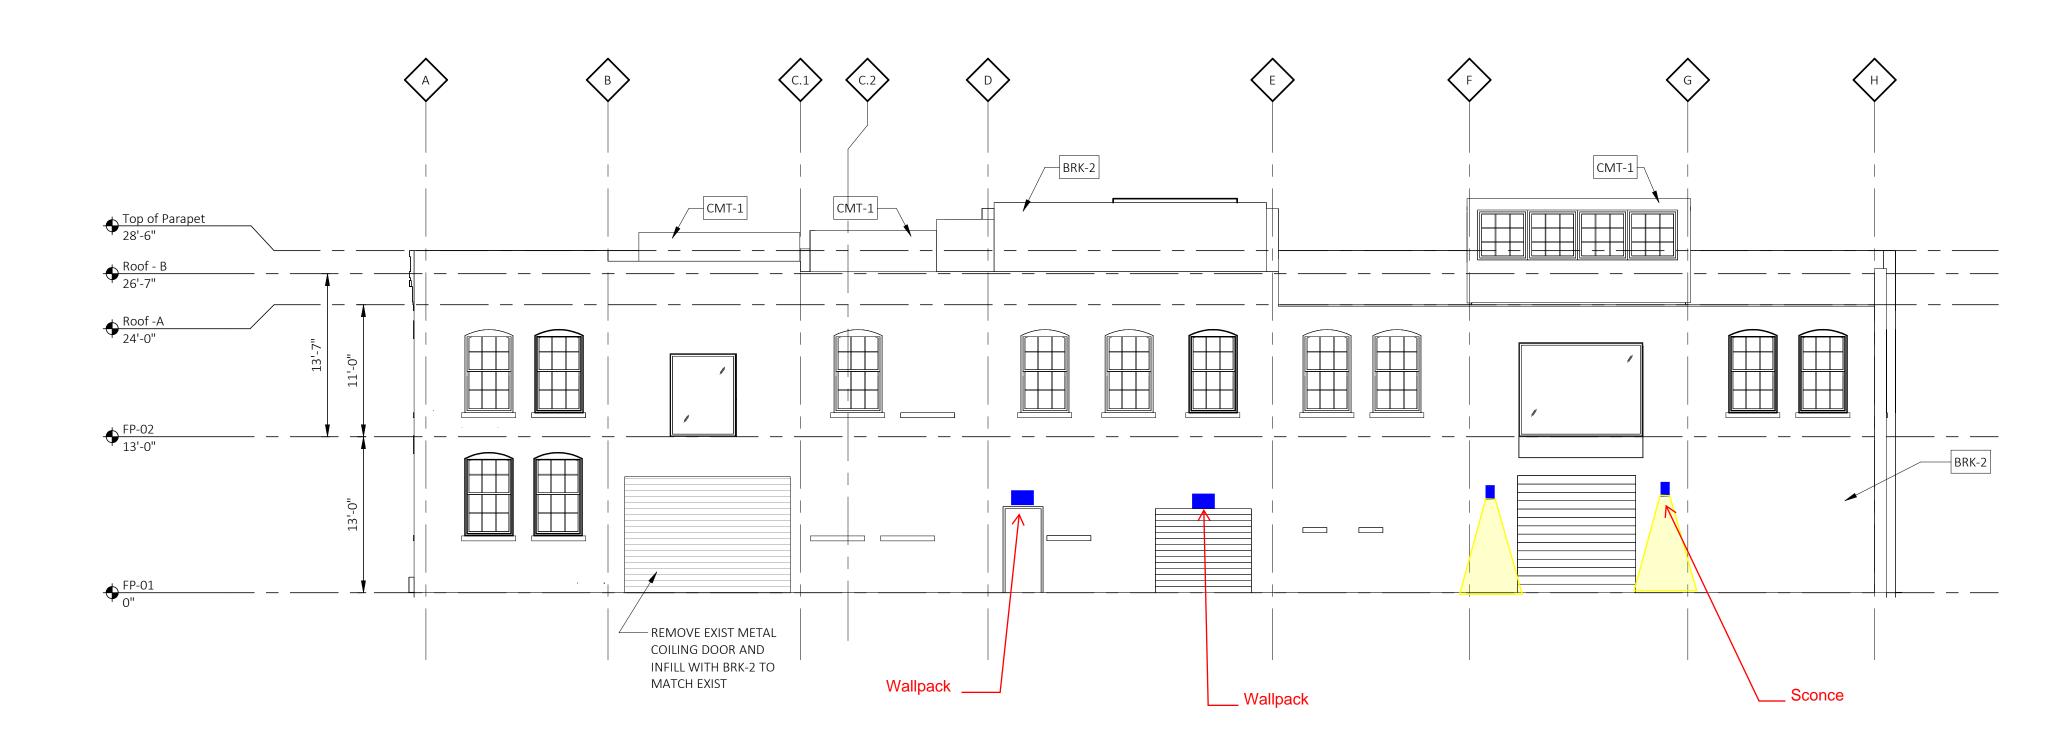

SOUTH ELEVATION SCALE: 1/8" = 1'-0"

### **GENERAL NOTES**

- A REFER TO A600 SERIES FOR WINDOW AND DOOR SCHEDULE AND DETAILS.
- B REFER TO REFLECTED CEILING PLANS FOR EXTERIOR SOFFIT INFORMATION.
- C REFER TO ROOF PLAN FOR PARAPET AND OVERHAND INFORMATION.
- D SEE ELECTRICAL DRAWINGS FOR ADDITIONAL LIGHTING REQUIREMENTS AND FIXTURE TYPES. E SEE ELEVATIONS AND STRUCTURAL DRAWINGS FOR LOCATIONS OF EXPANSION AND CONTROL JOINTS. CONTRACTOR SHALL PROVIDE ADDITIONAL INTERIOR CONTROL JOINTS AS REQUIRED TO COMPLY WITH MAXIMUM SPACING REQUIREMENTS IN SPECIFICATIONS AND NATIONAL MASONRY INSTITUTE. PROVIDE CONTROL JOINTS AT ALL MASONRY REENTRANT CORNERS.
- PROVIDE BACKING AND/OR STRUCTURAL SUPPORT AS REQUIRED FOR SIGNAGE AND LIGHTING. G EXPOSED STRUCTURAL STEEL SHALL BE GALVANIZED AND PAINTED UNLESS NOTED OTHERWISE.
- H APPLY SEALANT WHENEVER DISSIMILAR MATERIALS MEET.

### RESTORATION GENERAL NOTES

- A. MASONRY/STONE RESTORATION CONTRACTOR ("SUBCONTRACTOR") TO PROVIDE ALL LABOR, MATERIAL, EQUIPMENT, SUPERVISION, PERMITS AND ANY OTHER COSTS OR EXPENSES NECESSARY TO COMPLETE THE WORK. SUBCONTRACTOR JOB MOBILIZATION SHALL INCLUDE, BUT NOT BE LIMITED TO, ANY NECESSARY WORK STATION AND JOB TRAILER, MAST CLIMBING PLATFORMS, AERIAL LIFTS, SWING STAGES, BARRICADES AND WALK THRU SCAFFOLD AS NEEDED.
- B. BUILDING RESTORATION TO INCLUDE ALL TERMS, CONDITIONS AND SPECIFICATIONS OF ORIGINAL CONTRACT AND ANY ADDITIONAL WORK NECESSARY TO MEET THE SECRETARY OF THE INTERIOR STANDARDS FOR THE REHABILITATION OF HISTORIC PROPERTIES. THIS INCLUDES ALL WORK NECESSARY OVER AND ABOVE THAT SPECIFIED IN THE ARCHIOTECTURAL DRAWINGS AND OTHER CONSTRUCTION DOCUMENTS, INCLUDING ALL NOTES REGARDLESS OF TIME AND MATERIAL NECESSARY TO EXECUTE THIS WORK. ANY AREAS INDICATED WITHIN DRAWINGS ARE ONLY SUGGESTIVE IN NATURE . MASON TO MEET WITH ARCHITECT AND OWNER TO CONFIRM THE SCOPE OF WORK.
- C. RESTORATION CONTRACTOR SHALL INSPECT ALL EXISTING MASONRY, INCLUDING BOTH SIDES OF PARAPET FULL HEIGHT, FOR STRUCTURAL STABILITY PRIOR TO BID. REINSPECT AFTER INITIAL
- D. ALL ELEVATIONS SHALL UNDERGO COMPLETE BRICK, STONE, AND TERRA COTTA CLEANING FROM PARAPET TO GRADE. SEE MASONRY CLEANING SPECIFICATION SECTIONS FOR DETAILS ON APPROVED CLEANING PROCEDURES, PRODUCTS, AND MANUFACTURERS.
- E. CLEAN FACADE USING GENTLEST MEANS POSSIBLE TO ACHIEVE SATISFACTORY RESULTS WITHOUT CHANGING THE SURFACE OF THE MASONRY. PAY SPECIAL ATTENTION TO AREAS OF EXCESSIVE SOILING. CONTRACTOR SHALL CONDUCT TEST PATCHES TO ENSURE THE BEST AND MOST ECONOMICAL MEANS OF CLEANING. ALL MASONRY AND TERRA COTTA CLEANING SHALL MEET THE SECRETARY OF INTERIOR STANDARDS FOR REHABILITATION AS WELL AS ALL APPLICABLE NATIONAL PARK SERVICE TECHNICAL BRIEFS.
- SURFACES TO BE PRE-WET WITH CLEAN WATER. CLEANING SOLUTIONS TO NOT REMAIN ON SURFACES FOR MORE THAN 5 MINUTES FOLLOWED IMMEDIATELY BY LOW-PRESSURE FLOOD RINSE, UNLESS NOTED OTHERWISE IN MASONRY CLEANING SPECIFICATION. CLEANING IS TO BRING MASONRY / STONE UNIT AS CLOSE AS POSSIBLE TO ORIGINAL COLOR WITHOUT BURNING OR
- G CLEAN ALL STONE THAT IS TO REMAIN & LET WEATHER FOR TWO WEEKS BEFORE ANY REPLACEMENT OR PATCHING IS TO OCCUR - REPLACEMENT STONE & PATCHED AREAS TO MATCH EXIST 'CLEANED' COLOR
- H. 100% OF MORTAR JOINTS TO BE VISUALLY INSPECTED. ALL MORTAR JOINTS DETERIORATED IN EXCESS OF 3/8 INCH BEYOND FACE OF MASONRY/STONE UNIT, OR EVIDENCING UNSOUNDNESS OF CRACKING WHETHER STRUCTURAL OR OTHERWISE SHALL BE REMOVED TO A DEPTH OF 1/2" MINIMUM. WRITTEN APPROVAL BY OWNER SHALL BE REQUIRED PRIOR TO COMMENCEMENT OF REPAIR BY SATISFACTORY SUBMISSION OF MOCK-UP OF PROPOSED MORTAR JOINT.
- NEW MORTAR APPLIED TO ALL OPEN JOINTS SHALL BE OF NO GREATER STRENGTH THAN ORIGINAL MORTAR OR MASONRY UNITS. MORTAR COLOR, TEXTURE, CONSISTENCY AND JOINT PROFILE WILL MATCH EXISTING AS CLOSE AS POSSIBLE.
- J APPLY NEW, TWO COMPONENT URETHANE SEALANT AT ALL JOINTS WHERE DISSIMILAR MATERIALS MEET, AND ALL SKYWARD FACING JOINTS. BACKER ROD TO BE INSTALLED IN OPEN JOINT PRIOR TO SEALANT APPLICATION.
- K. NO ACCELERATORS OR OTHER ADMIXTURES SHALL BE USED WITHOUT PRIOR WRITTEN OWNER APPROVAL. ENCLOSURES AND HEAT SUFFICIENT TO PROTECT MORTAR FROM FREEZING PRIOR TO SET SHALL BE THE SOLE RESPONSIBILITY OF SUBCONTRACTOR. REPLACE/RESET LOOSE MASONRY UNITS AND REPOINT DAMAGED MORTAR JOINTS AS REQUIRED.

IF NECESSARY, RECOMMEND FURTHER REHABILITATION TO ENSURE STABILITY OF EXTERIOR WALL

- AND PARAPET CONSTRUCTION. SEE MASONRY RESTORATION SPECIFICATIONS FOR DETAILS ON APPROVED RESTORATION PROCEDURES, PRODUCTS, AND MANUFACTURERS. ALL MASONRY RESTORATION WORK SHALL MEET THE SECRETARY OF INTERIOR STANDARDS FOR REHABILITATION AS WELL AS ALL APPLICABLE NATIONAL PARK SERVICE TECHNICAL BRIEFS.
- M. ALL MASONRY/ STONE UNIT SHALL BE REPLACED WITH OWNER APPROVED MATERIAL WHEREIN SPALLING OR OTHER DETERIORATION ELIMINATED MORE THAN 5% OF THE MASONRY/ STONE UNIT (MEASURED BY ORIGINAL BRICK OR STONE FACE AREA).
- N. INSPECT ALL TERRA COTTA UNITS FOR DAMAGE, SPALLING OR CRAZING.
- O. WHERE TERRA COTTA GLAZING HAS SPALLED AND THE CLAY SUBSTRATE IS IN GOOD CONDITION, COAT RAW CLAY WITH APPROVED BREATHABLE SEALER TO MATCH COLOR OF EXISTING GLAZING. P. WHERE TERRA COTTA UNITS HAVE SPALLED SIGNIFICANTLY, PATCH DAMAGED AREAS WITH
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- Q. WHERE TERRA COTTA HAS DETERIORATED BEYOND REPAIR, REMOVE AFFECTED TERRA COTTA UNITS AND PROVIDE NEW TERRA COTTA UNITS TO MATCH EXISTING PROFILE, COLOR AND FINISH. R. SEE TERRA COTTA RESTORATION SPECIFICATIONS FOR APPROVED RESTORATION PROCEDURES, PRODUCTS, AND MANUFACTURERS. ALL TERRA COTTA RESTORATION WORK SHALL MEET THE SECRETARY OF INTERIOR STANDARDS FOR REHABILITATION AS WELL AS ALL APPLICABLE NATIONAL PARK SERVICE TECHNICAL BRIEFS.

### CONSTRUCTION KEYNOTES ###

Architect

Consultant

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05-27-22

PERMIT DATE

## EXTERIOR ELEVATION MATERIAL LEGEND

BRK-1 RED BRICK - EXISTING BRK-2 REDDISH BROWN BRICK - EXISTING CMT-1 FIBER CEMENT SIDING MTL-1 INSULATED METAL PANEL - BLACK BRICK TO MATCH BRK-1

BRICK TO MATCH BRK-2


Project Number Sheet Title **EXTERIOR ELEVATIONS** 


Sheet Number

A201



# PROPOSED EXTERIOR LIGHTING AND SIGNAGE

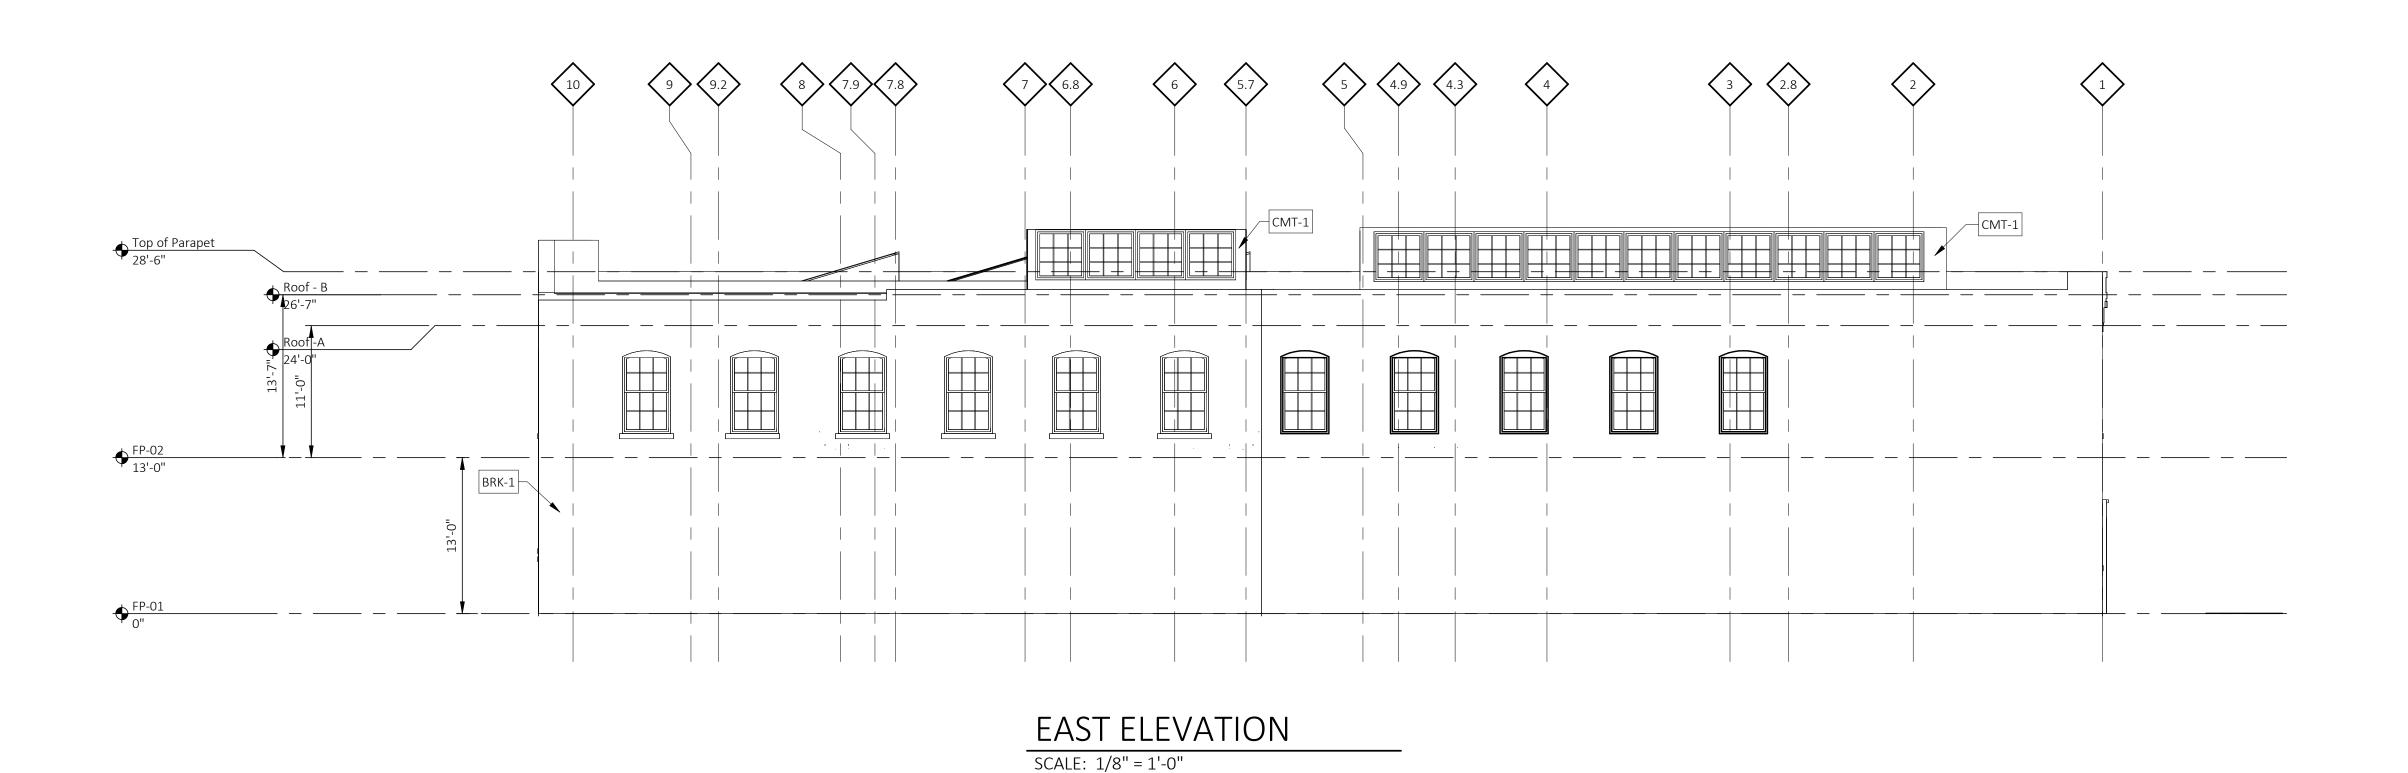

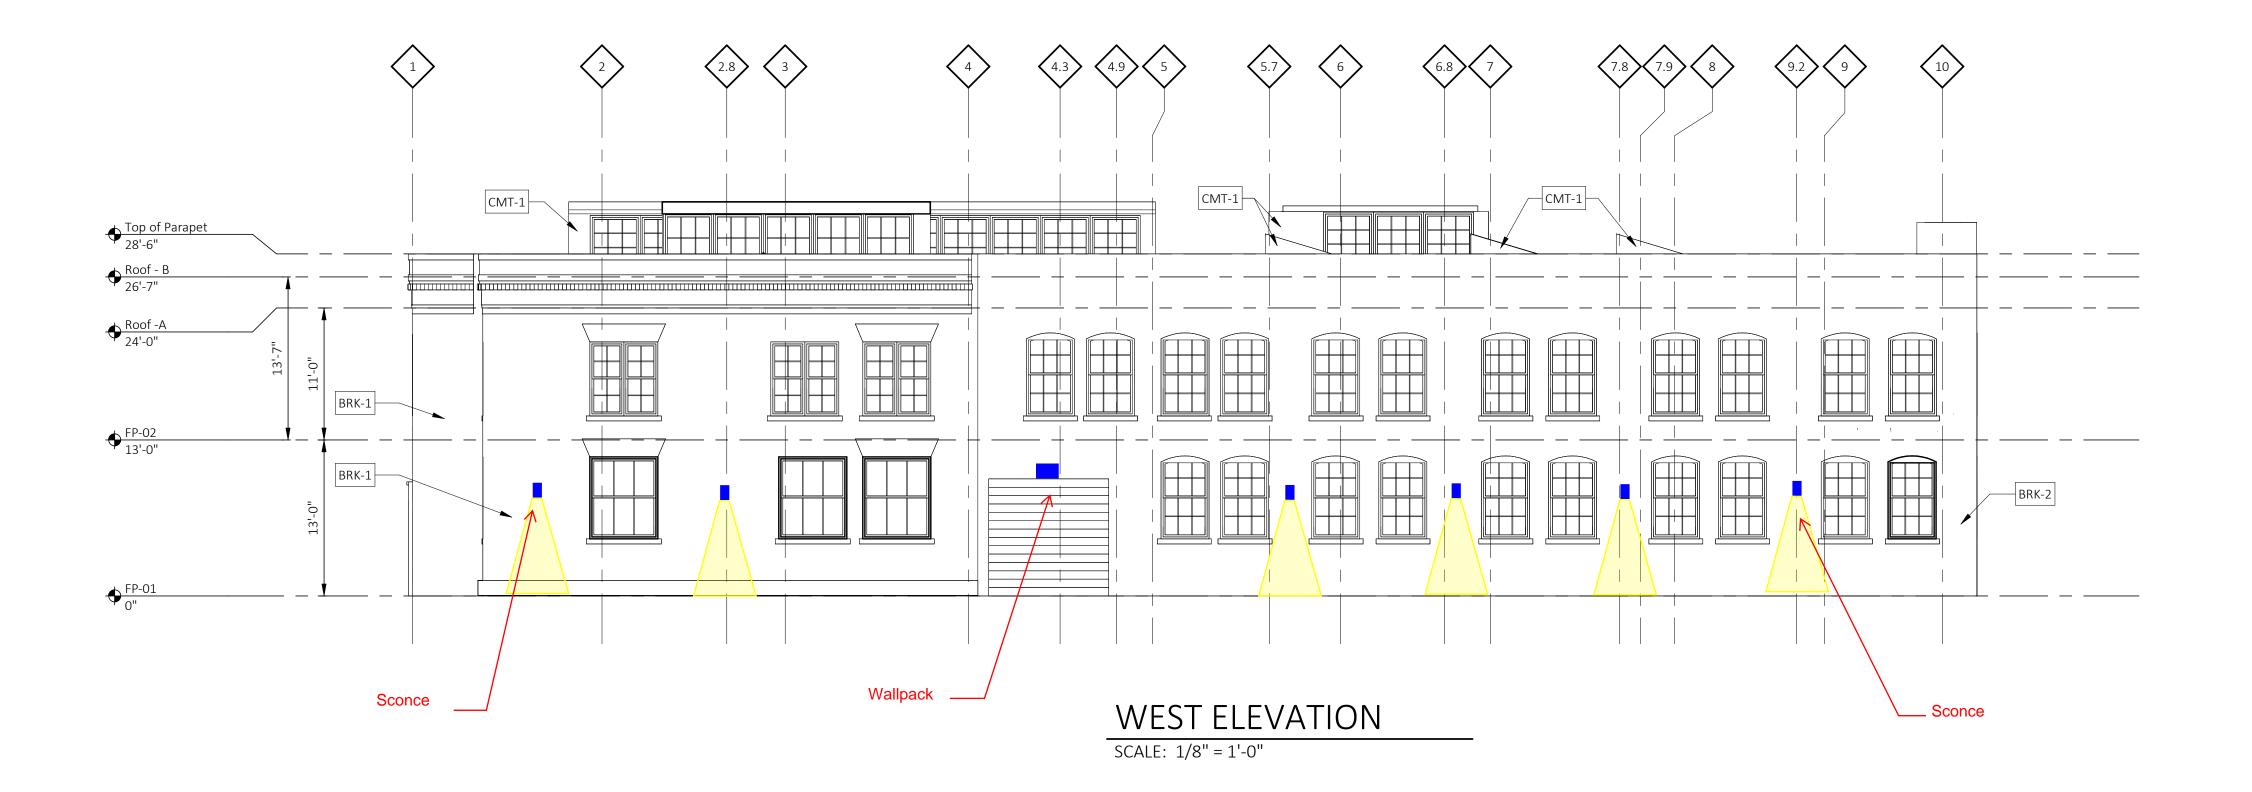

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Consultant

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BRICK TO MATCH BRK-2

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