KRIEGER KLATT ARCHITECTS

Historic District Commission Project Review

92 Forest (Phase 2)

92 E. Forest Avenue, Detroit, MI 4820 Historic District Commission City of Detroit Planning & Development Department 2 Woodward Avenue, Room 808, Detroit, MI 48226

Date: May 16, 2022

TABLE OF CONTENTS

SECTION 1	Project Description	3
SECTION 2	HDC—Project Review Request Application	4
SECTION 3	Existing Conditions Photographs	9
SECTION 4	New Entry Doors	17
SECTION 5	Window Evaluation	23
SECTION 6	Roof Evaluation and Replacement Report	40
EXHIBIT A	Drawing Set	51
EXHIBITB	Roof Condition Photos and Videos	

PROJECT DESCRIPTION

92 E. FOREST DETROIT, MI 48201

Conversion of former Church of the New Jerusalem into a 15 unit apartment building. The apartment project is to consist of (11) studio units and (4) one-bedroom units with a common mail room. The church consists of the original sanctuary with multiple additions. The church consists of two stories with a partial basement, the basement is proposed to be used as a utility room only and will have new exterior access. The exterior of 92 E. Forest is considered historic while the interior is not included in the designation. Exterior work to be included is designated in the following report for approval. Proposed interior modifications are shown for reference only.

ONLY WINDOWS AND ENTRY DOORS ARE INCLUDED IN THIS SCOPE. OTHER EXTERIOR CHANGES WERE APPROVED IN RESPONSE TO STAFF REPORT #22-7716.

The exterior changes proposed are as follows:

Building Modifications

- 1. New Entry Doors, Shown for intent only, final shop drawings to be submitted to HDC Staff.
- 2. Repair (7) Sanctuary and (2) Nave windows
- 3. Replace double hung windows throughout
- 4. Replace existing sanctuary slate roof with new Slateline Asphalt Shingles to match the rest of the shingled roof previously approved.

HDC APPLICATION

92 E. FOREST DETROIT, MI 48201

Refer to the following pages for the HDC Application.

THIS IS A 3-PAGE FORM - ALL INFORMATION IS REQUIRED FOR PROJECT REVIEW

HISTORIC DISTRICT COMMISSION PROJECT REVIEW REQUEST

City of Detroit - Planning & Development Department 2 Woodward Avenue, Suite 808 Detroit, Michigan 48226

DATE: 05.12.22

PROPERTY INFORMATION	
ADDRESS(ES): 86 & 92 E. Forest	ака: 92 E. Forest
PARCEL ID:01001213, 01001214	HISTORIC DISTRICT: Sugar Hill District
SCOPE OF WORK: Windows/ Walls/ (Check ALL that apply) Ooors Siding Image: Check ALL that apply Demolition Signage	Painting Roof/Cutters/ Chinney Porch/Deck/ Balcony Addition New Building Major Alteration (3+ scope items) Site Improvements (landscape, trees, fences, patios, etc.)
BRIEF PROJECT DESCRIPTION: Repair and Replace windows. New Doors.	Replace windows. New Doors. Replace Roof. . Replace Roof.
APPLICANT IDENTIFICATION	
Property Owner/ Homeowner Contractor	Tenant or Business Occupant Architect/Engineer/ Consultant COMPANY NAME: Krieger Klatt Architects
ADDRESS: 2120 E. 11 Mile Rd.	CITY: Royal Oak STATE: MI ZIP: 48067
PHONE: 248.414.9270 MOBILE: 586	6.556.9910 EMAIL: jeff@kriegerklatt.com
PROJECT REVIEW REQUEST CH	ECKLIST
Please attach the following documentation t *PLEASE KEEP FILE SIZE OF ENTIRE SUBMISSIO	
Completed Building Permit Application (highlighted portions only)	Based on the scope of work, additional documentation may be required.
ePLANS Permit Number (only applicab applied for permits through ePLANS)	le if you've already I See www.detroitmi.gov/hdc for scope- I specific requirements.
	nt of the building & detailed photographs of the area(s) affected by be labeled or captioned, e.g. "west wall", "second floor window," etc
Description of existing conditions (incl	luding materials and design)

Description of project (if replacing any existing material(s), include an explanation as to why

replacement--rather than repair--of existing and/or construction of new is required)



Detailed scope of work (formatted as bulleted list)

Brochure/cut sheets for proposed replacement material(s) and/or product(s), as applicable

Upon receipt of this documentation, staff will review and inform you of the next steps toward obtaining your building permit from the Buildings, Safety Engineering and Environmental Department (BSEtED) to perform the work.

SUBMIT COMPLETED REQUESTS TO: HDC@DETROITMI.GOV

P2 - BUILDING PERMIT APPLICATION

Date: 02.14.2022

PROPERTY INFORMATION			
Address: 86 & 92 E. Forest	Flo	oor:Suit	:e#:Stories:
AKA: 92 E. Forest	Lot(s):	2 Subd	ivision: Sugar Hill
Parcel ID#(s): 01001213, 010012	14 Total Acres: 0.391	Lot Width:	Lot Depth: 15
Current Legal Use of Property: <u>B</u>			
Are there any existing buildings o	or structures on this parcel?	Yes	No No
PROJECT INFORMATION			
Permit Type: 📃 New 🔳	Alteration 🗌 Addition	Demolition	Correct Violati
🗌 Foundation Only 🛛 🔳 Chang	je of Use 🛛 Temporary	Use 🗌 Other:	
Revision to Original Permit #:		(Original permit h	as been issued and is act
Description of Work (Describe in	detail proposed work and use o	f property, attach wo	ork list)
Site improvements to parking lot; side and front entrie			
Rebuild front entry and side entry ramp. Replace ou			
	MB0	C use change	No MBC use chan
Included Improvements (Check	all applicable; these trade areas	require separate pe	rmit applications)
HVAC/Mechanical Elec	ctrical 🗌 Plumbing 🗌	Fire Sprinkler S	System 🗌 Fire Al
Structure Type			
New Building Existing S	Structure 🔲 Tenant Spa	ce 🗌 Garage	e/Accessory Building
Other: Size of	of Structure to be Demolish	ed (LxWxH)	cubic
Construction involves changes to	_	Yes n	
(e.g. interior demolition or construction	to new walls)		
Use Group: <mark>R2</mark> Type	e of Construction (per current	MI Bldg Code Table	e 601) VB
Estimated Cost of Construction	\$	\$	
Structure Use	By Contractor		By Department
Residential-Number of Units: <u>15</u>	_ Office-Gross Floor Area _	Indust	rial-Gross Floor Area
			ier-Gross Floor Area
Commercial-Gross Floor Area:	_ Institutional-Gross Floor A		
Commercial-Gross Floor Area: Proposed No. of Employees:			
Proposed No. of Employees: PLOT PLAN SHALL BE submitted o (must be correct and in detail). SHO existing and proposed distances to	List materials to be stored in th on separate sheets and shall OW ALL streets abutting lot	e building: show all easemen , indicate front of oplication Continu	ts and measurements lot, show all building
Proposed No. of Employees: PLOT PLAN SHALL BE submitted o (must be correct and in detail). SHO existing and proposed distances to F	List materials to be stored in the on separate sheets and shall OW ALL streets abutting lot to to lines. (Building Permit A for Building Department U	e building: show all easemen , indicate front of oplication Continu Jse Only	ts and measurements lot, show all building
Proposed No. of Employees: PLOT PLAN SHALL BE submitted o (must be correct and in detail). SHO existing and proposed distances to	List materials to be stored in the on separate sheets and shall OW ALL streets abutting lot to to lines. (Building Permit A for Building Department U	e building: show all easemen , indicate front of oplication Continu Jse Only	ts and measurements lot, show all building es on Next Page)
Proposed No. of Employees: PLOT PLAN SHALL BE submitted o (must be correct and in detail). SH(existing and proposed distances to Intake By: Permit Description:	List materials to be stored in the separate sheets and shall OW ALL streets abutting lot lot lines. (Building Permit A for Building Department L Date:	e building: show all easement, indicate front of oplication Continue Jse Only Fees Due:	ts and measurements lot, show all building es on Next Page) DngBld?
Proposed No. of Employees: PLOT PLAN SHALL BE submitted of (must be correct and in detail). SHO existing and proposed distances to Intake By: Permit Description: Current Legal Land Use:	List materials to be stored in the on separate sheets and shall OW ALL streets abutting lot o lot lines. (Building Permit A for Building Department L Date:	e building: show all easemen , indicate front of oplication Continu Jse Only Fees Due: posed Use:	ts and measurements lot, show all building es on Next Page) DngBld?
Proposed No. of Employees: PLOT PLAN SHALL BE submitted of (must be correct and in detail). SHO existing and proposed distances to Intake By: Permit Description: Current Legal Land Use:	List materials to be stored in the on separate sheets and shall OW ALL streets abutting lot o lot lines. (Building Permit A for Building Department L Date:	e building: show all easemen , indicate front of oplication Continu Jse Only Fees Due: posed Use:	ts and measurements lot, show all building es on Next Page) DngBld?
Proposed No. of Employees: PLOT PLAN SHALL BE submitted of (must be correct and in detail). SHO existing and proposed distances to Intake By: Permit Description: Current Legal Land Use: Permit#:	List materials to be stored in the on separate sheets and shall OW ALL streets abutting lot o lot lines. (Building Permit A for Building Department L Date:	e building: show all easement, indicate front of oplication Continue Jse Only Fees Due: posed Use: Permit Co	ts and measurements lot, show all building es on Next Page) DngBld?
Proposed No. of Employees: PLOT PLAN SHALL BE submitted of (must be correct and in detail). SHO existing and proposed distances to F Intake By: Permit Description: Current Legal Land Use: Permit#: Zoning District:	List materials to be stored in the separate sheets and shall OW ALL streets abutting lot lot lines. (Building Permit A for Building Department L Date: Date: Pro Pro Pro Date Permit Issued: Date Permit P	e building: show all easement, indicate front of oplication Continue Jse Only Fees Due: Fees Due: Permit Continue Permit Continue Fermit Continue Permit Continue	ts and measurements lot, show all building es on Next Page) DngBld?
Proposed No. of Employees: PLOT PLAN SHALL BE submitted of (must be correct and in detail). SHO existing and proposed distances to F Intake By: Permit Description: Current Legal Land Use: Permit#: Zoning District:	List materials to be stored in the on separate sheets and shall OW ALL streets abutting lot o lot lines. (Building Permit A for Building Department L Date: Date: Prop Date Permit Issued: Zoning C No (attach zoning of	e building: show all easement, indicate front of oplication Continu- Jse Only Fees Due: posed Use: Permit Co Grant(s): clearance)	ts and measurements lot, show all building es on Next Page) DngBld?
Proposed No. of Employees: PLOT PLAN SHALL BE submitted of (must be correct and in detail). SHO existing and proposed distances to Intake By: Permit Description: Current Legal Land Use: Permit#: Zoning District: Lots Combined? Yes Revised Cost (revised permit applica	List materials to be stored in th on separate sheets and shall OW ALL streets abutting lot o lot lines. (Building Permit A cor Building Department L Date: Date: Prop Date Permit Issued: Zoning C No (attach zoning of tions only) Old \$	e building: show all easement, indicate front of oplication Continue Jse Only Fees Due: possed Use: possed Use: Permit Continue Grant(s): tlearance) New	ts and measurements lot, show all building es on Next Page) DngBld? ost: \$
Proposed No. of Employees: PLOT PLAN SHALL BE submitted of (must be correct and in detail). SHO existing and proposed distances to permit Description: Current Legal Land Use: Permit#: Zoning District: Lots Combined? Yes	List materials to be stored in the on separate sheets and shall OW ALL streets abutting lot o lot lines. (Building Permit A for Building Department L Date: Date Permit Issued: Zoning C No (attach zoning of tions only) Old \$ Date:	e building: show all easement, indicate front of oplication Continu Jse Only Fees Due: Fees Due: Permit Continu Coosed Use: Permit Continu Contentiation Permit Continu Permit Con	ts and measurements lot, show all building es on Next Page) DngBld? ost: \$

IDENTIFICATION (All Fields Required)

Name: Neal Check						pplicant
		Со	mpany Name	Rainc	heck Fo	orest LLC
Address: 28715 Greenfield	dt	City	:Southfield	St	ate: MI	Zip: 48076
Phone: 2484405996			bile: N.A.			
Driver's License #: C200626					ckllc.co	m
Contractor Contra	ictor is Permi	t Applicant				
Representative Name: Kevi	n Monahan		Company Nai	_{ne:} The	Monah	an Company
Representative Name: Kevin Address: 21321 Kelly Rd		City	Eastpoint	St	ate: MI	Zip: 48021
Phone: 586.774.3800	Mobile: 58	36.344.9072	Email	kevin@)themon	ahanco.com
City of Detroit License #: L	C2005-004	61 Expires	12.31.22			
			Tenant is Pern	nit Applic	ant	
Name:						
				····		
ARCHITECT/ENGINEEI			Architect/End	gineer/Cc	nsultant i	s Permit Applica
Name: Jeffrey Klatt	-					
Address: 2120 E 11 Mile F		City	Royal Oak	C	ate MI	Zip: 48067
Phone: 248.414.9270	Mobile 58	36.556.991	0 Ema	il.jeff@krie	gerklatt.com	jessica@kriegerklatt.
HOMEOWNER AF	FIDAVIT (O	nly required fo	r residential per	mits obtaiı	ned by hor	neowner.)
Print Name:(Homeo						
Print Name: (Homeo Subscribed and sworn to befor	e me this	day of	20	A.D.		County, Michig
	e me this	day of	20	A.D.		County, Michic
Subscribed and sworn to befor	e me this (Notary Public)	day of	20 My Cor	_A.D nmission		County, Michig
Subscribed and sworn to befor Signature:	e me this (Notary Public) PERMIT	day of	20 My Cor T SIGNATUR	_A.D nmission E	Expires:	_County, Michig
Subscribed and sworn to befor Signature: I hereby certify that the infor restrictions that may apply to certify that the proposed wo to make this application as t all applicable laws and ordin inspections are requested a the previous inspection and	e me this	day of APPLICAN is applicatio ction and an ed by the ov owner(s) auth adiction. I an ed within 18 ed permits c	20 My Con T SIGNATUR In is true and on aware of my wher of the re orized agent aware that aware that 30 days of th annot be	A.D nmission E correct. I v respons cord anc . Further a permit e date o	Expires: have rev sibility th I have b I agree t t will exp f issuance	County, Michig viewed all deer ereunder. I been authorize to conform to bire when no
Subscribed and sworn to befor Signature: I hereby certify that the infor restrictions that may apply to certify that the proposed wo to make this application as t all applicable laws and ordin inspections are requested a the previous inspection and	e me this	day of APPLICAN is applicatio ction and an ed by the ov owner(s) auth adiction. I an ed within 18 ed permits c	20 My Con T SIGNATUR In is true and on aware of my wher of the re orized agent aware that aware that 30 days of th annot be	A.D nmission E correct. I v respons cord anc . Further a permit e date o	Expires: have rev sibility th I have b I agree t t will exp f issuance	County, Michig viewed all deer ereunder. I been authorize to conform to bire when no te or the date
Subscribed and sworn to befor Signature: I hereby certify that the infor restrictions that may apply to certify that the proposed wo to make this application as ti all applicable laws and ordin inspections are requested a	e me this (Notary Public) PERMIT mation on th o this constru rk is authorize ne property c ances of juris and conducte d that expire	day of APPLICAN is applicatio ction and an ed by the ov owner(s) auth adiction. I an ed within 18 ed permits c Signature:	20 My Con T SIGNATUR In is true and on aware of my wher of the re orized agent aware that aware that 30 days of th annot be	A.D nmission E correct. I v respons cord and . Further a permit e date o	Expires: have rev sibility th I have b I agree t t will exp f issuand	County, Michig viewed all deer ereunder. I been authorize to conform to bire when no te or the date
Subscribed and sworn to befor Signature: I hereby certify that the infor restrictions that may apply to certify that the proposed wo to make this application as ti all applicable laws and ordin inspections are requested a the previous inspection and Print Name: Jeffrey Klatt (Permit Ap	e me this (Notary Public) PERMIT mation on th o this constru rk is authorize ne property c ances of juris and conducte d that expire plicant) 0275704	day of APPLICAN is applicatio ction and an ed by the ov owner(s) auth adiction. I an ed within 18 ed permits c Signature:	20 My Con T SIGNATUR In is true and on aware of my viner of the re- torized agent aware that 30 days of the annot be Jeff Klatt Expiration: 0	A.D nm ission E correct. I (respons cord and . Further a permit e date o	Expires: have rev sibility th I have b I agree t t will exp f issuand	County, Michie viewed all deer ereunder. I been authorize to conform to bire when no te or the date Date: 02.14.20
Subscribed and sworn to befor Signature: I hereby certify that the infor restrictions that may apply to certify that the proposed wo to make this application as ti all applicable laws and ordin inspections are requested a the previous inspection and Print Name: <u>Jeffrey Klatt</u> (Permit Ap Driver's License #: <u>K430390</u> Subscribed and sworn to befor	e me this (Notary Public) PERMIT mation on th o this constru rk is authorize ne property c ances of juris and conducte d that expire plicant) 0275704 e me this	day of is applicatio ction and an ed by the ov owner(s) auth adiction. I an ed within 18 ed permits c Signature: 	20 My Con T SIGNATUR In is true and on a ware of my orner of the re- iorized agent aware that BO days of the annot be Jeff Klatt Expiration:20 20	A.D nm ission correct. I v respons cord anc. Further a permit e date o Jour 2020 000000000000000000000000000000000	Expires: have rev sibility th I have b I agree t t will exp f issuant issuant 225	County, Michig viewed all deed ereunder. I been authorized to conform to Dire when no te or the date Date: 02.14.20 County, Michig
Subscribed and sworn to befor Signature: I hereby certify that the infor restrictions that may apply to certify that the proposed wo to make this application as ti all applicable laws and ordin inspections are requested a the previous inspection and Print Name: <u>Jeffrey Klatt</u> (Permit Ap Driver's License #: <u>K430390</u> Subscribed and sworn to befor	e me this (Notary Public) PERMIT mation on th o this constru rk is authorize ne property c ances of juris and conducte d that expire plicant) 0275704	day of is applicatio ction and an ed by the ov owner(s) auth adiction. I an ed within 18 ed permits c Signature: 	20 My Con T SIGNATUR In is true and on aware of my viner of the re- torized agent aware that 30 days of the annot be Jeff Klatt Expiration: 0	A.D nm ission correct. I v respons cord anc. Further a permit e date o Jour 2020 000000000000000000000000000000000	Expires: have rev sibility th I have b I agree t t will exp f issuant issuant 225	County, Michig viewed all deed ereunder. I been authorized to conform to Dire when no te or the date Date: 02.14.20 County, Michig
Subscribed and sworn to befor Signature: I hereby certify that the infor restrictions that may apply to certify that the proposed wo to make this application as ti all applicable laws and ordin inspections are requested a the previous inspection and Print Name: Jeffrey Klatt (Permit Ap Driver's License #: K430390 Subscribed and sworn to befor Signature: (Nota Section 23a of the prohibits a person state relating t	e me this (Notary Public) PERMIT mation on th o this constru- rk is authoriz- ne property c ances of juris and conducte d that expire plicant) 0275704 e me this ry Public) e state const o persons w	day of is applicatio ction and an ed by the ov owner(s) auth adiction. I an ed within 18 ed permits c day of day of day of day of day of day of day of day of day of day of 	20 My Con T SIGNATUR In is true and on a ware of my viner of the re- torized agent a ware that 30 days of the annot be Jeff Klatt Expiration: 20 20 Commission E e act of 1972 cumvent the	A.D	Expires: have rev sibility th l have b l agree t t will exp f issuand by Jeff Koat 14 1622710 025 025	County, Michie viewed all deer ereunder. I been authorize to conform to bire when no ce or the date Date: 02.14.20 County, Michie County, Michie County, Michie County of this building or a
Subscribed and sworn to befor Signature: I hereby certify that the infor restrictions that may apply to certify that the proposed wo to make this application as ti all applicable laws and ordin inspections are requested a the previous inspection and Print Name: Jeffrey Klatt (Permit Ap Driver's License #: K430390 Subscribed and sworn to befor Signature: (Nota Section 23a of the prohibits a person state relating t	e me this (Notary Public) PERMIT mation on th o this constru rk is authoriz- ne property c ances of juris and conducte d that expire plicant) 0275704 e me this 0275704 e state const o persons w al structure.	day of is applicatio ction and an ed by the ov pwner(s) auth adiction. I an ed within 18 ed within 18 ed permits c 	20 My Con T SIGNATUR In is true and on a ware of my vner of the re- norized agent a ware that 30 days of the annot be Jeff Klatt Expiration: 0 20 Commission E e act of 1972 cumvent the erform work ection 23a a	A.D	Expires: have rev sibility th I have b I agree t t will exp f issuand ty Jerroat 14 1622710 025 025 A230, N g requir idential ct to civ	County, Michig viewed all deed ereunder. I been authorized to conform to bire when no to conform to conform to bire when no to conform to conform

EXISTING CONDITION PHOTOGRAPHS

92 E. FOREST DETROIT, MI 48201

Refer to the following pages for images of trim, entries, gutters, and ramp which are to be repaired or replaced in kind. Elevations are provided for context, windows and door design will be addressed in a separate submittal and are <u>NOT</u> included in this application.

North (Front) Façade (E. Forest Avenue)

• Pages 10–12

<u>West Façade (Parking Lot)</u>

• Pages 13–15

<u>South Façade (Alley)</u>

• Pages 15

<u>East Façade</u>

• Pages 15–16


North Facade

Front façade—Full View (Note plywood is still in place at upper section of windows). Stone surround to be repaired



<u>North Facade</u>

Detail at upper gable section (Note protective plywood still in place at upper portion of glazing)

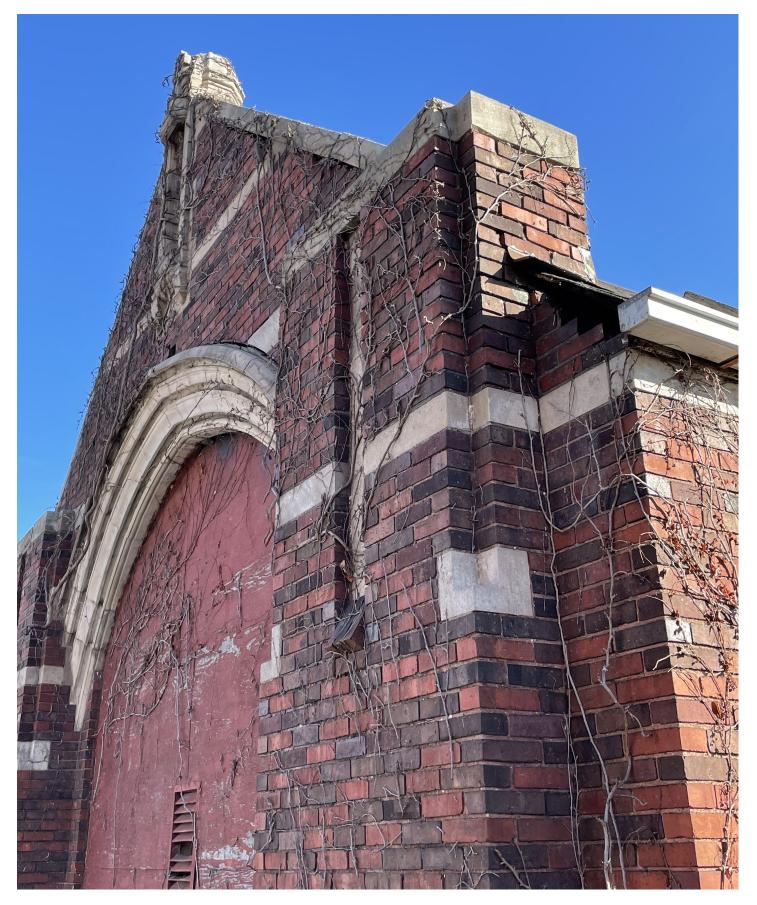

<u>North Facade</u>

Detail at top of stone surround, security bars to be removed from doors



<u>North Facade</u>

Detail at porch cap, steps and side walls. Stone to be removed, repaired, and replaced .



<u>North Facade</u>

Grade level view of stone entrance surround. Stone to be removed, repaired, and replaced.



<u>West Facade</u>

Full Image of West Façade, new basement entry, ramp repair.



<u>West Facade</u>

Full Image of West Facade , new site work, ramp repair.



<u>West Facade</u>

Detail at non-historic pedestrian door and ramp. Ramp to be brought up to code with new rail system, door to be replaced



South and West Facade

View of corner of façade from Alley



<u>West Facade</u> Detail at Parged Addition



<u>East Facade</u> Full view of facade



East Facade Detail at Parged Addition



NEW ENTRY DOORS

92 E. FOREST DETROIT, MI 48201

The following sheets indicate intent for new entry doors at the original Forest Street Façade, Side Entry, and a new below grade electrical meter room door. Refer to Exhibit A for extent.

The Entry doors are to be fabricated from solid wood with vertical slats. From our research, we believe that the original main doors were solid wood arched doors that consumed the full height of the arch at the front entry. A similar door will be fabricated to match for the side entry door from the ADA entrance in the parking lot. The renderings in Exhibit A give a schematic representation of what we believe the original doors would have looked like. KKA will work with city staff on final door and hardware details.

Refer to "Exhibit A" for plans and elevations.

<u>A. Main Entry Door</u>


Pages 18–19 (See Elevations and Renderings as well as Appendix A for general design intent)

<u>B. Side Entry Door</u>

Page 20–21 (See Elevations and Renderings as well as Appendix A for general design intent)

<u>C. New Electrical Meter Room Exterior Door (in Exterior Stairwell)</u>

Page 22 (Cut Sheet is shown for general type. This door is not visible from the street as it sits below grade within the stairwell, wood look pattern with approximate color match to entry doors).

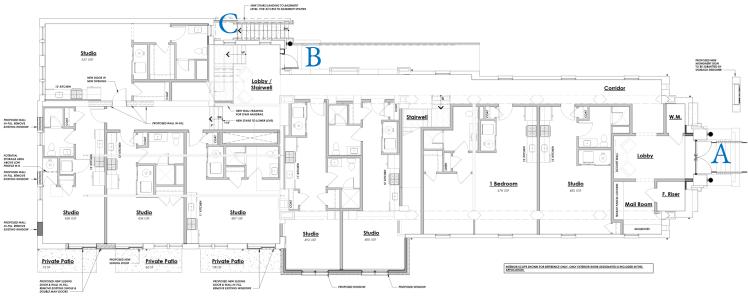


A. Proposed Forest Ave. Entry Door


Proposed Front Entry Door is to have a solid-core V-Groove face within a style and rail system.

The hardware selections are still being finalized, but will be accessible and match the style intent shown in the adjacent sconce. This hardware will be electronically locked for secured access.

Final shop drawings will be submitted to HDC Staff.

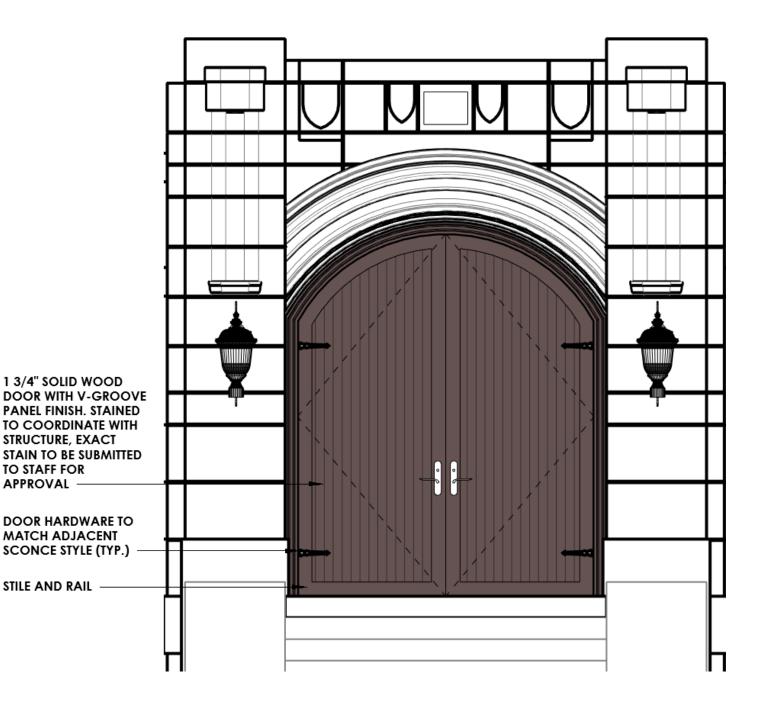

A. Proposed Forest Ave. Entry Door

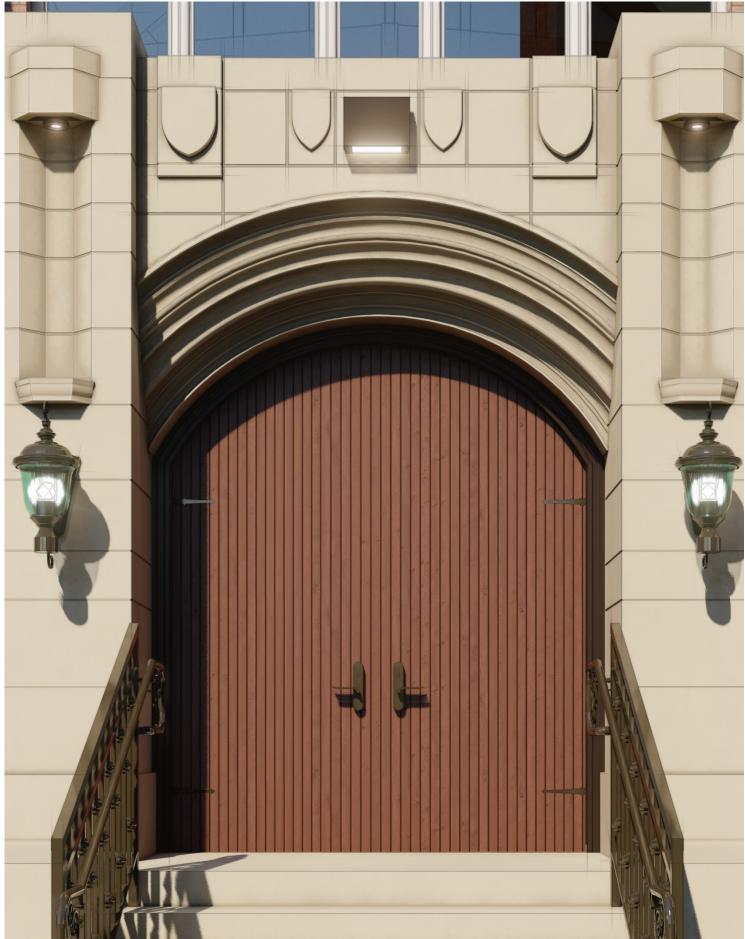


B. Proposed Side Entry Door


Proposed Side Entry Door is to have a solid-core V-Groove face within a style and rail system. This side entry door will have a vision panel to be able to see if the ramp is in use.

The hardware selections are still being finalized, but will be accessible and match the style intent shown in the adjacent sconce. This hardware will be electronically locked for secured access.

Final shop drawings will be submitted to HDC Staff.

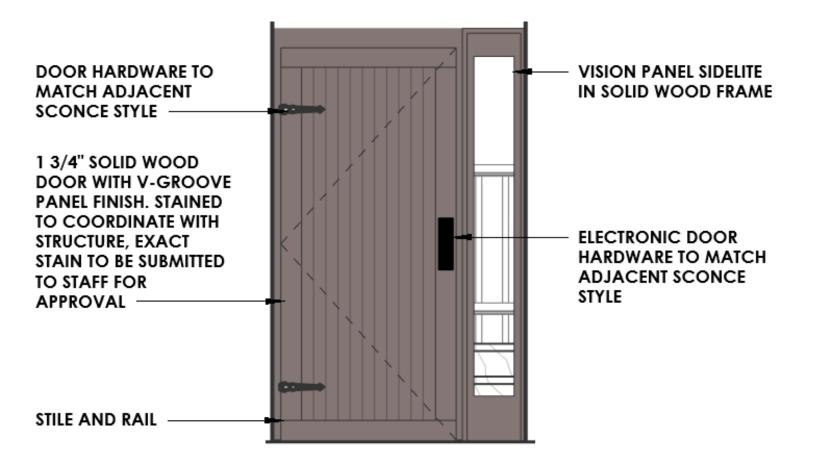

B. Proposed Side Entry Door

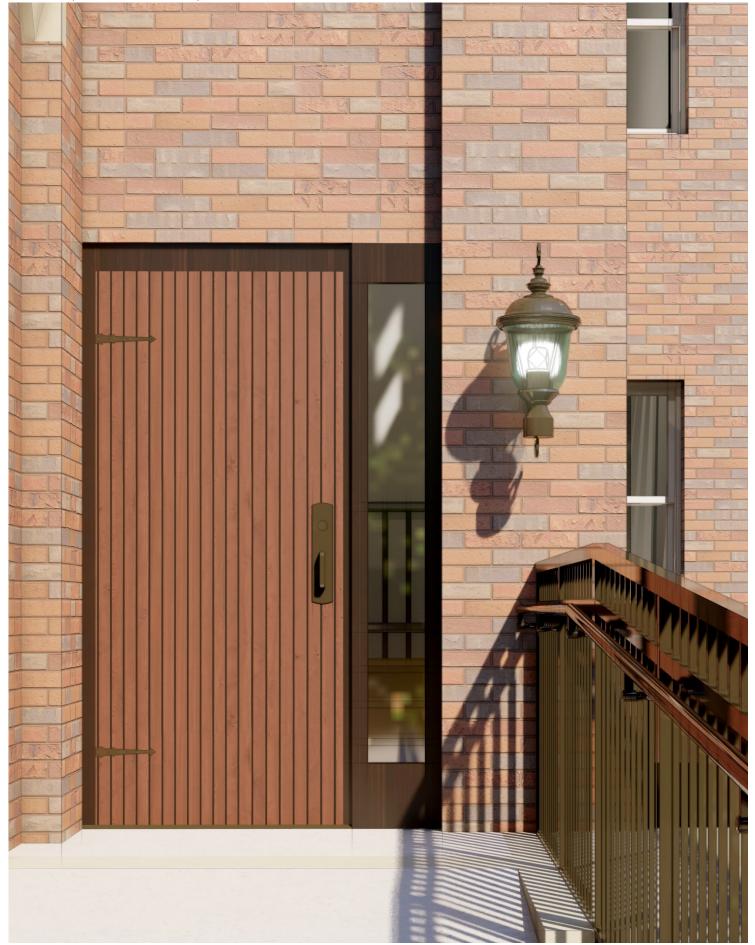

6 **CURRIES** 747 Door Construction Door Technical Data ASSA ABLOY September, 2014 12 GA. (2.6) HINGE CHANNEL 14 GA. (1.9) CLOSER REINFORCEMENT CHANNEL (OPTIONAL) **RIBS WELDED TOGETHER AT** * 6" (152) MAXIMUM SPACING ENDS 16 GA. (1.4) TOP END CHANNEL FIBERGLASS INSULATION 14 GA. (1.9) LOCK CHANNEL LOCK PREPARATION **RIB PROFILE MAY VARY DEPENDING ON** STIFFENER APPLICATION AND GAUGE. AS REQUIRED 22 GA. (.75) RIBS STANDARD 20 GA. (.9), 18 GA. (1.2), 16 GA. (1.4) (OPTIONAL) 18 GA. (1.2), 16 GA. (1.4) OR 14 GA. (1.9) FACE SKINS SPOT WELDED TO RIBS Cocoa AT 6" (152) MAX. SPACING 16 GA. (1.4) BOTTOM END CHANNEL |ava

A STEEL STIFFENED DOOR DESIGN IS AVAILABLE WITH A 450° TEMPERATURE RISE FIRE RATING ON PAGE 169.

Experience a safer and more open world

WINDOW EVALUATION REPORT

92 E. FOREST DETROIT, MI 48201

Refer to the following Report and Drawing Set for additional information.

<u>Elevations with Window Designations</u> Pages 24–26

<u>Window Report From North Coast Window Works</u> Page 27-39

<u>Proposed Replacement Double Hung</u> Page 40 (To match window approved in Staff Report #22-7716 (92 Forest)

South Elevation with Window Tags




North Elevation with Window Tags



East Elevation with Window Tags



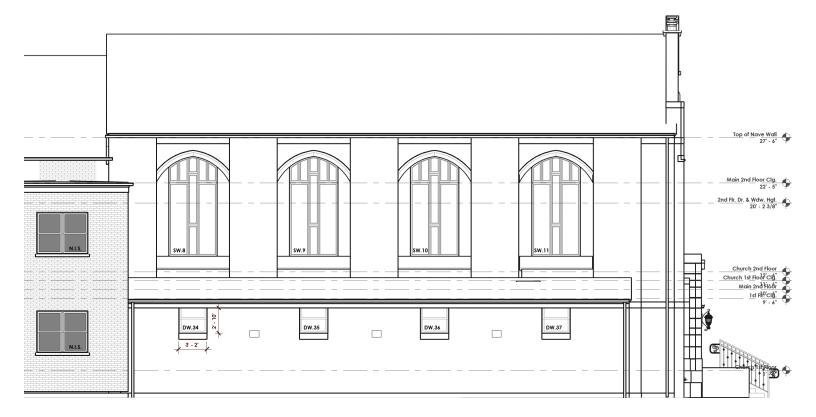

West Elevation with Window Tags





Proposal: Window Evaluation & Restoration Plan 92 Forest Detroit, MI 48201

- Prepared For: Kevin Monahan The Monahan Company 21321 Kelly Rd. Eastpointe, MI 48021
- Submitted By: Peter Carroll, President North Coast Window Works, Inc. 5111 E. ML Ave., Suite A140 Kalamazoo, MI 49048

Date: May 5, 2022

April 22, 2022

Introduction

In accordance with a request from Kevin Monahan, North Coast Window Works, Inc. (NCWW) was requested to evaluate the windows and develop a restoration plan at 92 Forest, Detroit, MI, which is located within a Local Historic District. The findings of a preliminary evaluation of the windows follows.


To streamline the information, the plans and photos, submitted by Kreiger Klatt Architects, Royal Oak, MI, of the building facades and corresponding window numbering will be followed in the evaluation.

The building has undergone changes and additions over the years. Each with their own architecture and window types. The overall condition of the windows varies remarkably from the sanctuary to the nave. The report evaluation will outline window conditions based on groups, i.e. Sanctuary, Nave, with the appropriate window numbers from the plans and photos.

Window Opening & Conditions:

Sanctuary:

Windows: DW 1-4, DW 24 – 37 Type: Vinyl single hung Glass: Double Pane, Insulated (IGU) Condition: Fair/Poor

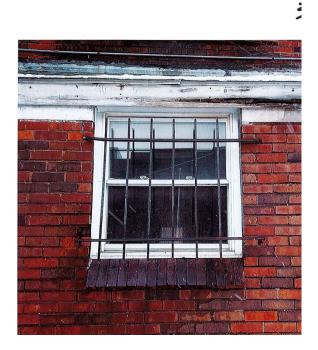

Notes: These windows are non-contributing to the original architecture. They are replacement windows of low quality. Exterior brick molding does not match original. Broken glass and broken window elements visable

Windows: FW 1-3 (9 Windows) Type Vinyl single light non-operable Glass: Double pane, IGU Condition: Fair



Notes: These windows are non-contributing to the original architecture. They are replacement windows of low quality. Missing sash. Exterior brick molding does not match the original.

Window Opening & Condition (cont):

Windows: SW 1 – 11, NW 1-2 Type: Gothic Arched, Multi-lighted. Glass: Single glazed Condition: Fair/poor








Notes: These windows are very significant to the original architecture. The wood substrate is in good condition. The Secretary of Interior, National Park service rating for these windows is 2. The paint is failing. The sills are solid, the exception being NW 1-2. The glass appears to be set in a metal frame then inserted against the exterior wood trim and fixed in place with stops on the interior. Most glass is single pieced cut to the opening, the exception being the large side lights on the bottom portion of each window. Bottom 2 openings in the case of SW 2. Each of these openings are metal framed rectangle shaped panels with 2 horizontal muntins. The long slender opening on the bottom between the larger openings also appear to be metal framed with a horizontal muntin, but on some windows this has been replaced with one piece of glass/plastic. The metal frames are in advanced stage of deterioration and non-existent in some openings due to water infiltration. The glass is mostly broken and replaced with a variety of substances, clear glass, plastic, plywood, or nothing at all. (photos) It is unclear if any of the bottom lights open for ventilation. It is unclear if any of the glass is original to the structure. There are missing architectural elements on the exterior woodwork, namely the medallions and in the case of NW 1-2, the sills. Otherwise, the exterior architectural trim is remarkable intact as it had protective plywood covers. The sills have benefitted from being covered with roofing material. Nave:

Windows: DW 5 – 33 Type: Wood Double Hung, 1/1 light Glass: Single pane Condition: Fair, mostly poor.



These windows appear to be all the same generation. Perhaps as a result of the addition in the 1940. Many windows are mullioned. Many are separate. These windows would fit into the age determination for historical significance and would qualify as contributing. Rating by The Secretary of Interior, National Park Service would be category 3 for poor, (15 windows) and category 2 for fair (9 windows) These windows are mostly in poor condition and appear to have not had the maintenance and protection of the sanctuary windows. The worst are the windows on the South Façade, followed by the east. The windows in fair condition are on the north and west facades of the nave. These windows appear to have been exposed to the elements with no evidence of resent maintenance. The paint has failed. The glazing has failed. The window sash joinery is loose, and in some instances, deteriorated. The glass needs stained and painted. Lower jambs, brick molding and sills are in poor condition throughout. Sashes missing on the west side windows. All sash ropes are missing. Unable to determine if the windows are single hung or double hung as the top sashes are sealed shut. There appears to be no sash weatherstrips. Existing hardware and pulleys are of a low quality, stamped metal. Most locking hardware is missing. Interior milled profile are deteriorated due to UV penetration. A few storm windows remain. They are in poor condition and low quality. The overall impression of these windows based on the wood, deterioration, hardware, pulleys, joinery and lack of weather seals is that they were not of high quality originally when originally installed.

Typical "fair" Condition. DW 5 -10 & DW 26 -29

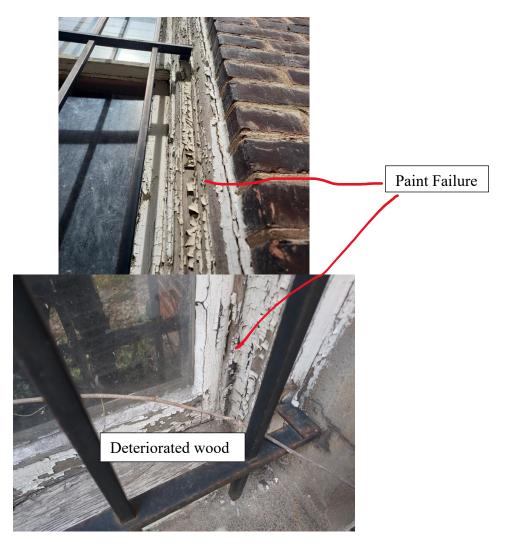

Typical "poor" DW 11-22 & DW 30 -33



Extreme deterioration from exposure

Deteriorated jamb, sill, sash & brick mold





Rotted/Missing sills

A potential plan to maintain the integrity of the windows for the buildings new use.

For HDC consideration and Approval

- 1. Non-contributing windows. DW 1-4, DW 24 37.
 - a. Not covered in the Secretary of Interior's Standards for preservation. Possibly Number 3
 - b. Remove vinyl windows back to the rough opening. Replace with new wood windows, 1/1 light, aluminum clad exterior, insulated glass with replicated brick mold. New sills where necessary.
- 2. Non-contributing windows: FW1-3
 - a. Not covered in the Secretary of Interior Standards for preservation. Possibly number 3.
 - b. Remove vinyl windows back to the rough opening. Replace with nonoperable wood windows, aluminum clad exterior, single light, Insulated glass & replica brick molding. New sills where necessary.
- 3. Sanctuary: Contributing Original Windows. SW 1-11, N 1-2
 - a. Restore windows. Secretary of Interior Standards for Preservation 5 & 6.
 - b. Refinish wood
 - c. Dutchman/Epoxy repairs where needed
 - d. Replicate missing elements Medallions & sills.
 - e. Replace glass. Insulated is possible with adjustment made to the inside stops.
 - f. Replicate as close as possible metal framed inserts out of aluminum. Possibly add an opening, hopper window for ventilation considering the building new use.
- 4. Nave: Contributing Windows DW 5-33
 - a. Option 1: Restore Window. Secretary Of Interiors Standards for Preservation 5 & 6
 - i. "Poor" rated windows replaced with replica (15 windows)
 - ii. "fair" rated windows refinished, repaired, & restored. (9 windows)
 - iii. New openings to have new windows.

- b. Option 2: Replace windows with new due to deterioration. Secretary Of Interiors Standards for Preservation number 9.
 - i. Old windows removed back to rough opening.
 - ii. New sill installed.
 - iii. New wood windows installed with replicated brick molding. Windows to match the new openings and the non-contributing window replacements. New windows to match the size, shape, and scale of the current windows.

Summary Comments:

This historic building has had window modifications/replacements in the past. Some windows are original to church, some now contributing based on time and some are non-contributing. So perhaps a discussion should be divided into these three areas; non-contributing windows, original contributing and architecturally relevant windows, and now contributing deteriorated common single/double hung windows.

First: The non-contributing vinyl windows.

The non-contributing vinyl windows do not conform to the architecture in shape size and scale and should be replaced. These windows where inserted in the existing original window jamb, reducing the overall window size. The exterior trim is widened to account for the installation. This does not fit with the remaining window trim. Removing the vinyl windows, removing the old jamb back to the rough opening, then installing a replica window with replicated brick molding would restore the opening back to its original dimensions, shape, and scale.

Second: The original, architecturally significant and contributing windows.

These are principally in the sanctuary. These windows should be restored to maintain the church's architecture, historic integrity and place in time. The basic substrate of the windows is in restorable condition. The plywood coverings installed over these windows helped tremendously to slow the deterioration of the wood. The quality of the wood is excellent old growth white pine. The wood is superior to the type of wood available today and it will refinish very well. New pieces will replicate the missing or deteriorated. Thus, the shape, configuration, and scale of these windows as they relate to the building will be preserved.

Third: The contributing single/double hung windows.

These windows are principally in the 1940 Nave addition. Option 1 supported by the Secretary of the Interiors Standards for preservation 5 & 6 states contributing architectural elements should be maintained and restored. Unless they are deteriorated beyond reasonable repair. These windows have had little maintenance over the years. Most are in

advanced stage of deterioration. NPS classification number 3 which does allow for replacement windows providing they fit into the building original architecture with relation to size, configuration, and scale. Those in fair condition, category 2 will require extensive dutchman/epoxy repairs. The repairs, if undergone on these windows would be more temporary than permanent. The quality of the substrate wood is of a lower quality than the original wood in the Sanctuary. Epoxy repairs will not bond well to this wood through years of cyclic swelling and shrinking. As a result, the repairs will have to re-corrected in time. Restoring these windows would entail significant expense. Additional expense as the sashes will need to be weather sealed and a storm window added to the exterior or interior. As stated earlier, these windows do not appear to be made in a high-quality fashion with high quality materials originally. Restoring the few windows that could, would bring its' own set of issues. The exterior look mixing old and new to the nave might be disruptive to the overall architectural integrity/harmony of the exterior facades of the nave.

It would seem appropriate to replace these windows with new ones that match the scale, size and shape of the originals. New windows would not be easily seen from the street and the new development planned to the east. Allowing for insulated glass to improve energy performance would reflect the new use of the building without changing the look from the exterior. When considering new windows, again remove the old windows back to the original rough opening, replacing the sills, and installing new windows that match the originals in shape, size, and configuration. Then install replicated brick molding. These new windows would then match the treatments done to the non-conforming vinyl windows. Returning the building architecture the same the original while satisfying the standard for preservation and promoting its new use.

Submitted by

Peter Carroll, President North Coast Window Works, Inc. 5111 E. ML Ave, Suite A140 Kalamazoo, MI 49048

WINDOWS & DOORS

Pinnacle Double Hung & Glide-by

Features and Benefits

- The warmth and beauty of Clear Select Pine, Douglas Fir or Natural Alder; can be painted or stained
- Clad units offer a strong, durable extruded aluminum sash and frame for low maintenance; primed units offer the traditional appearance of decorative cellular PVC trim
- Glass is replaceable in case of damage
- Both tape and silicone glazed, with interior wood stops for superior strength and seal
- EZ Tilt operation available for easy removal and replacement of sash (double hung only)



- Both sashes tilt in with compression or concealed jambliner for easy cleaning
- Recessed lock and keeper for a sleek
 appearance



- Block and tackle balance system for ease
 of operation
- Prime double hung units come standard with cellular PVC trim, blind stop and sill
- No-finger pull option for hardware
 application

Sizes

Available in hundreds of standard and custom sizes

Glazing

- Windsor Glazing System provides 3/4" double pane insulated glass; Cardinal[®] LoE 366 glass standard; tinted, tempered, obscure and laminated glass available
- Glazed with tape and silicone sealant
- Custom and special glass types available
- Preserve protective film optional

Exterior Trim

- Clad windows available with WM 180 brickmould, Williamsburg, or 3-1/2" flat casing; 3/8", 1-1/4", 2-1/4" subsills
- Primed windows available with WM 180 brickmould, WM 180 brickmould with flange, williamsburg, 3-1/2" flat, 4-1/2" backband, 5-1/2" flat or plantation casing; double hung sill nose, 2" bull nose sill nose or belly sill nose
- All prime window trims, sill nose and outside stops are cellular PVC

Grilles

- Windsor Divided Lite (WDL) = simulated divided lite
- 7/8" and 1-1/4" Perimeter Grille (NOT
- available on radius double hung)
 7/8" and 1-1/4" Stick Grille
- 3/4" and 1" Profiled Inner Grille
- 13/16" Flat Inner Grille
- 7/8" and 1-1/4" Ogee WDL
- 5/8", 7/8", 1-1/4" and 2" Short Putty WDL
- 5/8", 7/8", 1-1/4" and 2" Short Contemporary WDL
- 2" Simulated Check Rail (DH picture only)
- Standard and custom grille patterns available

Finishes

- Interior Available in Clear Select Pine, Douglas Fir or Natural Alder
- Primed: white or black
- Painted: white, black or gray
 Stained: 9 color options
- Exterior Clad windows feature heavyduty extruded aluminum cladding on sash and frame; primed windows (double hung only) offer an assortment of traditional cellular PVC trim options

Clad Colors

All clad colors painted in-house with the highly durable AAMA 2604 standard finish, or upgrade to AAMA 2605 for the most challenging of environments

- 23 Standard Clad Colors available in 2604
 and 2605 finish
- 20 Feature Clad Colors available in 2604 and 2605 finish (Custom color matching is also available)
- 7 Matte Clad Colors available in the 2604 finish only

Hardware

Double hung lock available in champagne, white, bronze and black; optional finishes in faux bronze, oil rubbed bronze, satin nickel and bright brass

Performance Ratings

For current performance ratings, visit our website at windsorwindows.com and click on "Professional Information" in the menu bar



ROOF REPLACEMENT EVALUATIONS

92 E. FOREST DETROIT, MI 48201

The following includes the replacement evaluations, letter from roofing contractor, letter from the owner, and cut sheet of the new roof shingle.

Roof Replacement Application Pages 41–45

<u>Letter from the Owner</u> Page 46

Existing Slate Roof Condition Photos Pages 47–48

<u>Proposed Roof Cut Sheet and Photo (Shingle Shown is an Or Equal)</u> Pages 49–50

City of Detroit Historic District Commission

APPLICATION FOR REPLACEMENT OF HISTORIC ROOFING

Instructions: Please complete this application and return with your written estimates, documentation, and completed City of Detroit Application for Building Permit No. 2 to Detroit Historic District Commission, 2 Woodward Ave, Suite 808, Detroit, Michigan 48226. Please note that your application will not be processed until all the required information has been received.

Property Location: <u>92</u> (Number)	Foreest (Street)		
Property Owner. <u>RAINCH</u>	eck Forcest LLC	<u> </u>	
Owner Address: <u>28715</u> (Street)	Concertielis, Southist	(State)	<u> 48076</u> (Zip)
	<u>248 140 5 996</u> (Business)		
Applicant: Refer to Application		(1 ax)	
Applicant Address:			
(Street)	(City)	(State)	(Zip)
Telephone:			
(Home)	(Business)	(F ax)	
Signature of Applicant:			
		(Date)	

Application Deadline: Historic District Commission meets on the second Wednesday of each month. Application material must be completed and submitted three (3) Mondays before each Commission meeting.

Please use the enclosed criteria checklist as a guide to completing your application. Incomplete applications cannot be reviewed and will be returned to you for more information. If you have any questions or concerns, you may contact a Commission staff member at (313) 224-8907 or (313) 224-6543.

HDC Staff Use Only		
Date Received App. #	Date Action Taken Action	

Submittal Criteria Checklist

	A completed City of Detroit Application for Building Permit #2;
	A brochure or other information giving the color, materials, and dimensions of the proposed replacement roofing;
	Copies of two (2) written estimates from different companies for repair of the existing roofing material;
	Copies of two (2) written estimates from different comp anies for replacement of the roof with material to match the original;
	Copies of two (2) written estimates from different companies for replacement of the roof with an alternative (synthetic) material;
	Copies of two (2) written estimates for the cost to replace the roof with asphalt shingles;
	Detailed photographs showing deterioration of the original roofing (if you cannot provide photos, Commission staff can take the photos by appointment at your request); and
	A letter from the owner or occupant statin g why the siding must be replaced.
Copies	of actual written estimates are <u>REQUIRED</u>
Repair	Estimate #1 \$ Not REPAirchhic Company Name Esto Roofing
Repair	Estimate #1 <u>\$ Not Repairshic</u> Company Name <u>Esto Roofing</u> Estimate #2 <u>\$Not Repairshik</u> Company Name <u>Rubben Barby</u> Roofing
Replace	ement to Match #1 \$ 3%,000 Company Name Eska
Replac	ement to Match #2 \$ 300,000 - Company Name Rubber Butby
Alterna	te Material Replace #1 \$25000 Company Name ESKO
Alterna	te Material Replace #2 \$ <u>/90,000</u> Company Name <u>Rybber Broby</u>
	t Shingles #1 \$ <u>79,000</u> Company Name <u>ESEC</u> t Shingles #2 \$ <u>99,000</u> Company Name <u>Ryblen Back</u>
	red Action: Cost \$ <u>78,000</u>

Company Name Rhober Bubby - Dimensional Shingles

May 16, 2022

Historic District Committee City of Detroit Attn: Jennifer Ross (313) 224-1762 hdc@detroitmi.gov

To the members of the HDC,

Upon a second inspection of the existing slate roof at 92 E. Forest, we have again concluded that the sanctuary roof is beyond repair and that the best course of action for the longevity of the project and preservation of the roof structure below is to remove the deteriorated slate roof and replace the roof and rotted deck boards with a new roof.

It is our recommendation that the replacement roof consist of an insulation underlayment and the Slateline Shingle. The Slateline Shingle will give the appearance of real slate while matching the shingles on the remainder of the sloped roofs and will be a much safer process of repairs in the future.

We have prepared, in conjunction with Krieger Klatt Architects, the following roof conditions report in support of the above conclusion that the existing roof is beyond compare. The following points were evident at the time of both inspections.

- 1. The existing slate tiles are degraded beyond a salvageable state, repairing only damaged slate would be extremely dangerous given the brittle, cracking, and thin profile of the existing slate.
- 2. In comparing the existing tile thickness, based on tiles that have been damaged from wear and fallen off the roof system and into the gutters, to current slate tile standards the existing tile is more than $1/6^{th}$ of the thickness. This eliminates the ability to repair the damage.
- 3. Due to the change of use, the project requires a layer of continuous insulation underneath the roof system before the exposed ceiling deck below. The construction of the slate shingle prevents this action while the Slateline shingle accepts it within the system.
- 4. In the attached videos, you will be able to hear the difference between what the sample of new slate sounds like and what the existing slate sounds like. This sound test is used in testing the life and condition of slate tiles within the industry. The test results conclude that the current slate is beyond salvageable life.

In conclusion, it is our expert opinion that the existing slate roof cannot be repaired and that due to the new use of the building, and the former approval of the Slateline shingles on the other sloped roofs of the project by the Historic District Commission, that the replacement roof be of the Slateline shingles with the final color selection to be the color that matches the Slate's original color.

Regards,

ustin Binzer

Superintendent Esko Roofing & Sheet Metal, Inc,

PRO	POSAL
ESKO ROOFING & SHEET METAL, II	NC. Proposal: #5290
4000 SIMONE	Date: 01/19/2022
SHELBY TWP, MI. 48315 Phone: (586) 532-1950 Fax: (586) 532-1973	
	Sheet no.
roposal Submitted To: Kevin Monahan Name: Name: The Monahan Company	Work to be performed at:
Street: 21321 Kelly Road	Job Name: Building Street: 92 Forest
City: Eastpointe, MI 48021	City: Detroit, MI 48124
Phone: 586-774-3800 Fax: 586-774-2530	E-Mail: Kevin Monahan <kevin@themonahanco.com></kevin@themonahanco.com>
Base Bid : Budgetary quote for the following:	
Remove existing asphalt and slate shingles and replace wit	th the following:
Asphalt shingles \$130,000.00	
Synthetic Shingles \$250,000.00	
Slate Shingles \$340,000.00	
Any alteration or deviation from above specifications involving extra	Respectfully submitted: Steve Eskelinen
costs, will be executed only upon written orders, and will become an extra charge over and above the estimate. All agreements contingent	
upon strikes, accidents or delays beyond our control. Owner to carry fire, tornado, and other necessary insurance upon above work.	Steve Eskelinen
Workmen's Compensation and Public Liability Insurance on above work to be taken out by:	Note: This proposal may be withdrawn by us if not
ESKO ROOFING & SHEET METAL, INC.	Accepted within 30 days.
ACCEPTANC The above prices, specifications and conditions are satisfactory a	CE OF PROPOSAL nd are hereby accepted. You are authorized to do the work as
Specified. Payment will be made as outlined above.	
Date: Sigr	nature

Signature

32677 Utica Road • Fraser, MI 48026 • (586) 293-6926 • FAX (586) 293-7663/ROOF BID PROPOSAL JOB: 92 E.Forest - Renovation DATE: January 25, 2022 DATE: January 25, 2022

We at Rubber Baby Roofing, Inc. submit the following Bid Proposal; for your review and or acceptance. **Project:** <u>Renovations - 92 E. Forest Ave. Detroit, MI 48201</u>

System:_	Shingle Roofing Systems - Complete Tear-off of all old Roofing.
-	Includes - ice shield, underlayment, drip edge, ridge-vent, all flashings.
	clean & haul all debris. / some wood replacement
Options:_	1.0 Asphalt Shingles \$98,000.00
-	2.) Synthetic Slate Shingles \$190,000.00
	3.) Slate Shingles \$300,000.00
Extras:	Gutters & Downspouts 7 Aluminum Trim
***	Add-on Cost for Flat Roof Sections - New FPDM Rubber Roofing \$35,000.0
Total Cos	t of Project:
	akdown:
Cost Brea	akdown:

Rubber Baby Roofing to furnish all labor, materials, insurances, supervision, expertise and installation of the system in a professional and timely manner. Timely manner contingent not only upon weather; but also the general contractor meeting all requirements for Rubber Baby Roofing to install the system correctly. Coordinating with Rubber Baby Roofing the other trades with the job so as to not want demand and expect Rubber Baby Roofing to waste it's time if areas of roof are not ready for installation. Payment to be made within the terms of the contract R. B. R. signs, but when terms are not held to by the general contractor/Owner a 1% per month charge after 60 days past due billing and draws will be imposed.

All changes to be in writing and no work will ever start until both parties have authorized signatures and both parties are in possession of the change order and acceptance, by all concerned.

Rubber Baby Roofing, Inc., respectfully submits the above proposal if any of the options or extras are desired they should be included as part of the original contract. Though they may be requested at a later time.

Please call or FAX our office at the numbers above.

Acceptance: Rubber Baby Roofing, Inc. pomat & Ulas ___ Date:_____ Date: _____ Contractor/Owner:

City Of Detroit Historic District Commission 2 Woodward Ave #808, Detroit, MI 48226

February 1, 2022 Re: 92 Forest

To Whom It May Concern:

Good day. I have been advised by two reputable roofing contractors as well as my General Contractor, that 100% of the roof at 92 Forest is beyond salvaging or repair.


Please feel free to reach out to me with any questions or concerns.

Sincerely,

Neal Check RainCheck Forest LLC (DBA 92 Forest) 28715 Greenfield Rd Southfield, MI 48076 248-866-7900

East Slate Roof

View of missing, cracked and delaminated slate tiles, slate that has fasteners corroding through.

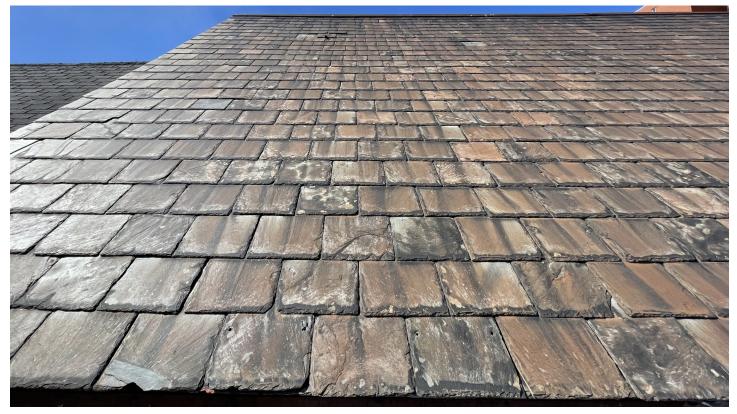

East Slate Roof

View of missing, cracked and delaminated slate tiles, slate that has fasteners corroding through.



East Slate Roof

Close-up View of damage showing thinness of existing slate system, new slate will not fit in overall.



East Slate Roof

Panoramic View of the East Roof. West Side has additional damage. Refer to Roof Plan for locations.



10/26/2015

PRODUCT INFORMATION SHEET

Slateline[®] Shingles The Look of Slate... At A Fraction Of The Cost



PRODUCT INFORMATION

"Slateline's bold shadow lines and tapered cut-outs create the appearance of depth and dimension."

Slateline[®] Value Collection Lifetime Designer Shingles Offer You These Great Benefits:

- Affordable Luxury ... Slateline[®] Shingles are only a fraction of the cost of traditional slate or wood shakes
- Sophisticated Design ... Artisan-crafted shapes combined with oversized tabs and a dimensional design result in a sophisticated beauty unmatched by typical shingles
- Custom Color Palette . . . Specially formulated color palette is designed to accentuate the shingle's natural appeal
- High Performance ... Designed with Advanced Protection[®] Shingle Technology, which reduces the use of natural resources while providing excellent protection for your home (visit gaf.com/aps to learn more)
- StainGuard[®] Protection . . . Helps ensure the beauty of your roof against unsightly blue-green algae1

- Highest Fire Rating . . . Class A fire rating . from Underwriters Laboratories
- Stays In Place . . . Dura Grip[™] Adhesive seals each shingle tightly and reduces the risk of shingle blow-off. Shingles warranted to withstand winds up to 130 mph (209 km/h)!2
- The Ultimate Peace Of Mind . . . Lifetime Itd. transferable warranty with Smart Choice® Protection (non-prorated material and installation labor coverage) for the first ten years³
- Perfect Finishing Touch . . . For the best look, use Timbertex[®] Premium Ridge Cap Shingles with StainGuard[®] protection⁴

¹See GAF Shingle & Accessory Ltd. Warranty for complete coverage and restrictions.

²This wind speed coverage requires special installation; see GAF Shingle & Accessory Ltd. Warranty for details. ³See GAF Shingle & Accessory Ltd. Warranty for complete coverage and restrictions. The word "Lifetime" refers to the length of coverage provided by the GAF Shingle & Accessory Ltd. Warranty and means as long as the original individual owner(s) of a single-family detached residence [or the second owner(s) in certain circumstances] owns the property where the shingles are installed. For owners/structures not meeting the above criteria, Lifetime coverage is not applicable. ⁴These products are not available in all areas. See www.gaf.com/ridgecapavailability for details.

COLORS/AVAILABILITY

- COLORS: Antique Slate, Emerald Green, English Gray, Royal Slate, and Weathered Slate
- REGIONAL AVAILABILITY: Northeast, Southeast, Southwest, and Central Areas

Proposed Roof Shingle (Or Equal)



EXHIBIT A—DRAWING SET

92 E. FOREST DETROIT, MI 48201

Refer to the following drawing set for additional information.

<u>General Drawing Set</u>

Cover Sheet	G.001
Existing Photos	G.002
Architectural Drawing Set	
First Floor Plan	A.100
Second Floor Plan	A.101
• Roof Plan	A.102
Exterior Elevations	A.200
Exterior Elevations	A.201
Exterior Renderings	A.300

92 E. Forest

Exterior Renovation 92 E. Forest Avenue Detroit, MI 48201

General Scope of Work

1. Exterior & interior renovation of an existing church converted into a multifamily apartment building (15 units total).

2. General site improvements

<u>Owner</u>

RainCheck Forest LLC (Neal Check) 28715 Greenfield Rd. Southfield, MI 48076 P.248.440.5996

Construction Manager

The Monahan Company (Kevin Monahan) 21321 Kelly Rd. Eastpointe, MI 48021

Architect

Krieger | Klatt Architects Inc. (Jeff Klatt, R.A.) 2120 E. 11 Mile Rd. Royal Oak, MI 48067 P.248.414.9270 F.248.414.9275

Civil Engineer

Mason Browns Associates, LLC (Mason L. Brown, II, P.E.) 2708 Bridle Road Bloomfield Hills, MI 48304 P.248.425.9789


HDC Sheet Index

Sheet No.	Title
G.001	Cover Sheet
G.002	Existing Photos
A.100	First Floor Plan
A.101	Second Floor Plan
A.102	Roof Plan
A.200	Exterior Elevations
A.201	Exterior Elevations
A.300	Exterior Renderings



View of Front facade from Forest Ave.



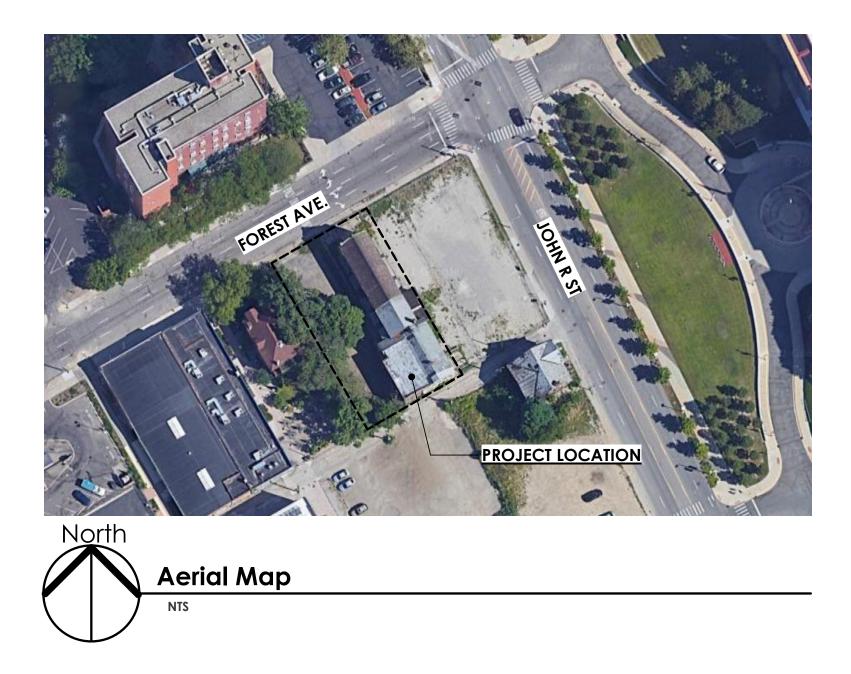

KRIEGER KLATT Architects

2120 E. 11 Mile Rd. | Royal Oak, MI 48067 P: 248.414.9270 F: 248.414.9275 www.kriegerklatt.com

Client:

RainCheck Forest, LLC. 28715 Greenfield Rd. Southfield, MI 48076

Project:

Exterior & Interior Renovation 92 E. Forest Avenue Detroit, MI 48201

Issued:

133060.	
02.14.2022	HDC Submittal
05.16.2022	HDC Submittal

Seal:



Note:

Do not scale drawings. Use calculated dimensions only. Verify existing conditions in field.

North Arrow:

Sheet Title:

Cover Sheet

Project Number:

21-072

Sheet Number:

G.001




View to West front section of building



View to East & South rear section of building towards alley



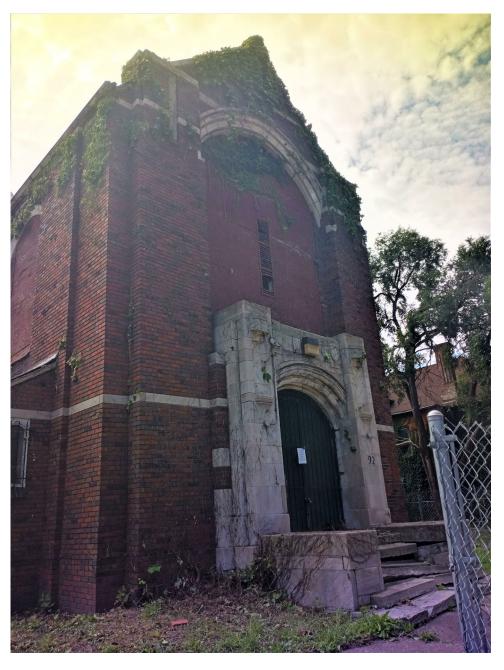

View to North front section of building



View to West middle section of building

View to East middle section of building



View to West rear section of building towards alley



View to East front section of building

KRIEGER KLATT Architects

2120 E. 11 Mile Rd. | Royal Oak, MI 48067 P: 248.414.9270 F: 248.414.9275 www.kriegerklatt.com

Client:

RainCheck Forest, LLC. 28715 Greenfield Rd. Southfield, MI 48076

Project:

Exterior & Interior Renovation 92 E. Forest Avenue Detroit, MI 48201

Issued:

02.14.2022 HDC Submittal	

Seal:



Note: Do not scale drawings. Use calculated dimensions only. Verify existing conditions in field.

North Arrow:

Sheet Title: Existing Photos

Project Number: 21-072





Proposed First Floor Plan

3/16" = 1'-0"

KRIEGER KLATT Architects

2120 E. 11 Mile Rd. | Royal Oak, MI 48067 P: 248.414.9270 F: 248.414.9275 www.kriegerklatt.com

Client:

RainCheck Forest, LLC. 28715 Greenfield Rd. Southfield, MI 48076

Project:

Exterior & Interior Renovation 92 E. Forest Avenue Detroit, MI 48201

Issued:

10.22.2021	Schematic Design
02.14.2022	HDC Submittal
02.14.2022	
	1


Seal:



Note:

Do not scale drawings. Use calculated dimensions only. Verify existing conditions in field.

North Arrow:

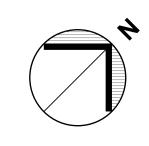


Sheet Title: First Floor Plan

Project Number:

21-072



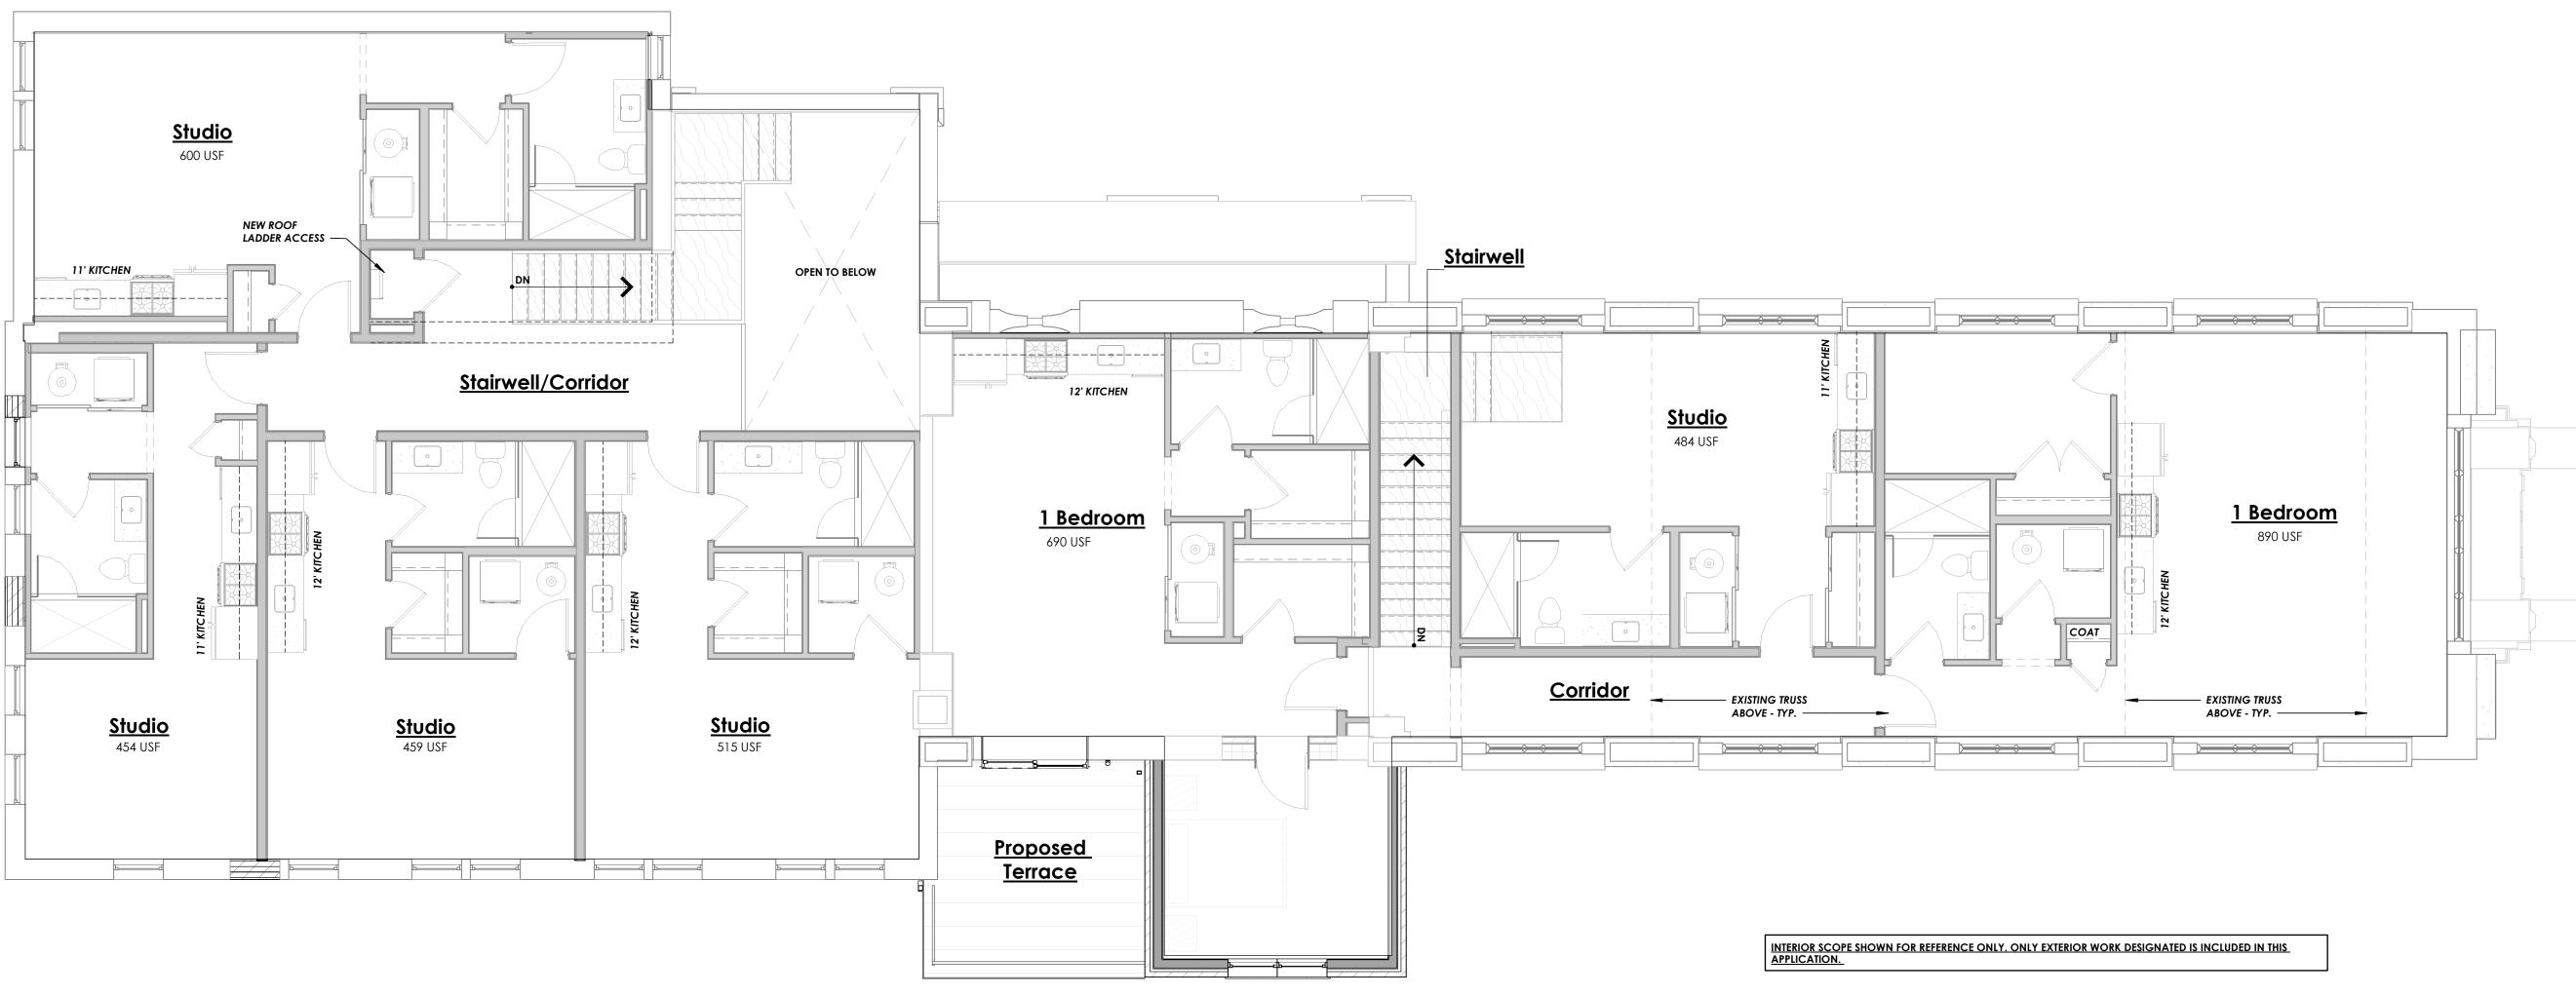

Proposed Second Floor Plan

3/16" = 1'-0"

KRIEGER KLATT Architects

2120 E. 11 Mile Rd. | Royal Oak, MI 48067 P: 248.414.9270 F: 248.414.9275 www.kriegerklatt.com

Client:

RainCheck Forest, LLC. 28715 Greenfield Rd. Southfield, MI 48076

Project:

Exterior & Interior Renovation 92 E. Forest Avenue Detroit, MI 48201

Issued:

02.14.2022	HDC Submittal


Seal:



Note:

Do not scale drawings. Use calculated dimensions only. Verify existing conditions in field.

North Arrow:

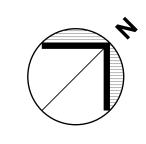


Sheet Title: Second Floor Plan

Project Number:

21-072



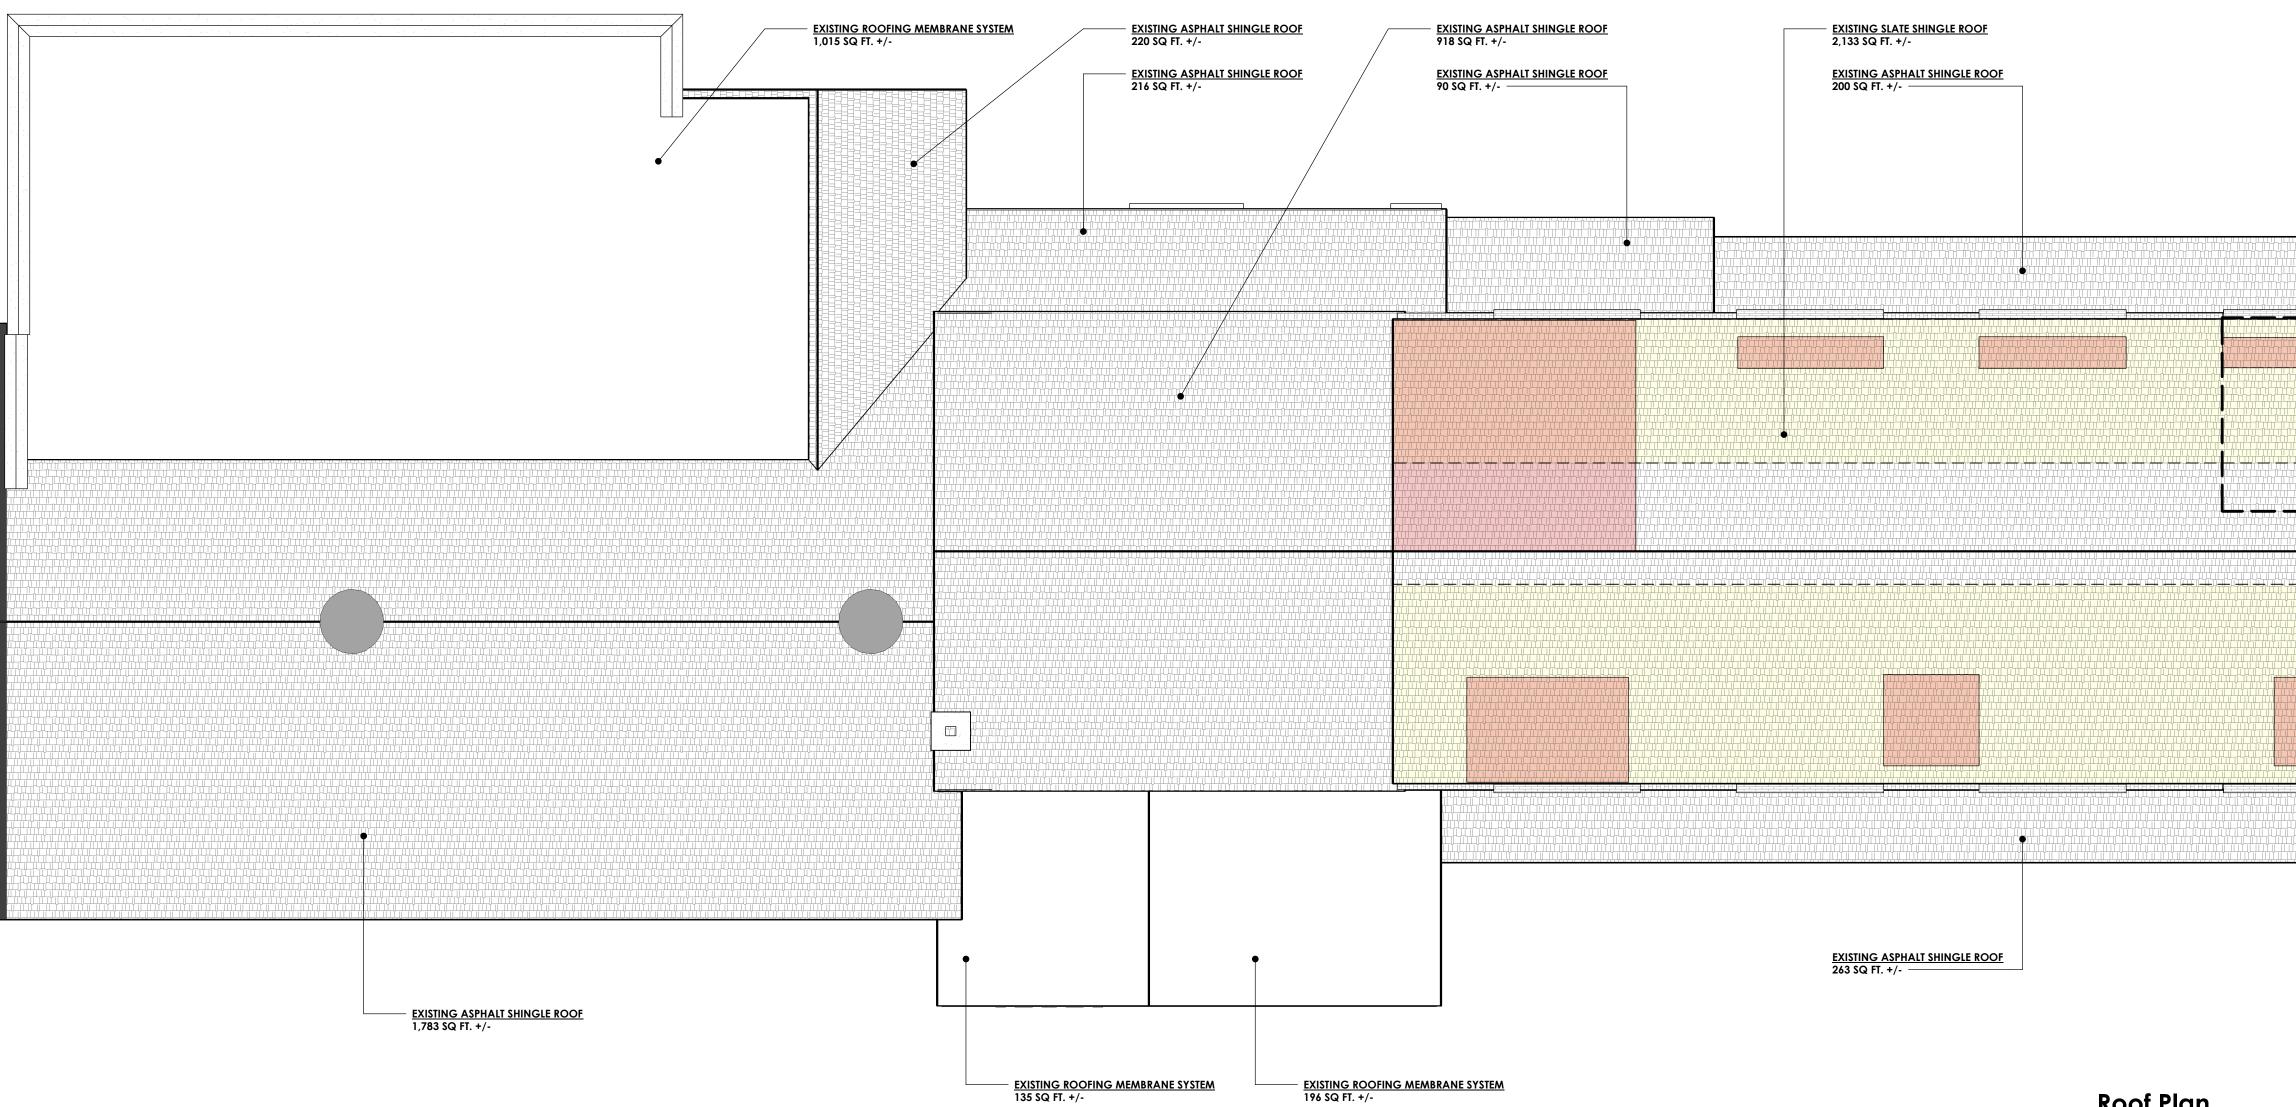

Roof Plan

KRIEGER KLATT Architects


2120 E. 11 Mile Rd. | Royal Oak, MI 48067 P: 248.414.9270 F: 248.414.9275 www.kriegerklatt.com

Client:

RainCheck Forest, LLC.

Project:

Exterior & Interior Renovation 92 E. Forest Avenue Detroit, MI 48201

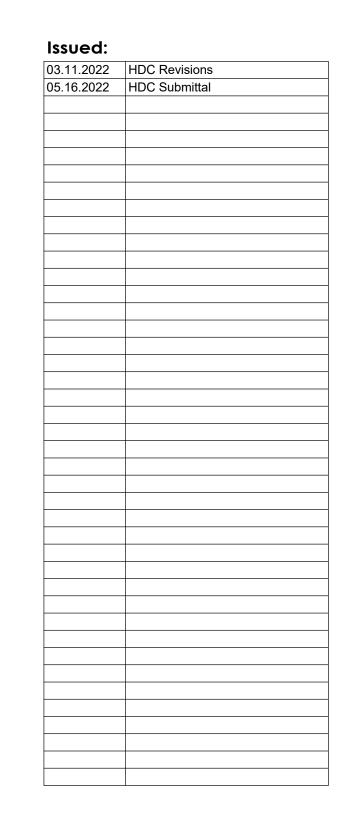


Seal:



Note:

Do not scale drawings. Use calculated dimensions only. Verify existing conditions in field.

North Arrow:

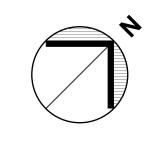


Sheet Title: Roof Plan

Project Number:

21-072

Sheet Number:



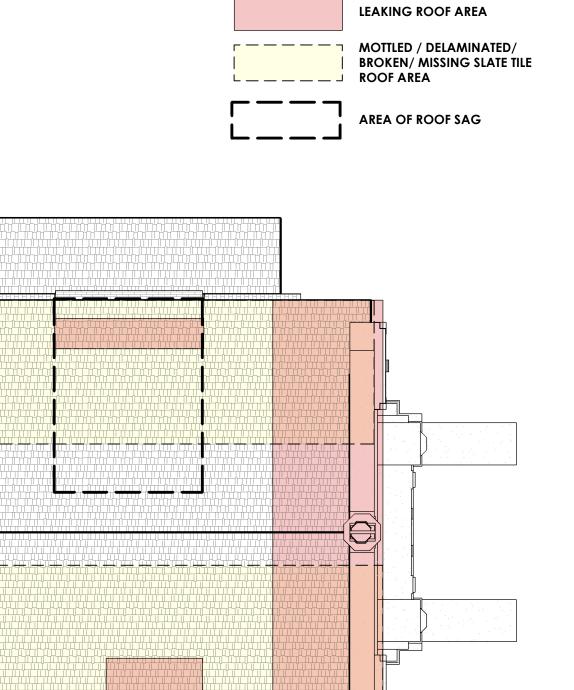

3/16" = 1'-0"



WINDOW TYPES:		
1.	SW.x	SANCTUARY WINDOW #x
2.	DW.x	DOUBLE HUNG WINDOW #x
3.	NW.x	NAVE WINDOW #x
4.	FW.x	FIXED WINDOW #x





2 Proposed Left (East) Elevation 3/16" = 1'-0" A.104

KRIEGER KLATT Architects

2120 E. 11 Mile Rd. | Royal Oak, MI 48067 P: 248.414.9270 F: 248.414.9275 www.kriegerklatt.com

Client:

RainCheck Forest, LLC. 28715 Greenfield Rd. Southfield, MI 48076

Project:

Exterior & Interior Renovation 92 E. Forest Avenue Detroit, MI 48201











FW.x FIXED WINDOW #x

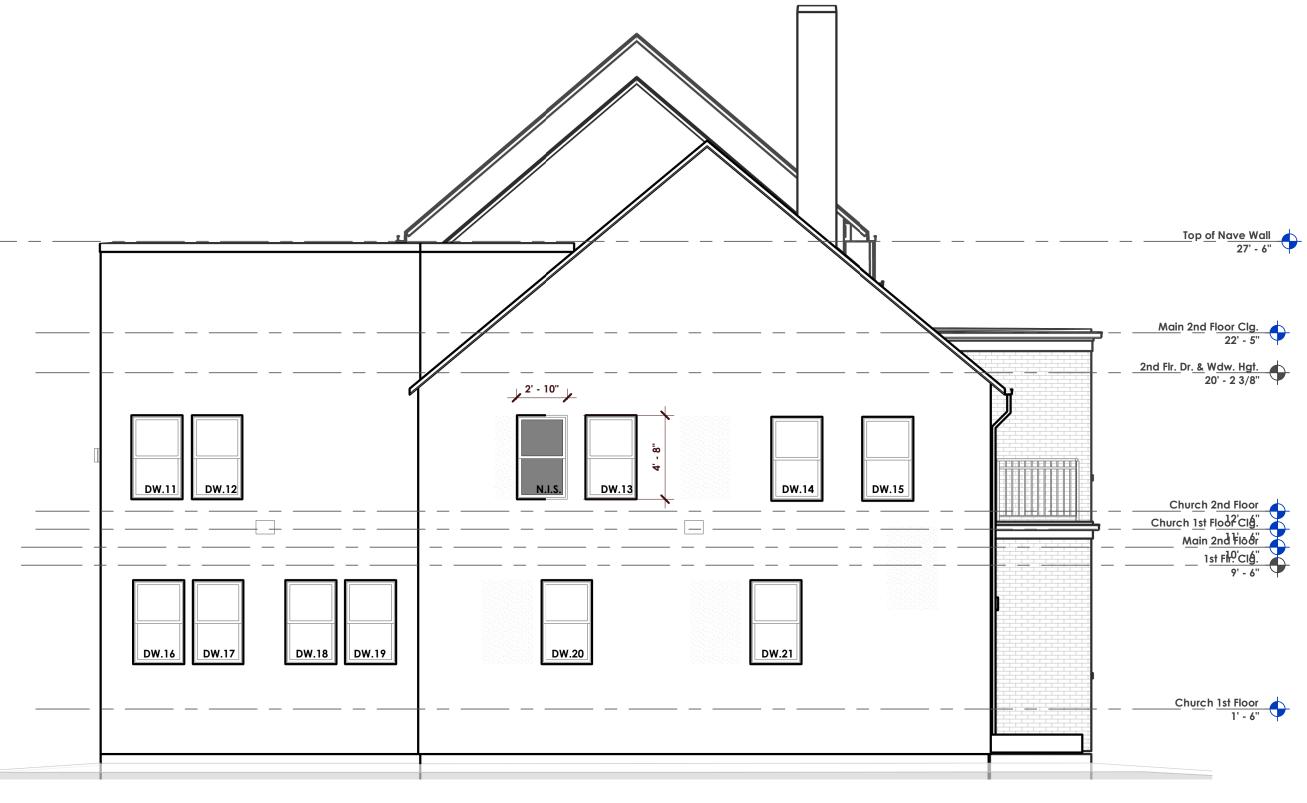



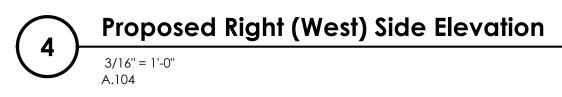

KRIEGER KLATT Architects

2120 E. 11 Mile Rd. | Royal Oak, MI 48067 P: 248.414.9270 F: 248.414.9275 www.kriegerklatt.com

Client:

RainCheck Forest, LLC. 28715 Greenfield Rd. Southfield, MI 48076


Project:

Exterior & Interior Renovation 92 E. Forest Avenue Detroit, MI 48201

Issued:

02.14.2022	HDC Submittal
03.11.2022	
05.16.2022	HDC Submittal
05.10.2022	

Seal:

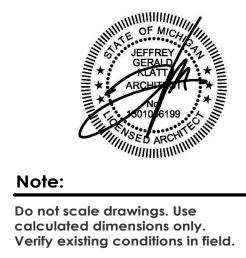

North Arrow:

Sheet Title:

Exterior Elevations

Project Number:

21-072

