

BASEMENT FLOOR PLAN

SCALE: 1/8" = 1'-0"

GENERAL NOTES

- A FIRESTOPPING: PROVIDE FIRESTOPPING ASSEMBLIES AT ALL PENETRATIONS AND INTERRUPTIONS TO FIRE RATED ASSEMBLIES WHICH PROVIDE THE SPECIFIED FIRE RATING FOR PARTITION OR FLOOR. SEE SPECIFICATIONS.
- B FIRE RATED PARTITIONS SHALL BE CONTINUOUS FROM FLOOR TO STRUCTURE ABOVE AND SHALL BE FIRE STOPPED TIGHTLY TO STRUCTURE PER CODE (U.L. SYSTEM). SEE PARTITION SCHEDULE/A501 FOR ADDITIONAL REQUIREMENTS.
- C PARTITIONS ARE DIMENSIONED FROM FINISH FACE TO FINISH FACE, UNLESS NOTED OTHERWISE.
- MAINTAIN DIMENSIONS MARKED 'CLEAR'. ALLOW FOR THICKNESS OF FINISHES.

 D COORDINATE AND PROVIDE BACKING FOR MILLWORK AND ITEMS ATTACHED OR MOUNTED TO WALLS OR CEILINGS.
- E CONTRACTOR TO PROVIDE BLOCKING AS REQUIRED. COORDINATE LOCATIONS AND EXTENTS OF BLOCKING WITH PRODUCT MANUFACTURERS AND SHOP DRAWINGS.
 F LOCATE DOOR FRAMES 6" FROM INSIDE CORNER TO DOOR OPENING, UNLESS NOTED
- OTHERWISE.

 G ALL INTERIOR GLAZING INCL DOORS, SIDELITES, & BORROWED LITES SHALL BE CLEAR LAMINATED
- SAFETY GLASS OR CLEAR TEMPERED SAFETY GLAZING. UNLESS NOTED OTHERWISE.

 H RECESSED ITEMS (GREATER THAN 16 SQ. IN.) IN RATED AND/OR SMOKE WALLS, INCLUDING ELEC PANELS, ELEC DUCTS, MED GAS VALVE BOXES, FIRE EXT CABINETS, ETC. SHALL BE BACKED WITH 5/8" TYPE 'X' GYPSUM BOARD TO MAINTAIN RATING FIRE WALL.
- I SEMI-RECESSED FIRE EXTINGUISHER (FE) ARE SHOWN ON PLAN SEE PARTITION SCHEDULE/A501 FOR TYPICAL DETAILS. FINAL LOCATION OF FIRE EXTINGUISHERS SHALL BE REVIEWED IN FIELD WITH BUILDING OFFICIAL PRIOR TO INSTALLATION ROUGH-IN.
- J COORDINATE TELECOMMUNICATIONS, A/V, DATA AND SECURITY SYSTEMS INSTALLATIONS.
 PROVIDE AND INSTALL TELEPHONE AND ELECTRICAL PANEL BOARDS, PANEL BOARDS SHALL BE 4'
- X 8' X 3/4" THICK, PLYWOOD, FIRE RETARDANT TREATED.

 K COORDINATE WITH ROOM FINISH AND MATERIAL SCHEDULE.
- L COORDINATE WITH ENLARGED ROOM PLAN FOR ADDITIONAL REQUIREMENTS.
- M SEE PARTITION SCHEDULE/A501 FOR ADDITIONAL REQUIREMENTS.

WORK IN EXISTING STRUCTURES

- O WHERE NEW GYPSUM BOARD PARTITIONS ARE A CONTINUATION OF AN EXISTING PARTITION OR COLUMN ENCASEMENT, THE FACE OF THE NEW GYPSUM BOARD SHALL BE ALIGNED WITH THE FACE OF THE EXISTING SURFACE. WHERE A NEW GYPSUM BOARD PARTITION IS SHOWN INTERSECTING A COLUMN ENCASEMENT THE CENTERLINE OF THE WALL SHALL BE CENTERED ON THE COLUMN ENCASEMENT.
- P WHERE NEW OR INFILL PARTITION ABUTS EXISTING PARTITION, FACE OF PARTITIONS SHALL ALIGN, UNLESS NOTED OTHERWISE.

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- Q PARTITIONS WITH EXISTING FRAMING MAY REQUIRE REWORK TO ACCOMMODATE NEW OPENINGS, ETC.
- R ALTERNATE PARTITION ASSEMBLIES THAT VARY FROM THE ASSEMBLIES PROVIDED IN THE PARTITION SCHEDULE TO BE SUBMITTED BY THE CONTRACTOR TO THE ARCHITECT FOR CONSIDERATION. ALTERNATE ASSEMBLIES MAY REQUIRE REVIEW BY THE LOCAL JURISDICTION. ANY REVIEW SHALL NOT CONSTITUE A CLAIM FOR DELAY.
- S WHERE NEW FINISHES ARE SPECIFIED ON THE FINISH PLAN REMOVE ALL EXISTING FINISHES.
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- U PROVIDE TEMPORARY DUSTPROOF PARTITIONS AS REQUIRED TO PROTECT ALL EXISTING AREAS FROM DAMAGE.
- V WHERE SLAB ON GRADE REMOVAL IS REQUIRED FOR UTILITY PLACEMENT REFER TO TYPICAL CONCRETE SLAB INFILL DETAIL ON SHEET A___.

CONSTRUCTION KEYNOTES

- 002 OUTLINE OF FLOOR ABOVE
- 003 BARREL VAULT CEILING ABOVE
- 006 DTE TRANSFORMER
- 008 CANOPY ABOVE013 GUARDRAIL BY TENANT
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- 021 NEW ROOF MEMBRANE SEE SPECIFICATIONS AND STRUCTURAL023 GUTTER AND DOWNSPOUT
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- 029 APROXIMATE CRAWL SPACE EXTENTS VIF034 FACE OF NEW WALL TO ALIGN W/EDGE OF EXIST PILASTER.

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Revision

Date


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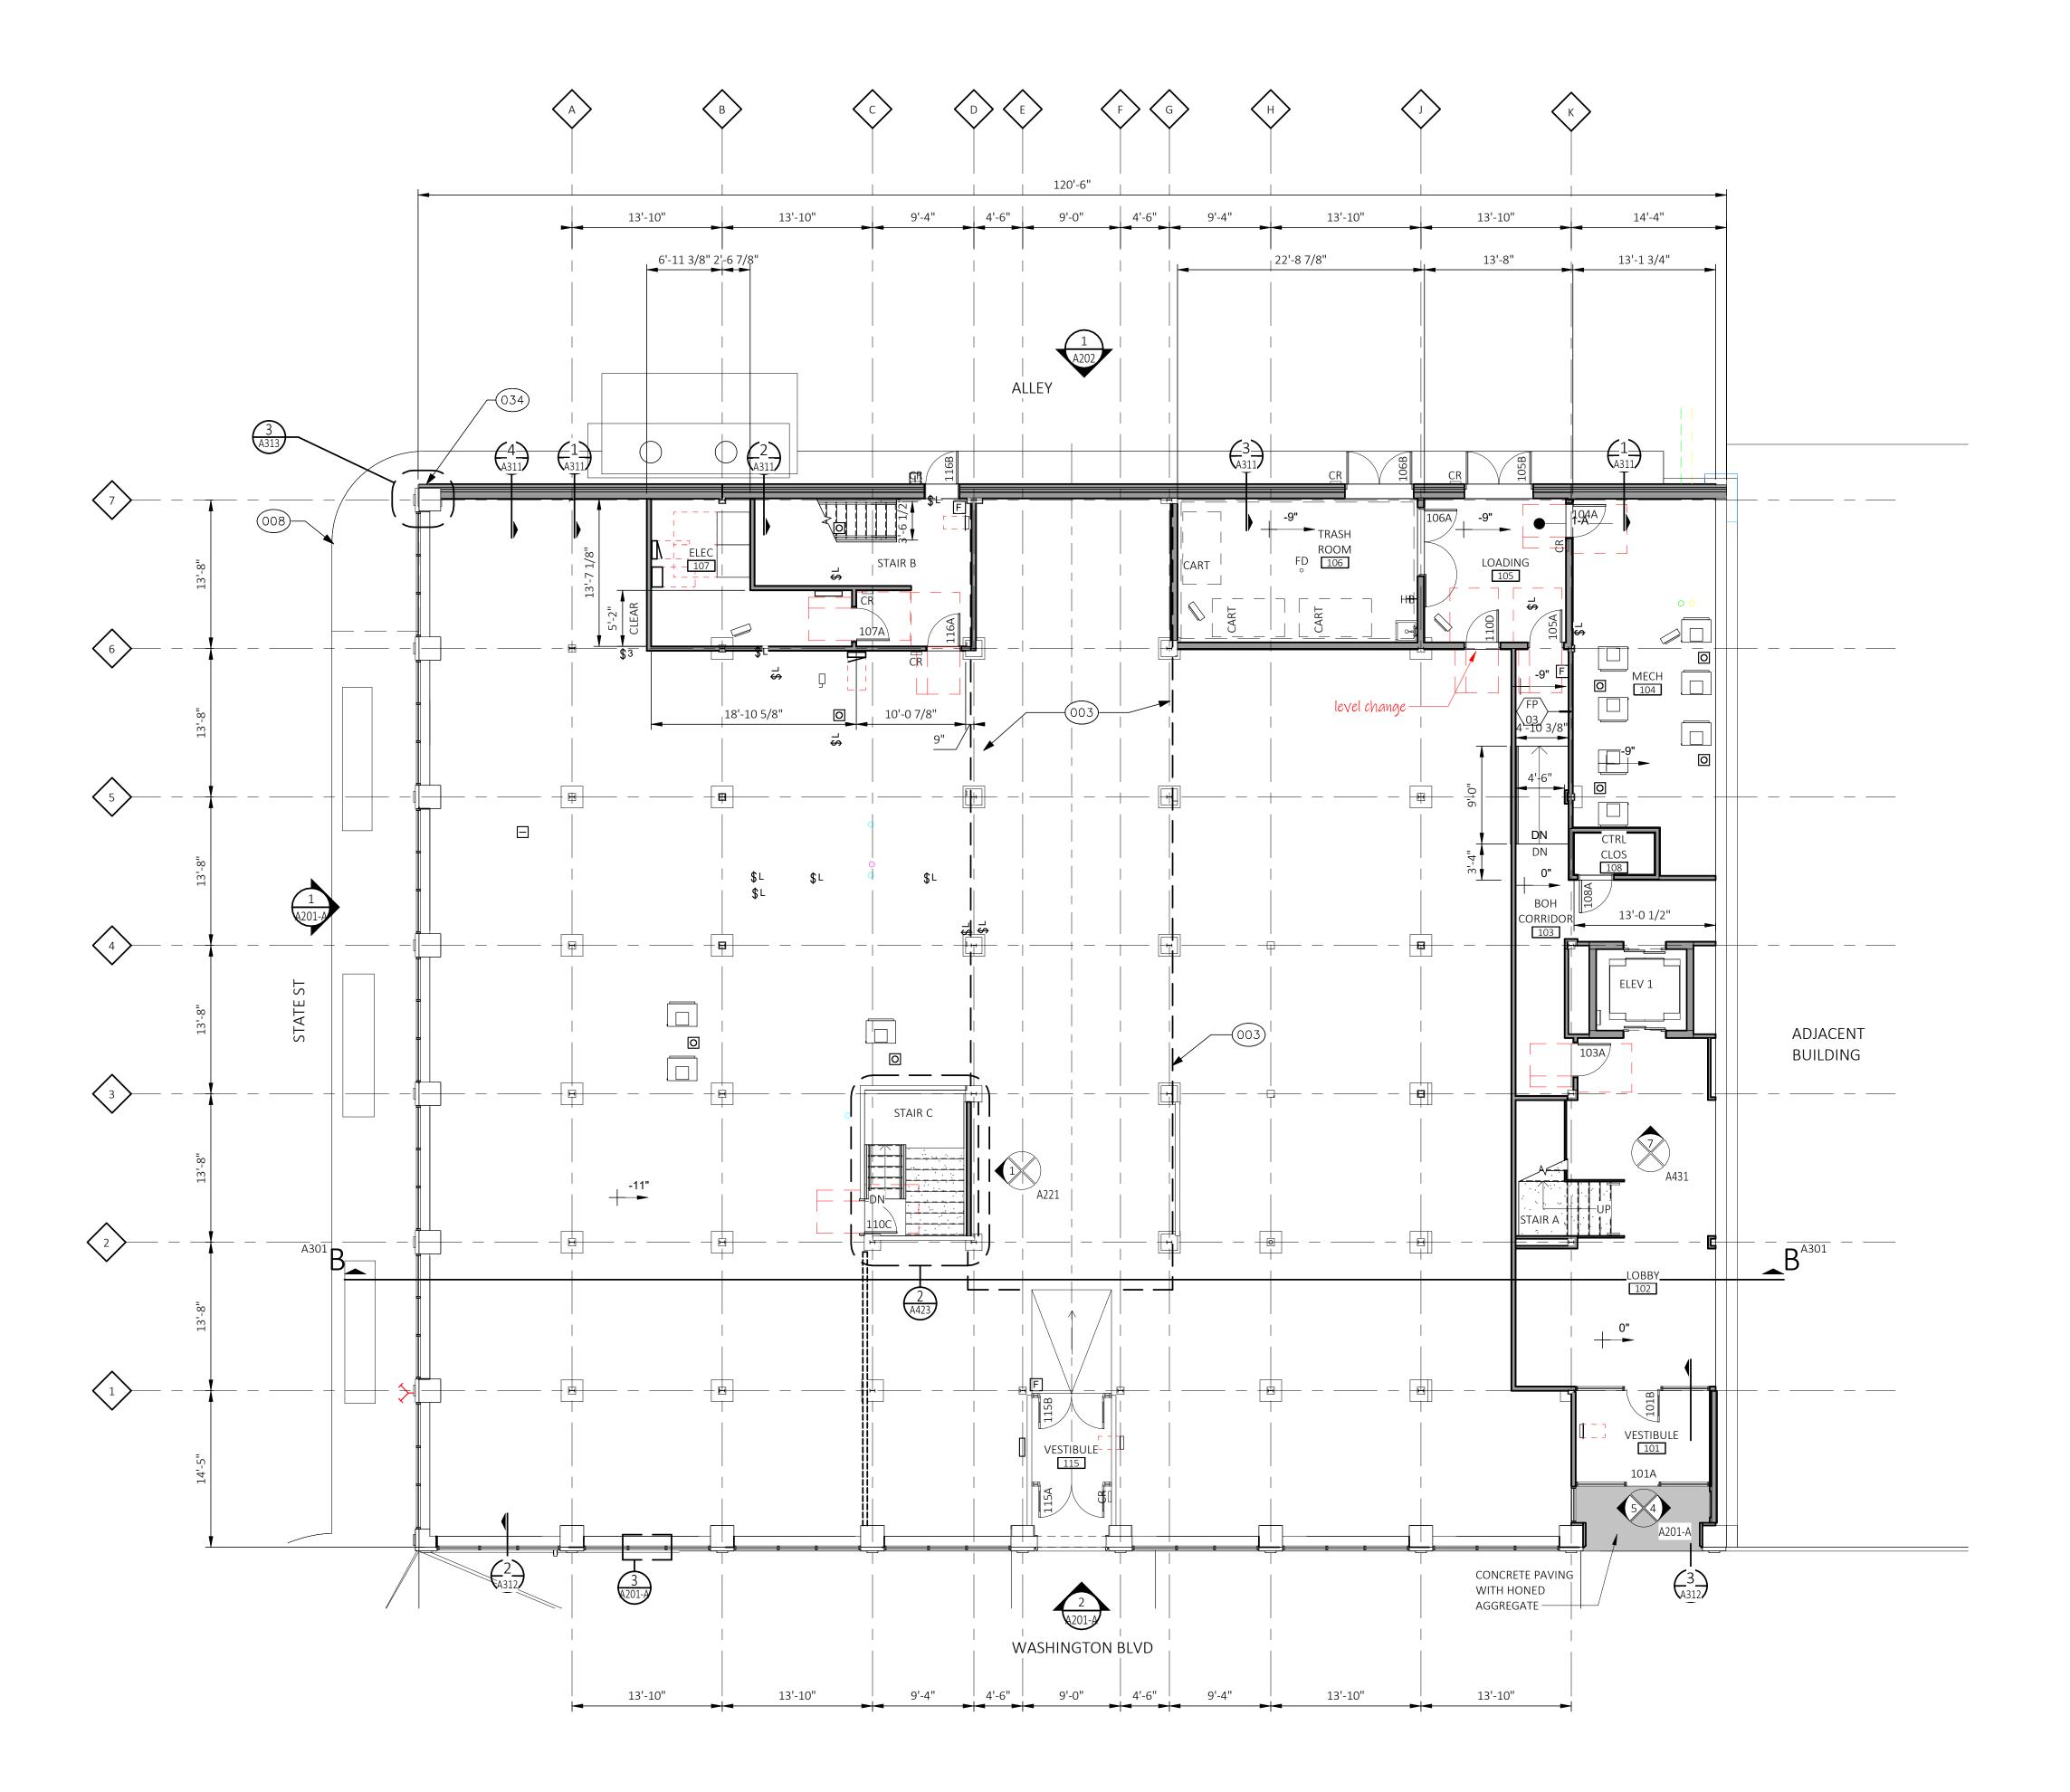
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BASEMENT FLOOR

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FIRST FLOOR PLAN SCALE: 1/8" = 1'-0"

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5/8" TYPE 'X' GYPSUM BOARD TO MAINTAIN RATING FIRE WALL.

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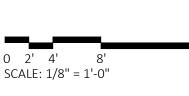
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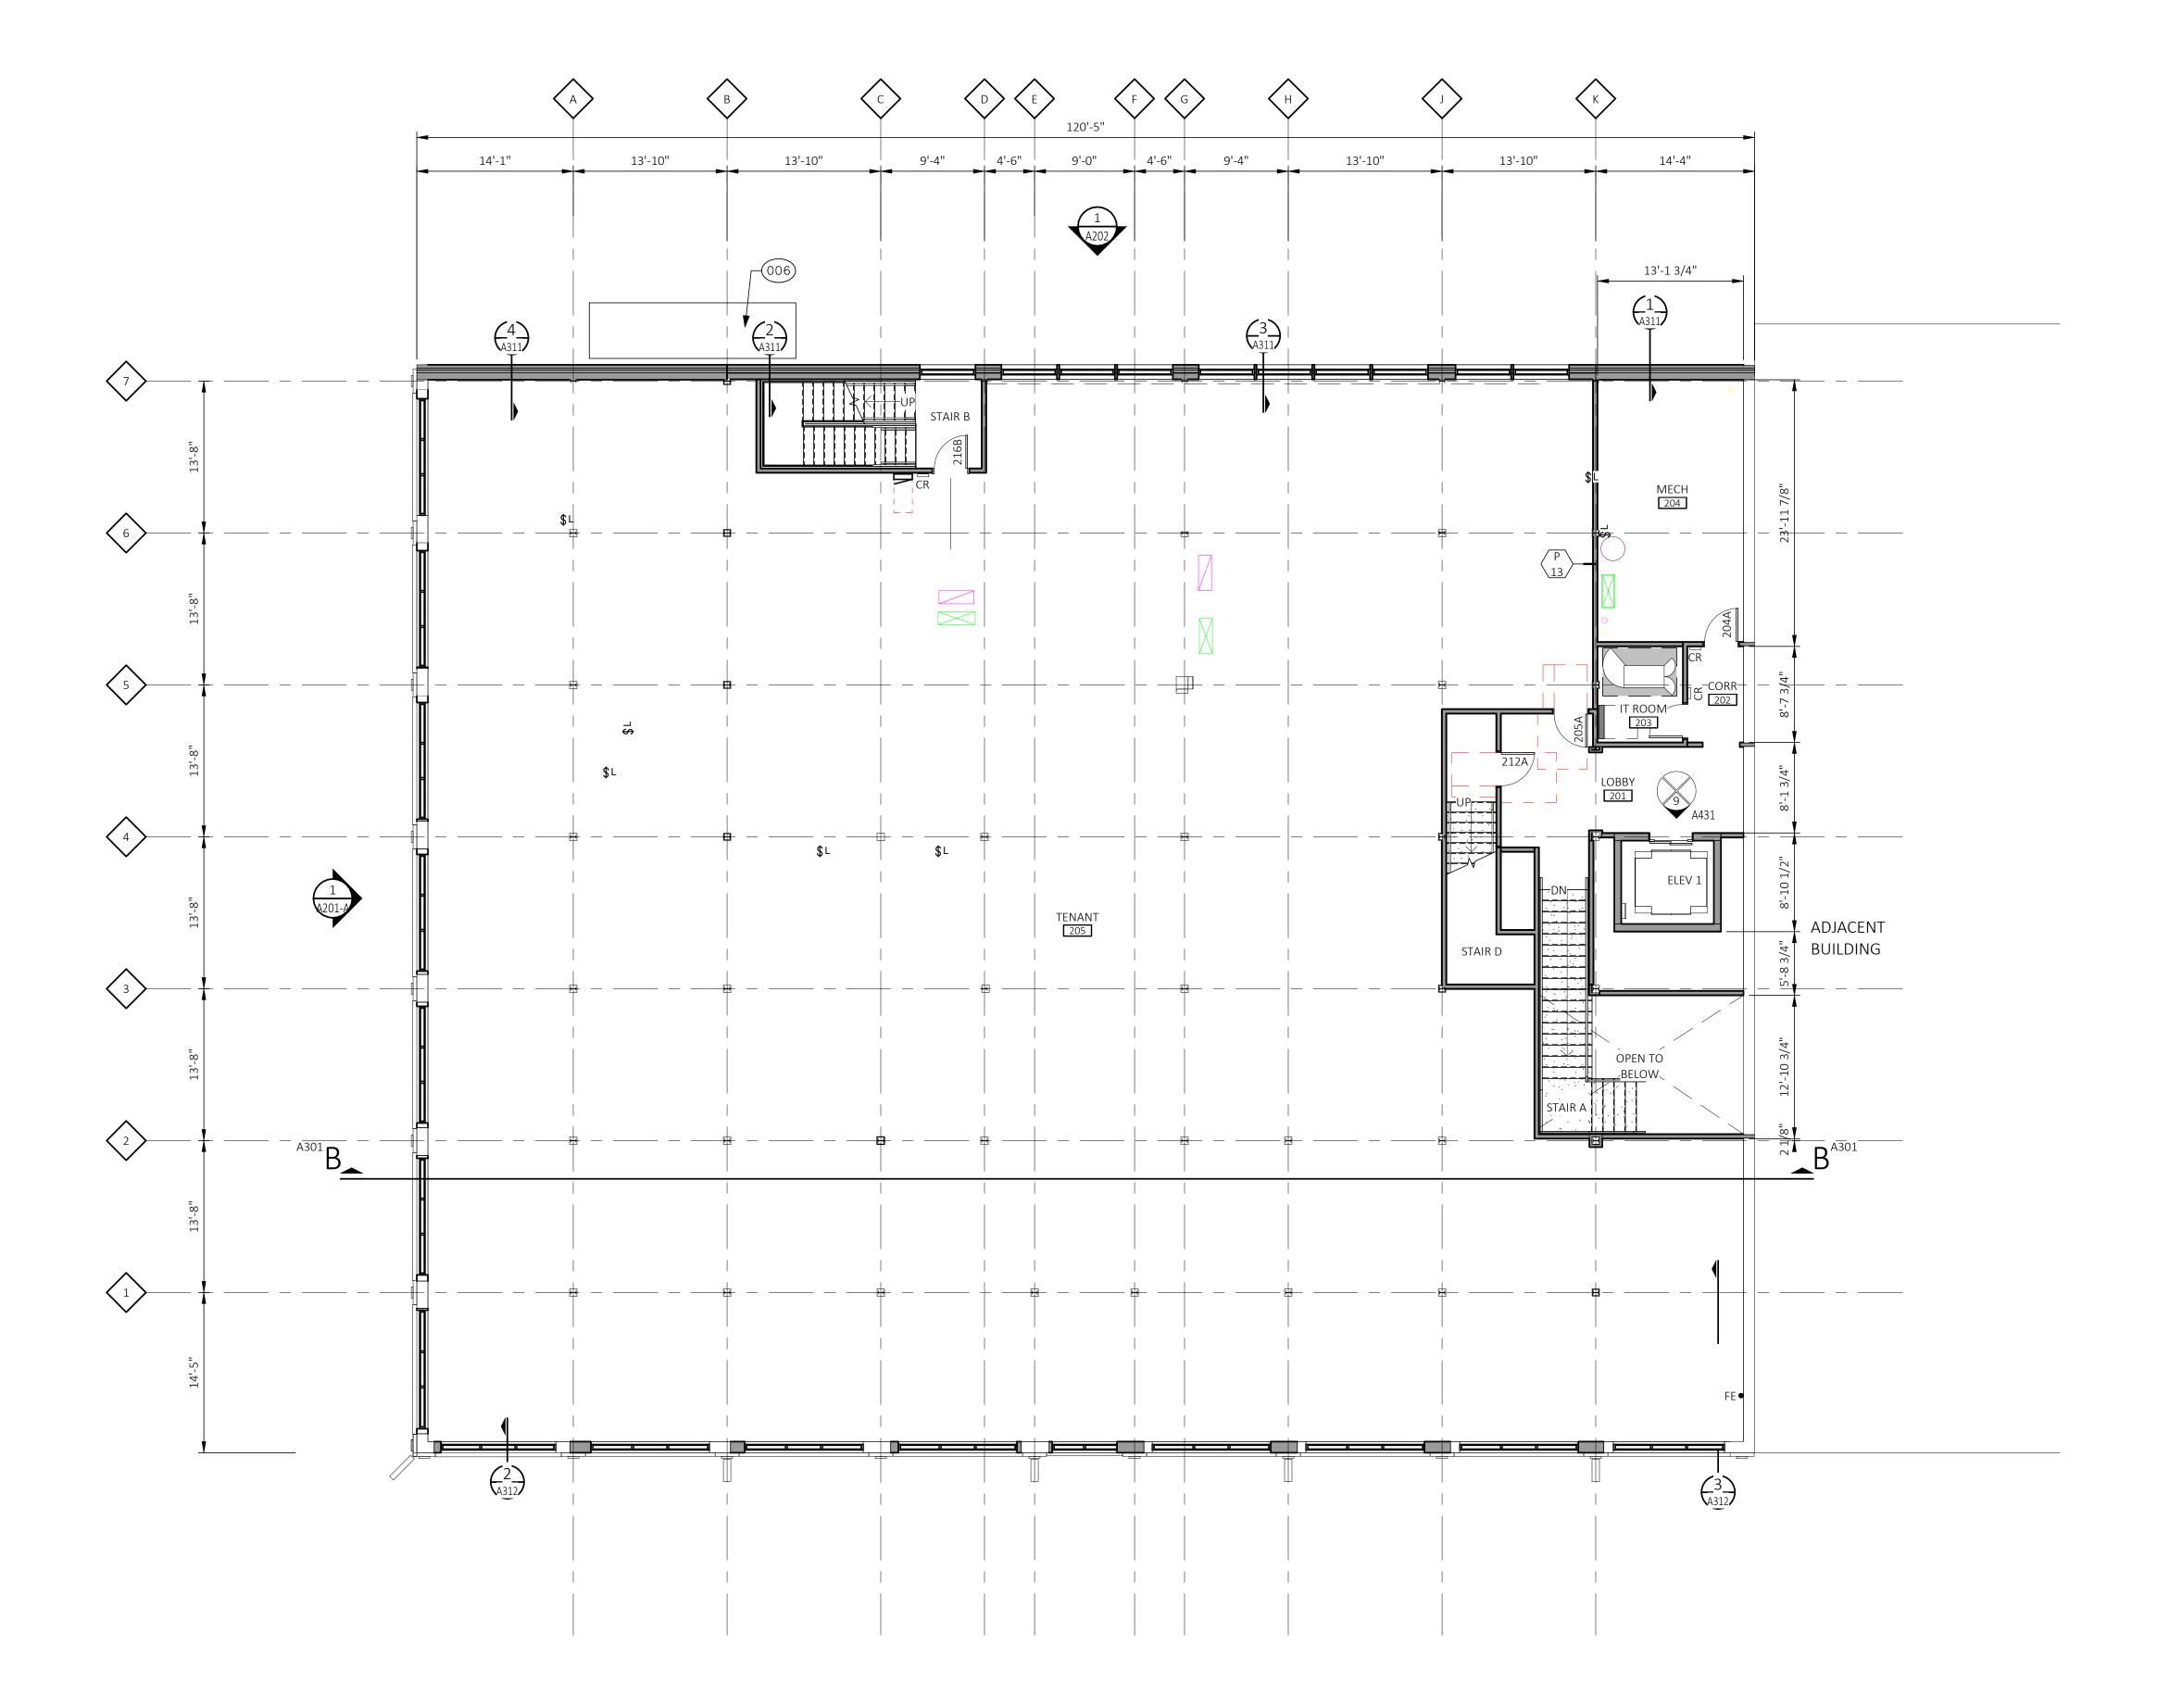
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FIRST FLOOR PLAN

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SECOND FLOOR PLAN SCALE: 1/8" = 1'-0"
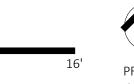
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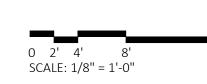
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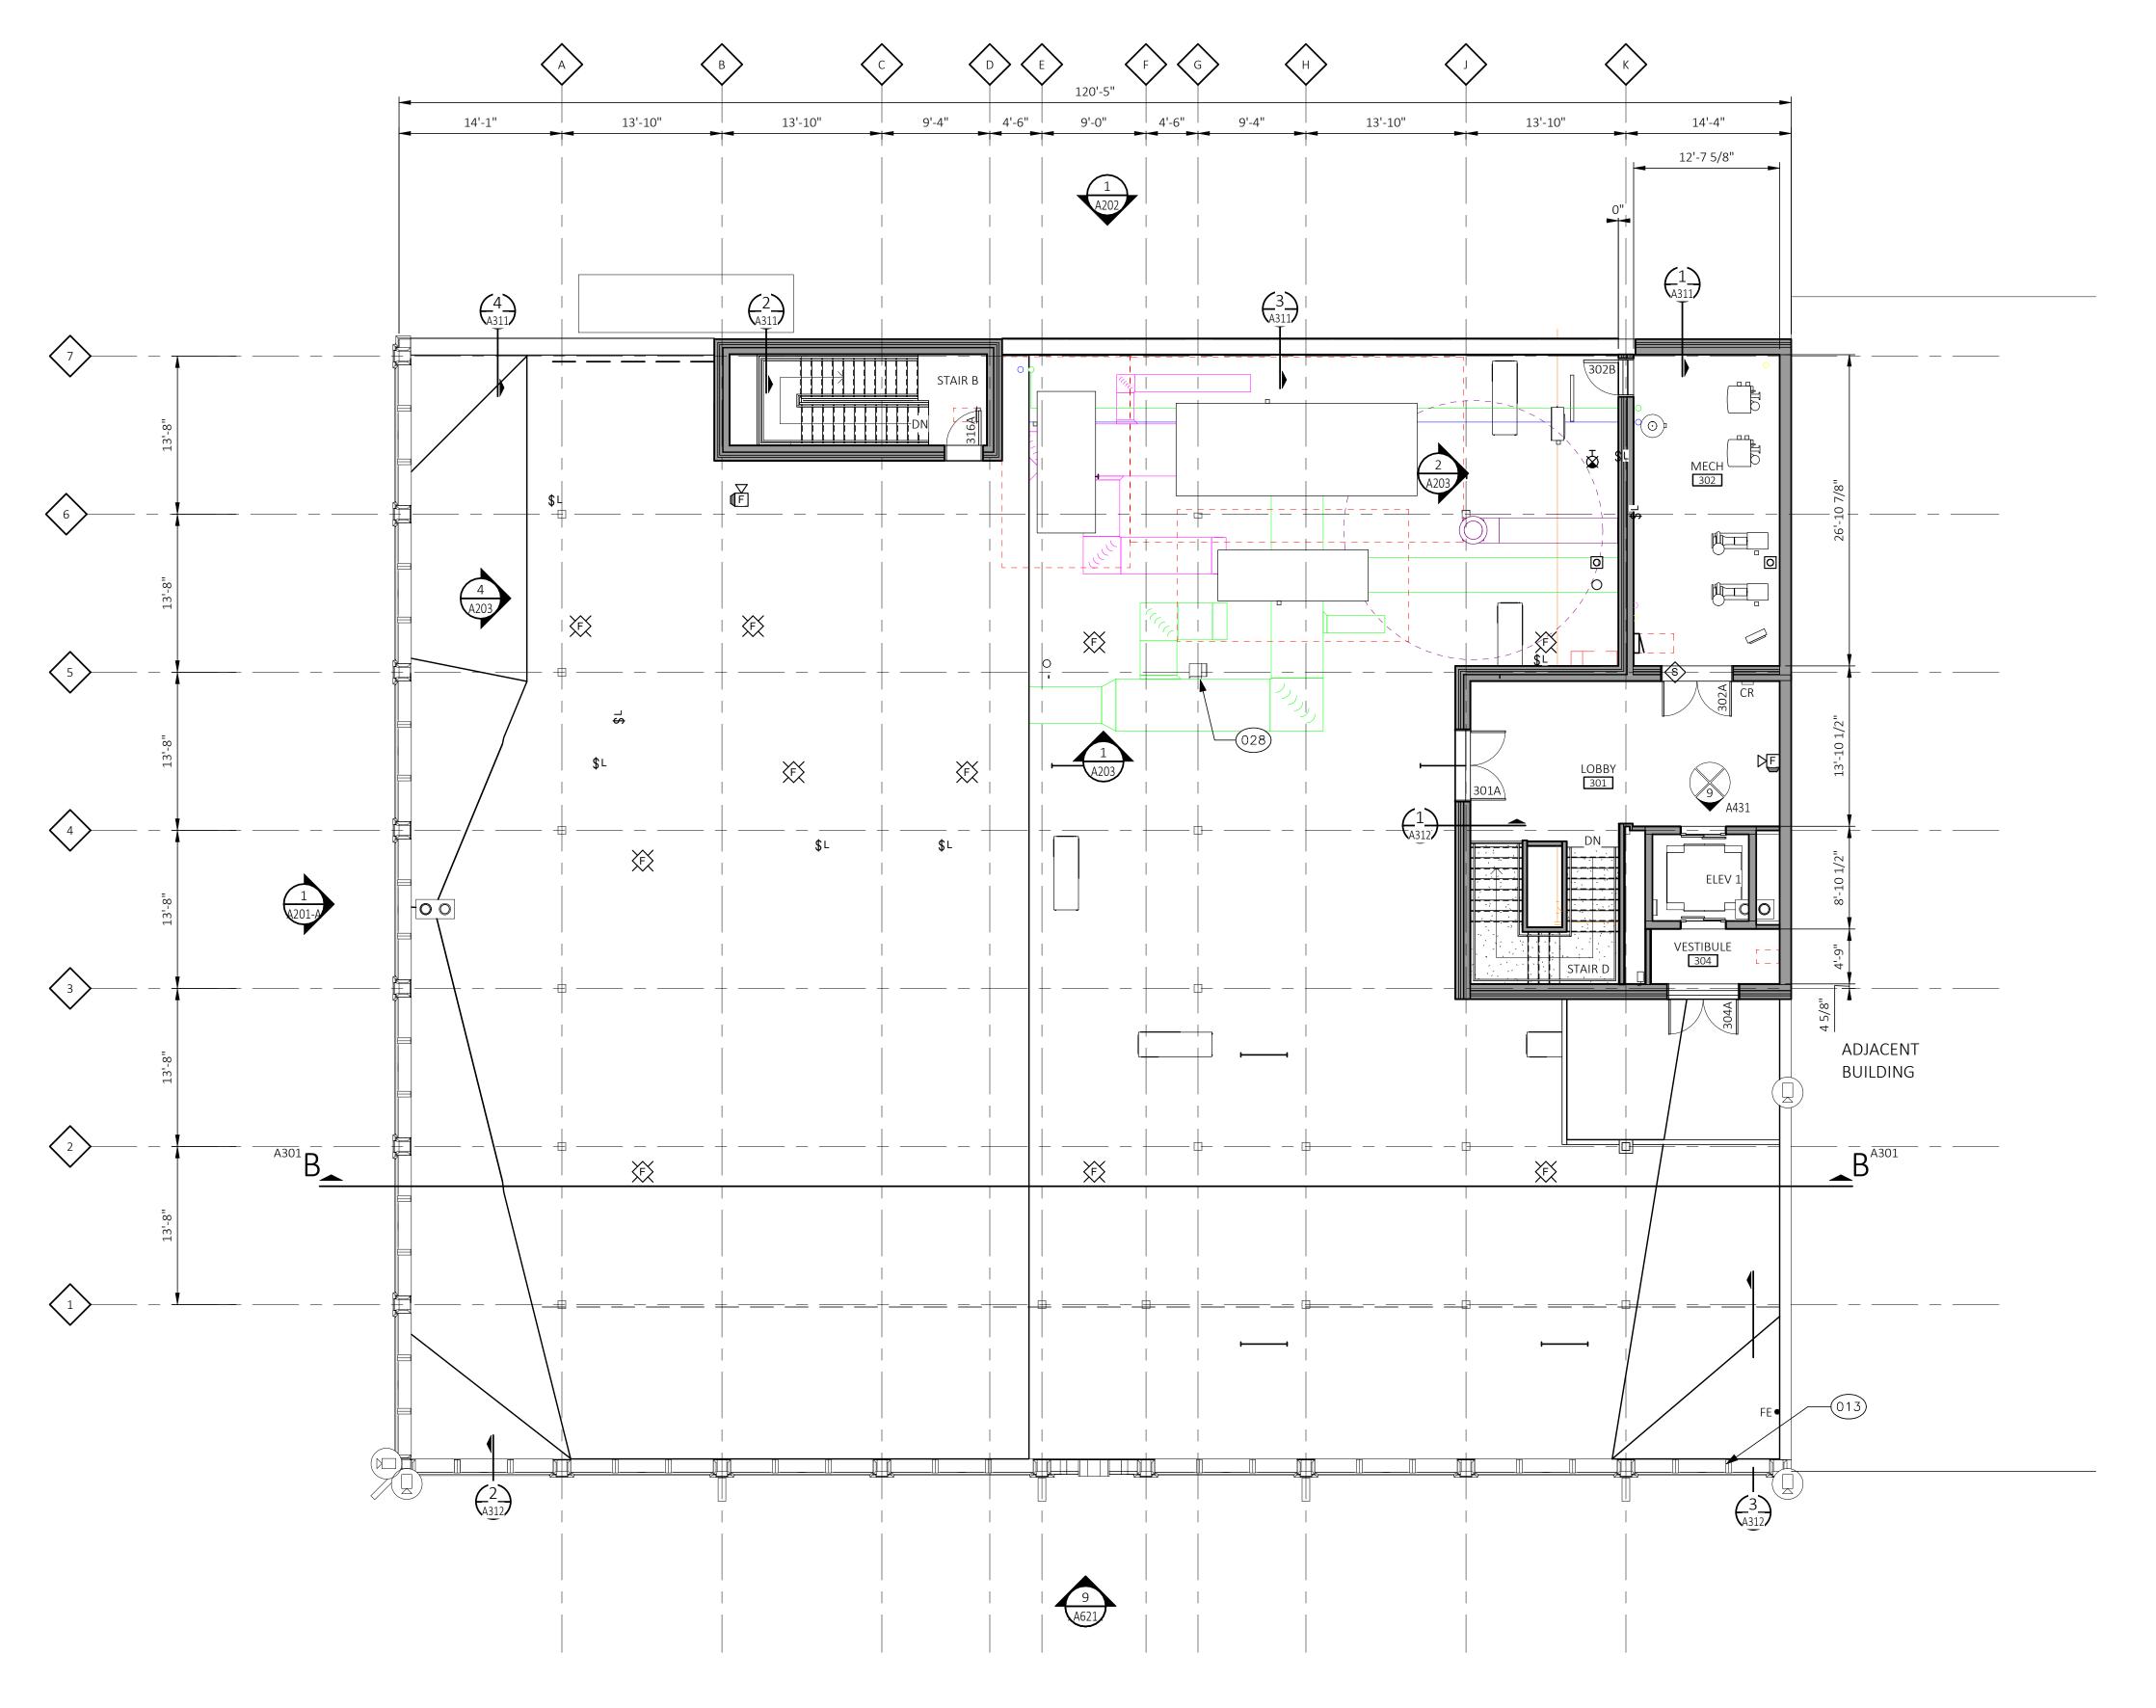
PLAN

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PENTHOUSE FLOOR PLAN

SCALE: 1/8" = 1'-0"

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raemerDesignGroup

Detroit, MI | Toledo, OH | Charleston, SC

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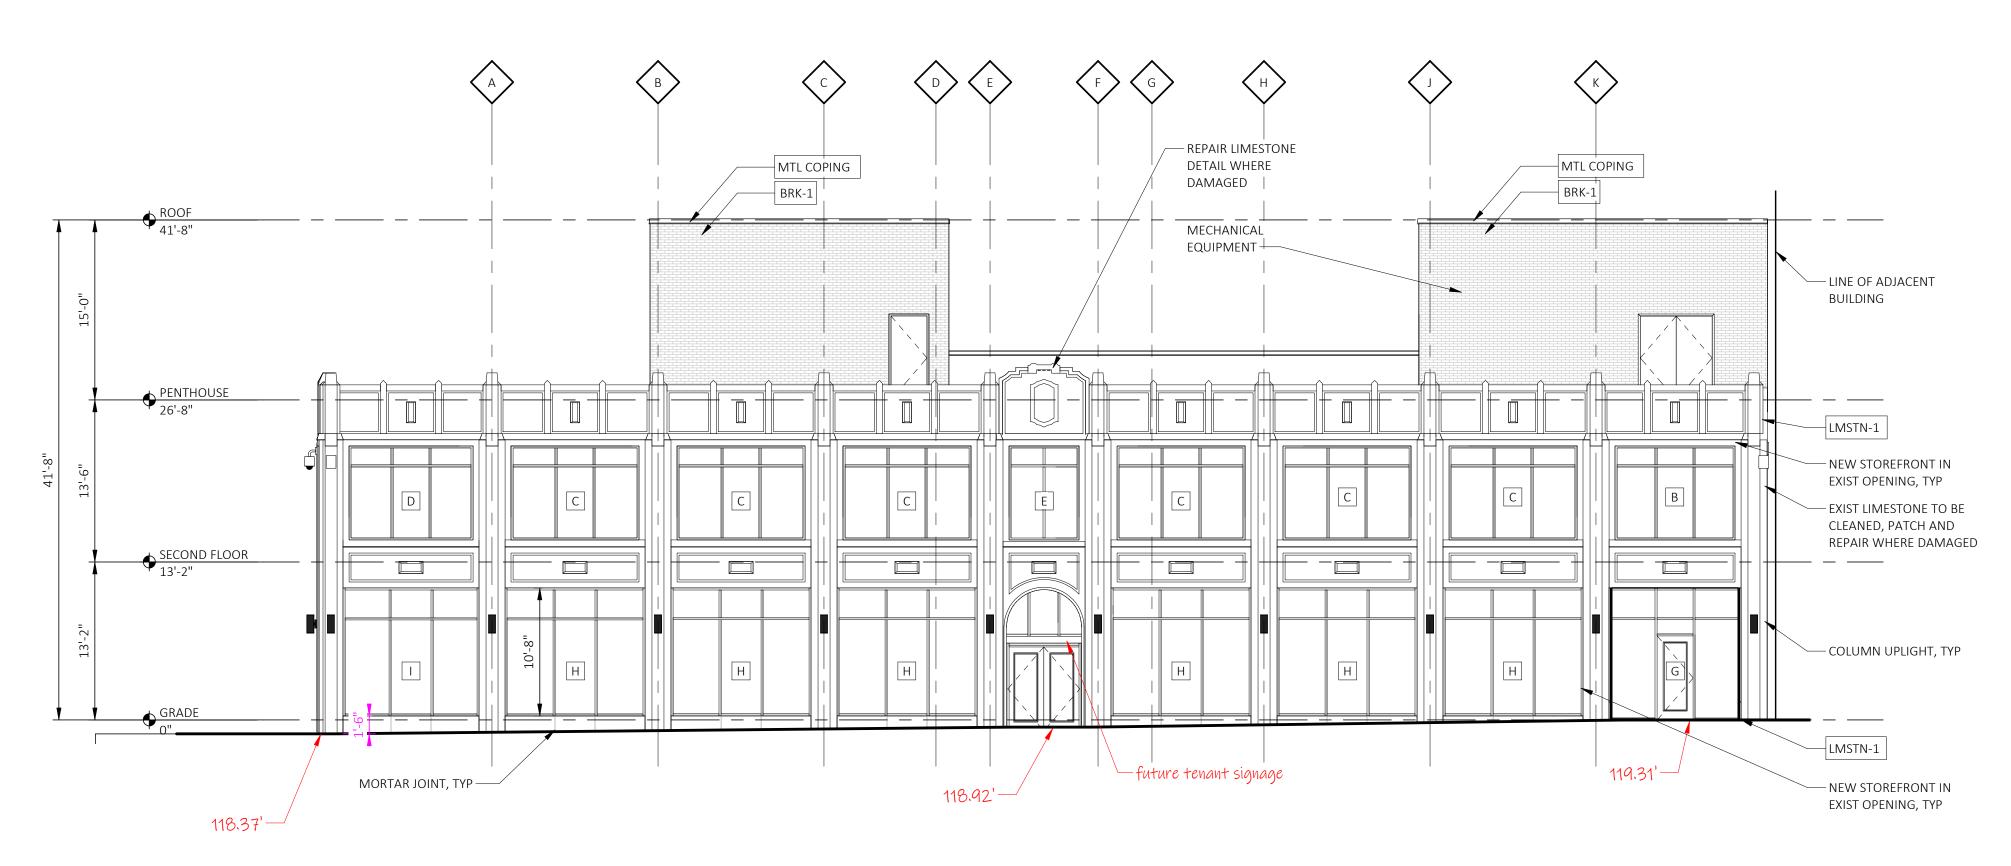
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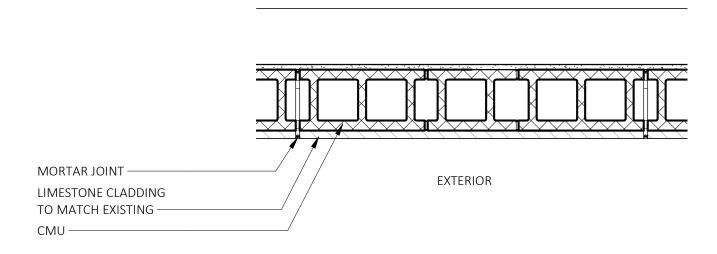
PENTHOUSE FLOOR PLAN


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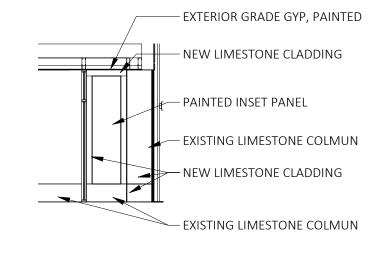










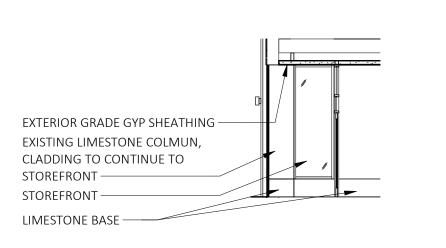







RESTORATION GENERAL NOTES

- A. MASONRY/STONE RESTORATION CONTRACTOR ("SUBCONTRACTOR") TO PROVIDE ALL LABOR, MATERIAL, EQUIPMENT, SUPERVISION, PERMITS AND ANY OTHER COSTS OR EXPENSES NECESSARY TO COMPLETE THE WORK. SUBCONTRACTOR JOB MOBILIZATION SHALL INCLUDE, BUT NOT BE LIMITED TO, ANY NECESSARY WORK STATION AND JOB TRAILER, MAST CLIMBING PLATFORMS, AERIAL LIFTS, SWING STAGES, BARRICADES AND WALK THRU SCAFFOLD AS NEEDED.
- B. BUILDING RESTORATION TO INCLUDE ALL TERMS, CONDITIONS AND SPECIFICATIONS OF ORIGINAL CONTRACT AND ANY ADDITIONAL WORK NECESSARY TO MEET THE SECRETARY OF THE INTERIOR STANDARDS FOR THE REHABILITATION OF HISTORIC PROPERTIES. THIS INCLUDES ALL WORK NECESSARY OVER AND ABOVE THAT SPECIFIED IN THE ARCHIOTECTURAL DRAWINGS AND OTHER CONSTRUCTION DOCUMENTS, INCLUDING ALL NOTES REGARDLESS OF TIME AND MATERIAL NECESSARY TO EXECUTE THIS WORK. ANY AREAS INDICATED WITHIN DRAWINGS ARE ONLY SUGGESTIVE IN NATURE. MASON TO MEET WITH ARCHITECT AND OWNER TO CONFIRM THE SCOPE OF WORK.
- C. RESTORATION CONTRACTOR SHALL INSPECT ALL EXISTING MASONRY, INCLUDING BOTH SIDES OF PARAPET FULL HEIGHT, FOR STRUCTURAL STABILITY PRIOR TO BID. REINSPECT AFTER INITIAL CLEANING OF MASONRY.
- D. ALL ELEVATIONS SHALL UNDERGO COMPLETE STONE CLEANING FROM PARAPET TO GRADE. SEE MASONRY CLEANING SPECIFICATION SECTIONS FOR DETAILS ON APPROVED CLEANING PROCEDURES, PRODUCTS, AND MANUFACTURERS.
- E. CLEAN FACADE USING GENTLEST MEANS POSSIBLE TO ACHIEVE SATISFACTORY RESULTS WITHOUT CHANGING THE SURFACE OF THE MASONRY. PAY SPECIAL ATTENTION TO AREAS OF EXCESSIVE SOILING. CONTRACTOR SHALL CONDUCT TEST PATCHES TO ENSURE THE BEST AND MOST ECONOMICAL MEANS OF CLEANING.
- F. SURFACES TO BE PRE-WET WITH CLEAN WATER. CLEANING SOLUTIONS TO NOT REMAIN ON SURFACES FOR MORE THAN 5 MINUTES FOLLOWED IMMEDIATELY BY LOW-PRESSURE FLOOD RINSE, UNLESS NOTED OTHERWISE IN MASONRY CLEANING SPECIFICATION. CLEANING IS TO BRING STONE UNIT AS CLOSE AS POSSIBLE TO ORIGINAL COLOR WITHOUT BURNING OR ABRASION.
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EXTERIOR ELEVATION MATERIAL LEGEND

LMSTN-1 LIMESTONE - EXISTING

BRK-1 TAN BRICK - NEW

GRN-1 GRANITE BASE - NEW

aemerDesignGroup
letroit, MI | Toledo, OH | Charleston, SC
ay | Detroit MI 48226 | p313 965 3399 | f313 965 38

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HDC SUBMISSION 05-02-22

Revision

Date


Project Number

Sheet Title **FXTERIOR**


EXTERIOR ELEVATIONS

Sheet Number

A201-A

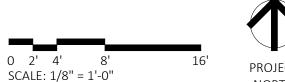



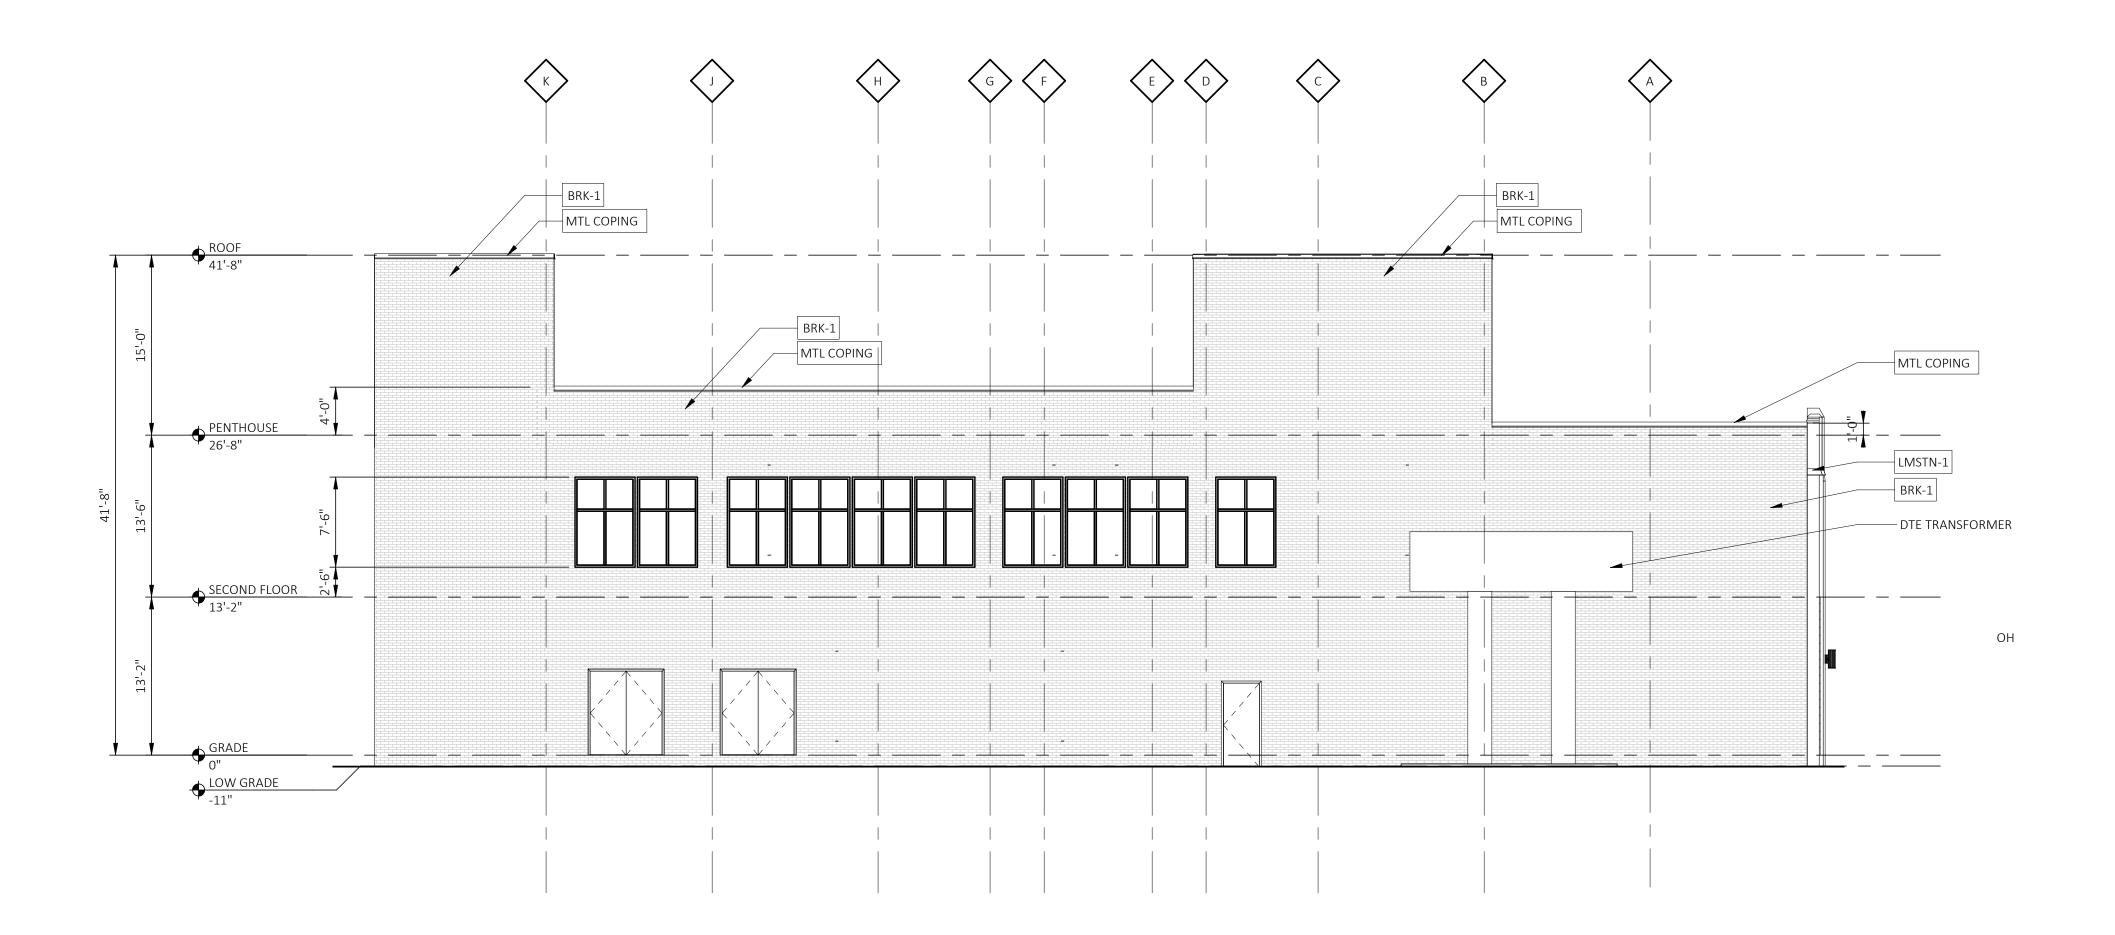



RESTORATION GENERAL NOTES

- A. MASONRY/STONE RESTORATION CONTRACTOR ("SUBCONTRACTOR") TO PROVIDE ALL LABOR, MATERIAL, EQUIPMENT, SUPERVISION, PERMITS AND ANY OTHER COSTS OR EXPENSES NECESSARY TO COMPLETE THE WORK. SUBCONTRACTOR JOB MOBILIZATION SHALL INCLUDE, BUT NOT BE LIMITED TO, ANY NECESSARY WORK STATION AND JOB TRAILER, MAST CLIMBING PLATFORMS, AERIAL LIFTS, SWING STAGES, BARRICADES AND WALK THRU SCAFFOLD AS NEEDED.
- B. BUILDING RESTORATION TO INCLUDE ALL TERMS, CONDITIONS AND SPECIFICATIONS OF ORIGINAL CONTRACT AND ANY ADDITIONAL WORK NECESSARY TO MEET THE SECRETARY OF THE INTERIOR STANDARDS FOR THE REHABILITATION OF HISTORIC PROPERTIES. THIS INCLUDES ALL WORK NECESSARY OVER AND ABOVE THAT SPECIFIED IN THE ARCHIOTECTURAL DRAWINGS AND OTHER CONSTRUCTION DOCUMENTS, INCLUDING ALL NOTES REGARDLESS OF TIME AND MATERIAL NECESSARY TO EXECUTE THIS WORK. ANY AREAS INDICATED WITHIN DRAWINGS ARE ONLY SUGGESTIVE IN NATURE. MASON TO MEET WITH ARCHITECT AND OWNER TO CONFIRM THE SCOPE OF WORK.
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EXTERIOR ELEVATION MATERIAL LEGEND

LMSTN-1 LIMESTONE - EXISTING

BRK-1 TAN BRICK - NEW

GRN-1 GRANITE BASE - NEW

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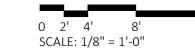
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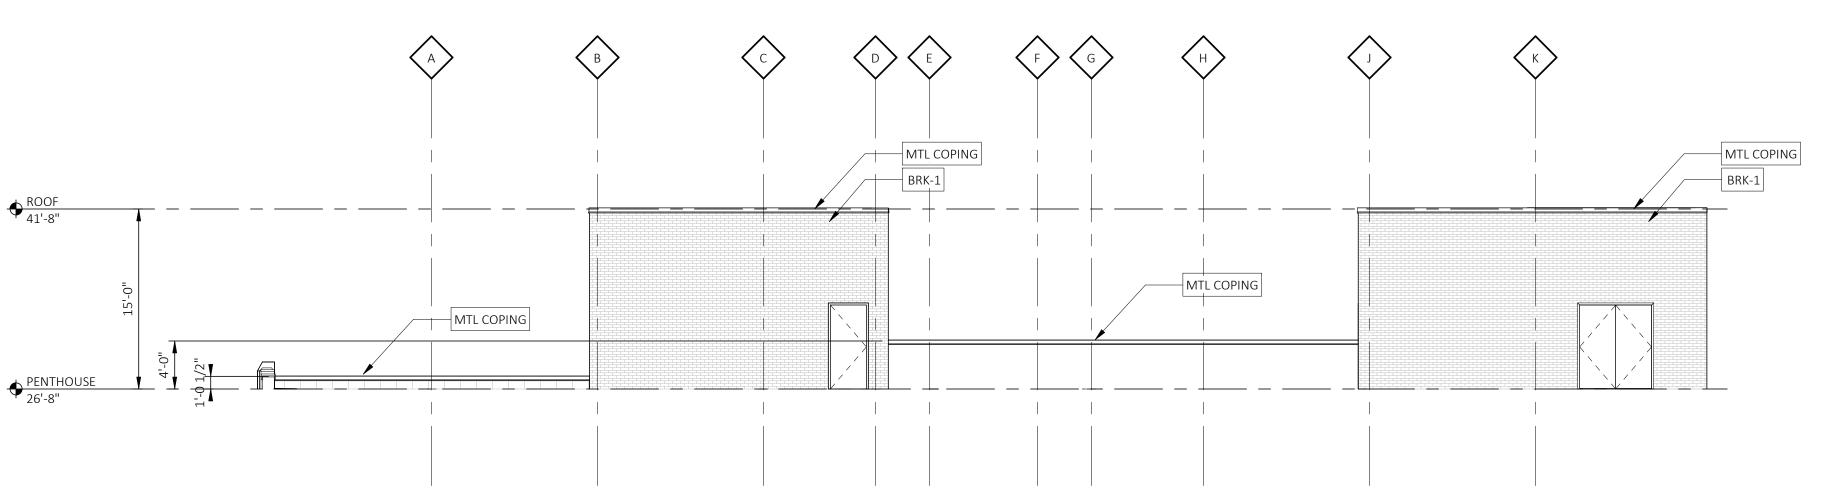
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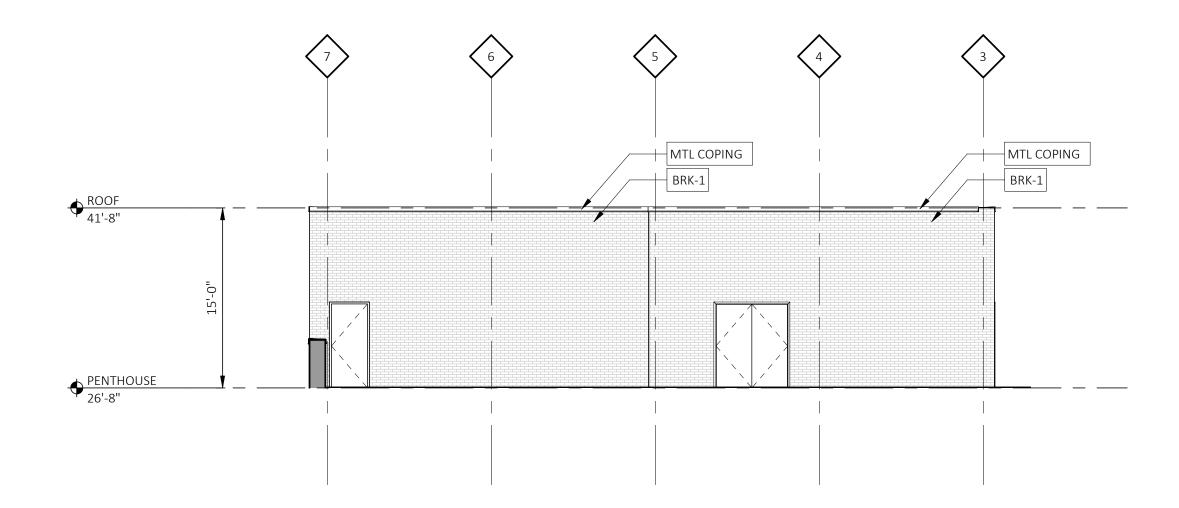
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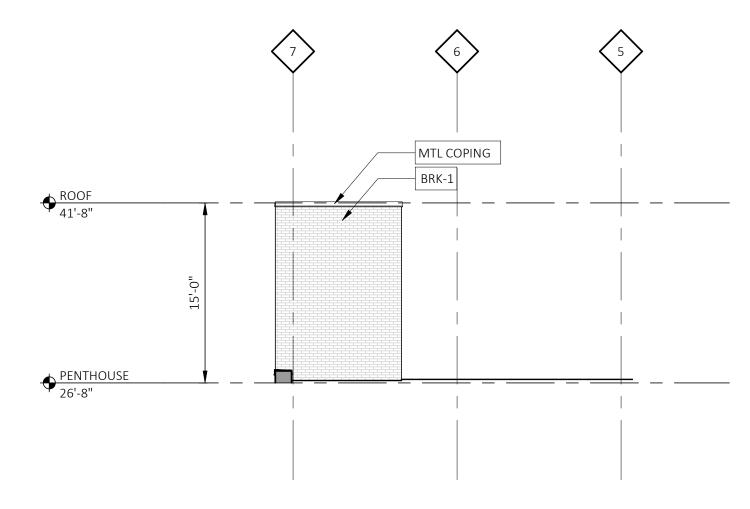












4 SOUTH PENTHOUSE ELEVATION

SCALE: 1/8" = 1'-0"
REFERENCE LOCATIONS: A103

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EXTERIOR ELEVATION MATERIAL LEGEND

LMSTN-1 LIMESTONE - EXISTING

BRK-1 TAN BRICK - NEW

GRN-1 GRANITE BASE - NEW

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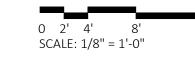
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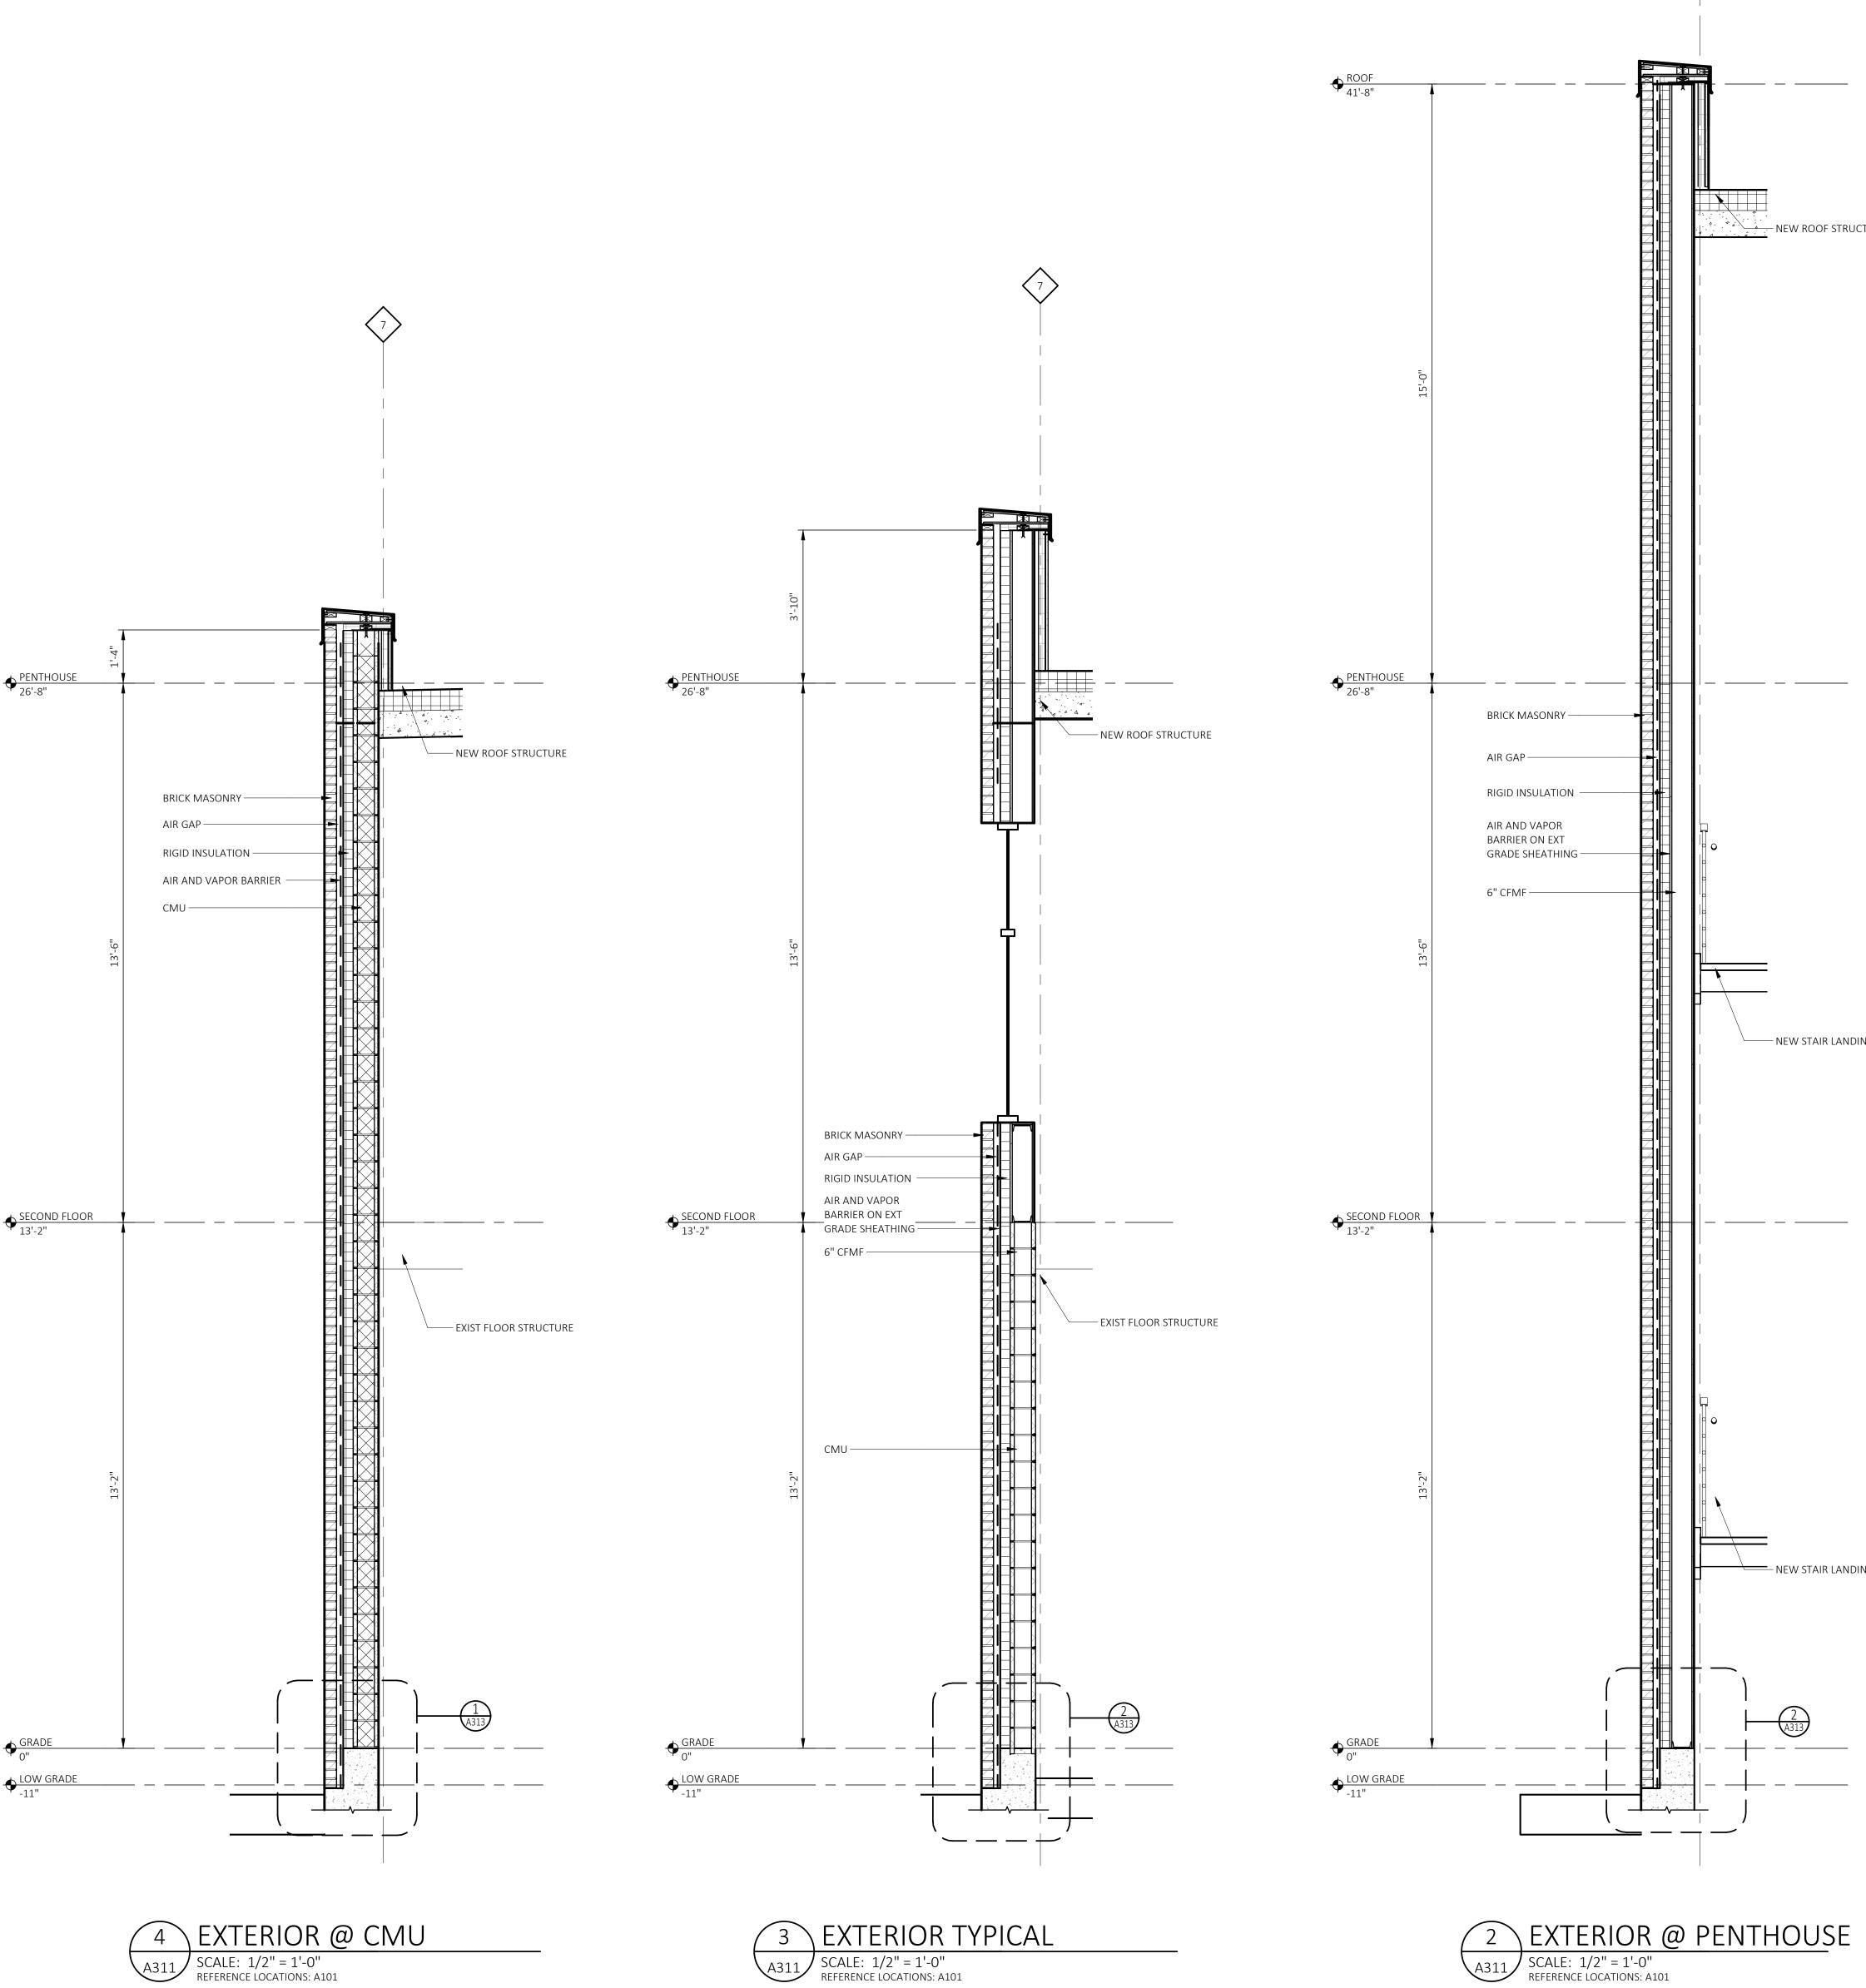
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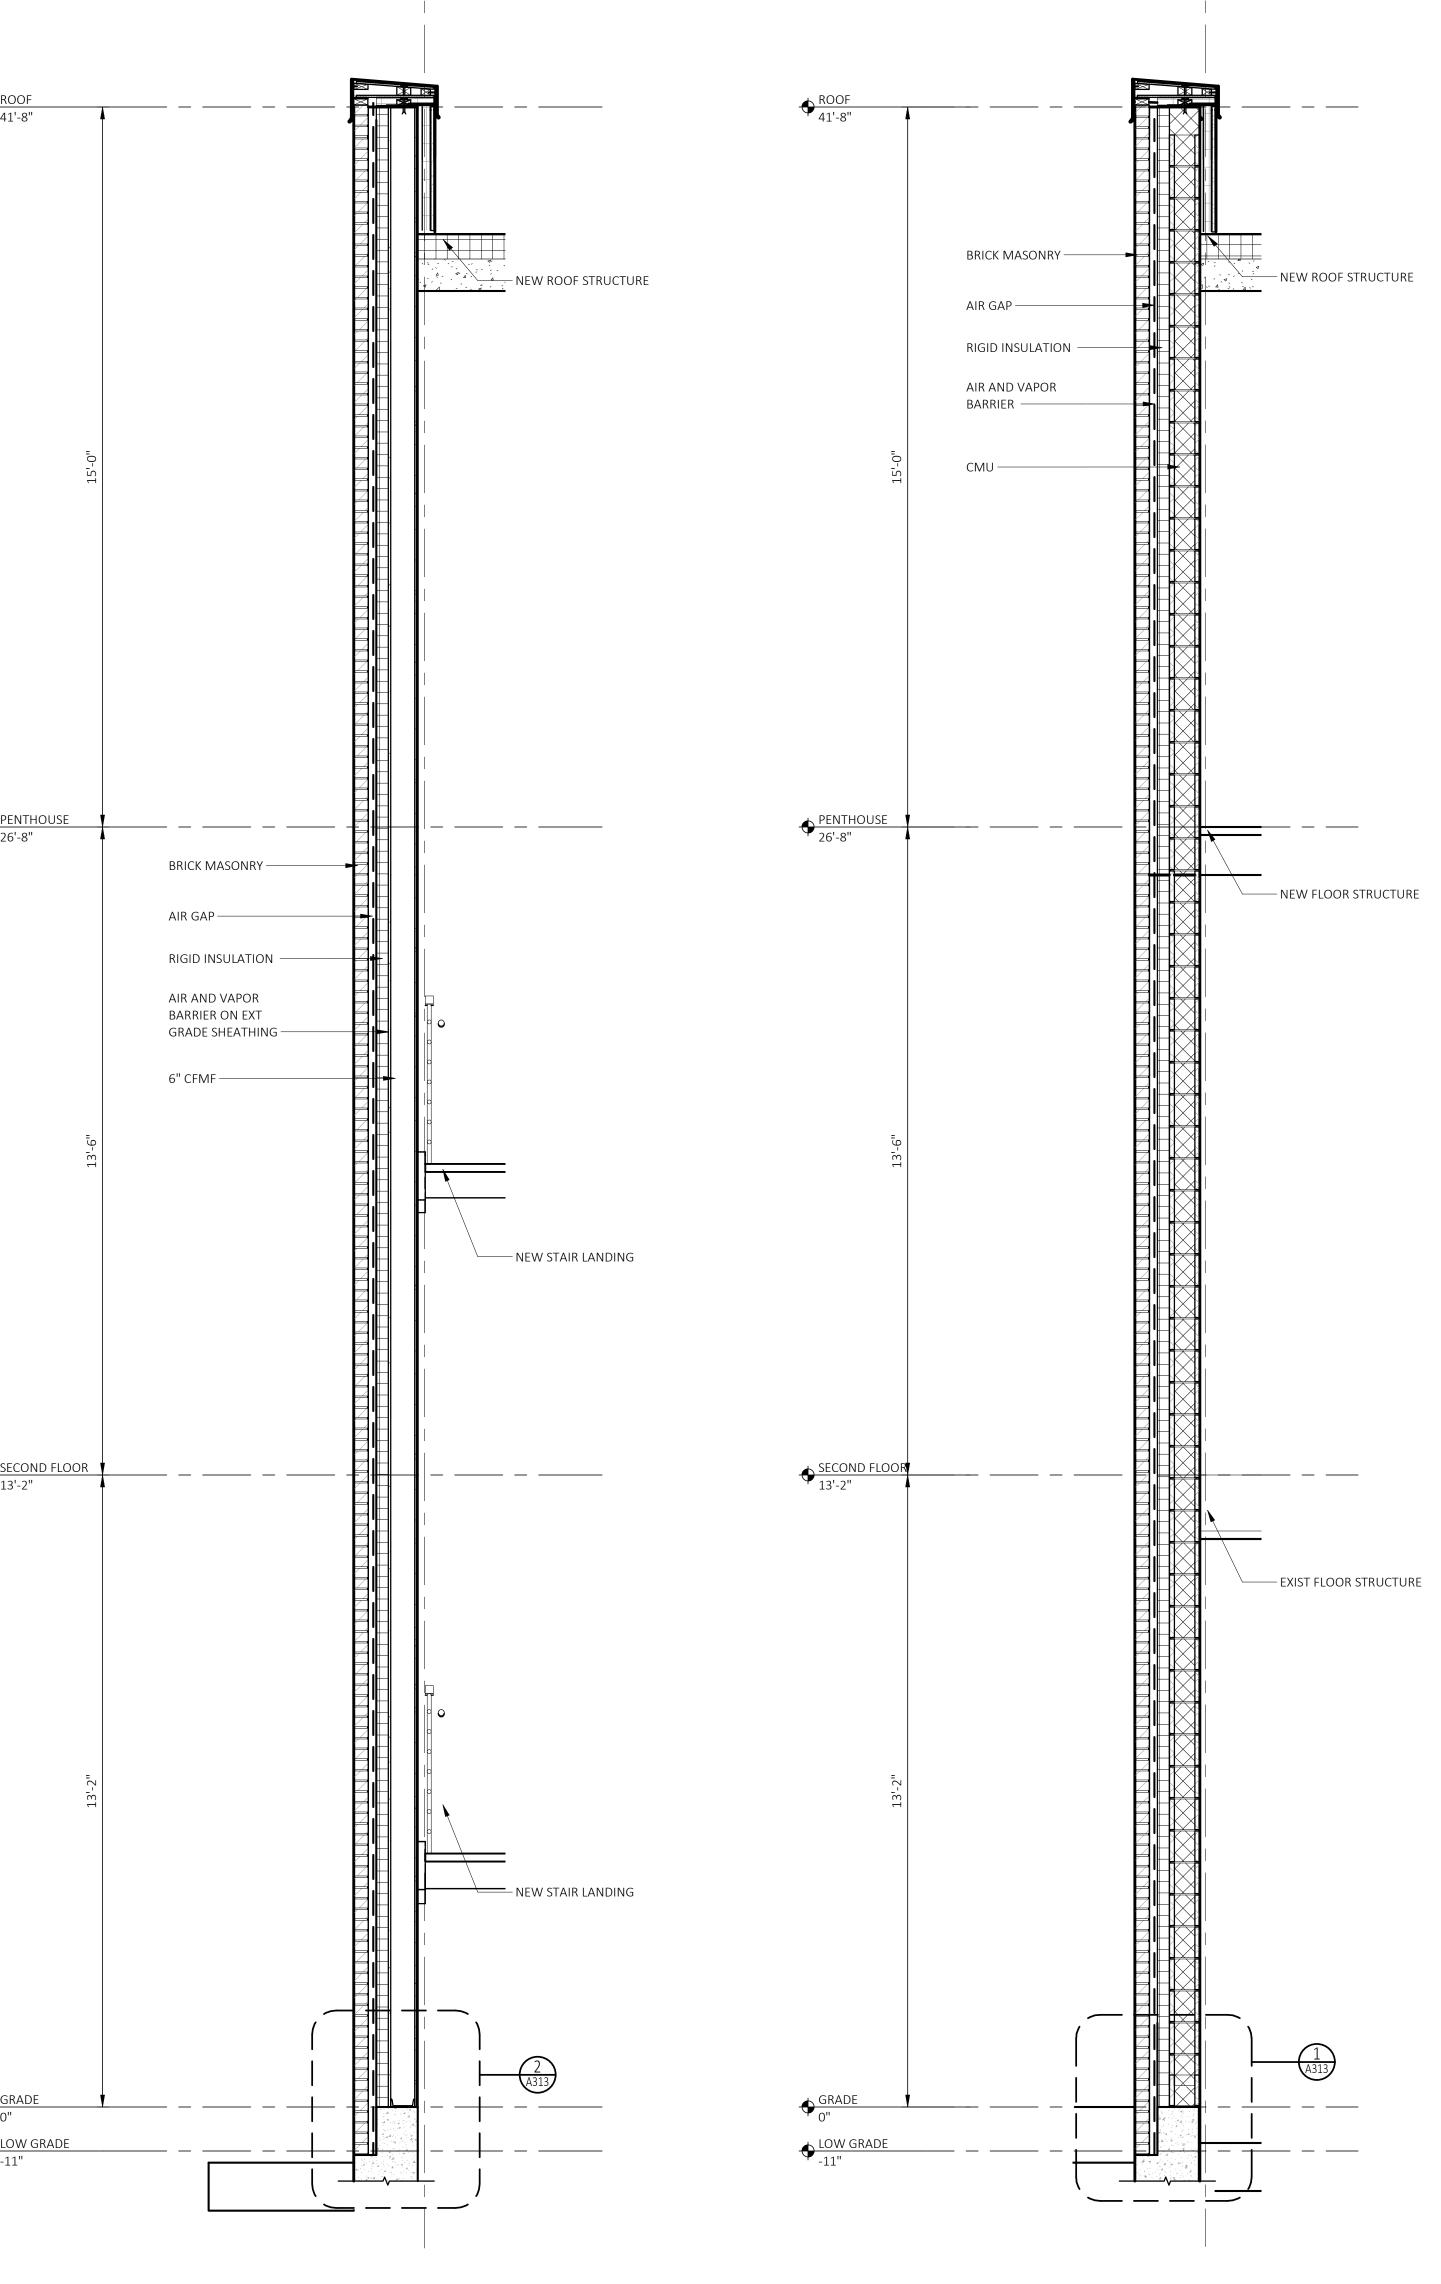
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ELEVATIONS

Sheet Number








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EXTERIOR WALL
SECTIONS Sheet Number

1 EXTERIOR @ CMU PENTHOUSE

SCALE: 1/2" = 1'-0"
REFERENCE LOCATIONS: A101


-SOFFIT 3 EXTERIOR @ TENANT ENTRY

SCALE: 1/2" = 1'-0"
REFERENCE LOCATIONS: A100

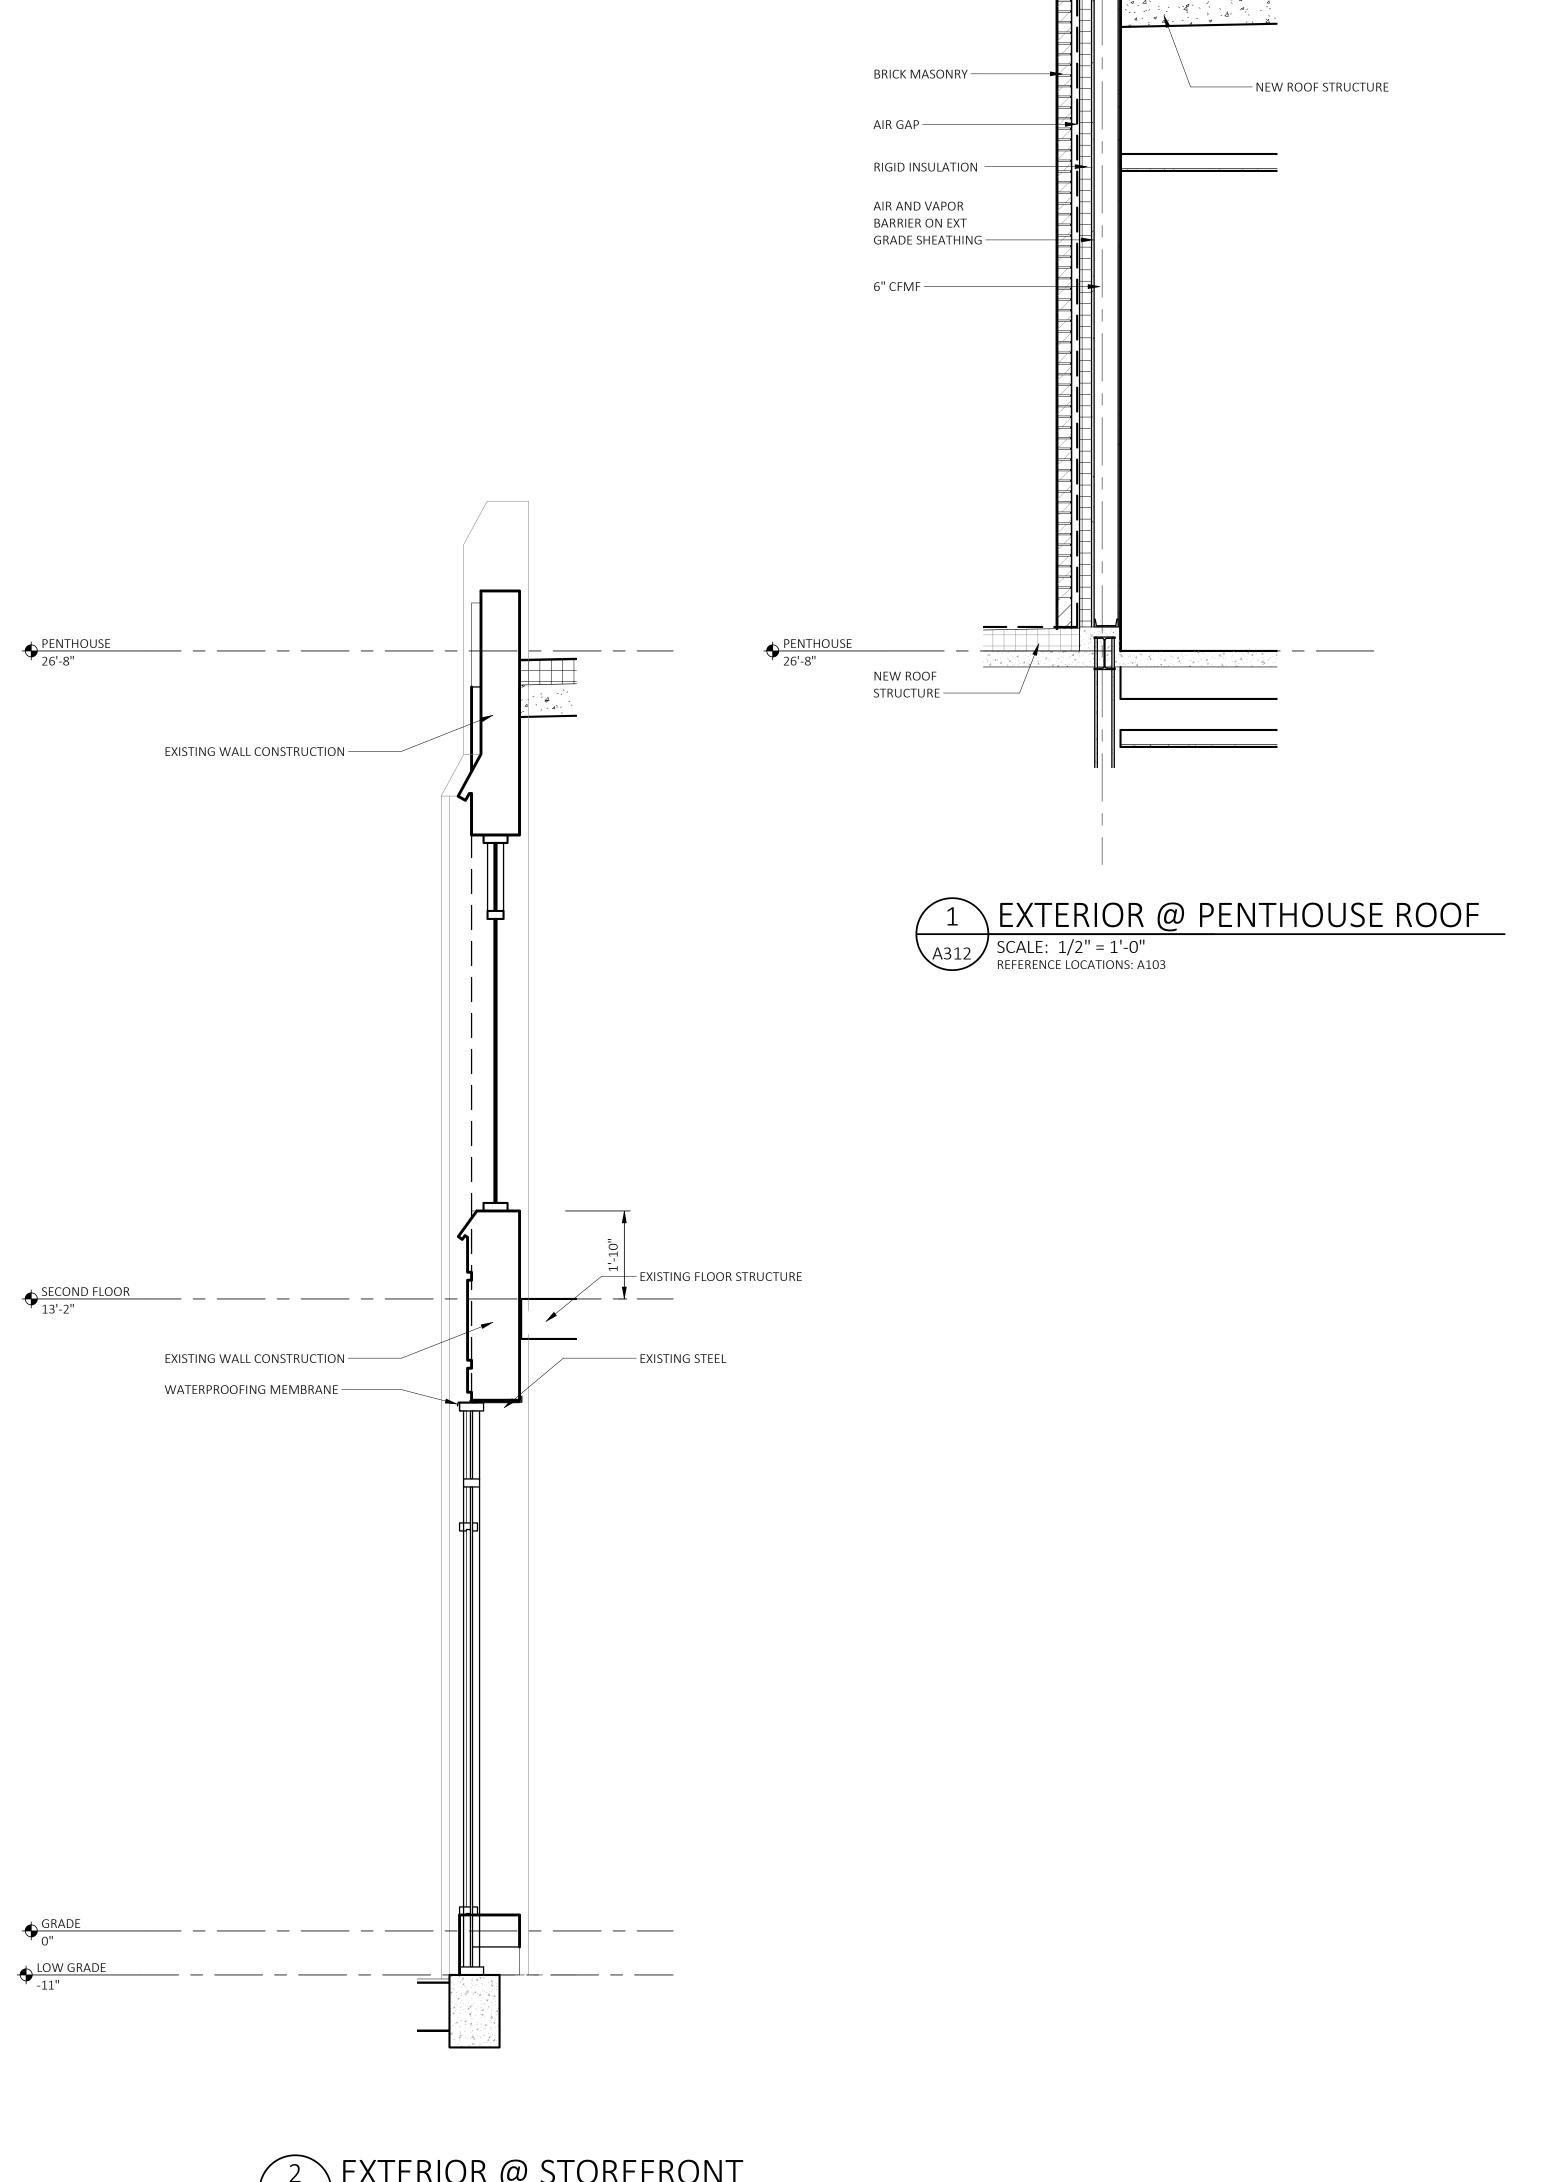

2 EXTERIOR @ STOREFRONT

SCALE: 1/2" = 1'-0"
REFERENCE LOCATIONS: A100

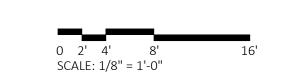

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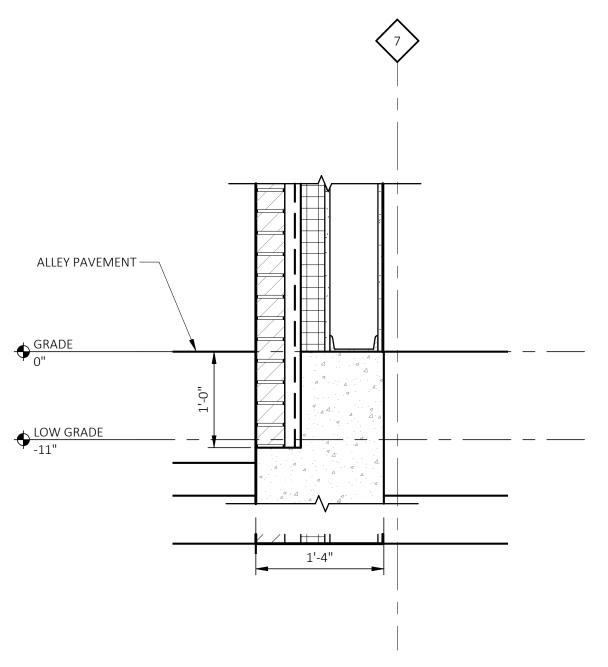
EXTERIOR WALL

SECTIONS

Sheet Number


1 BASE WALL DETAIL @CMU

SCALE: 1" = 1'-0"
REFERENCE LOCATIONS: A311




BASE WALL DETAIL @MTL STUDS

SCALE: 1" = 1'-0"
REFERENCE LOCATIONS: A311

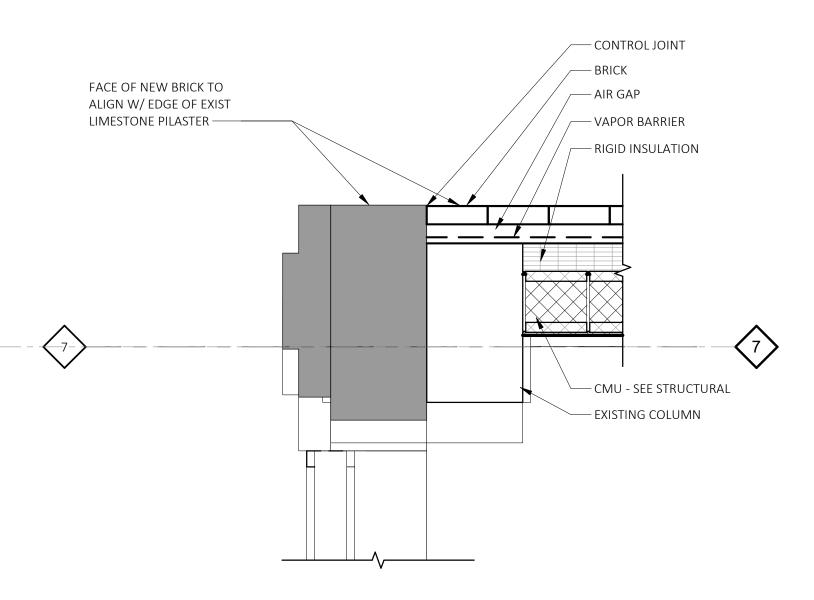

3 WALL DETAIL @ CORNER

SCALE: 1" = 1'-0"
REFERENCE LOCATIONS: A101

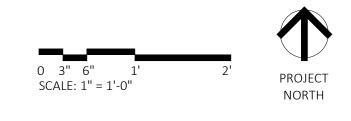



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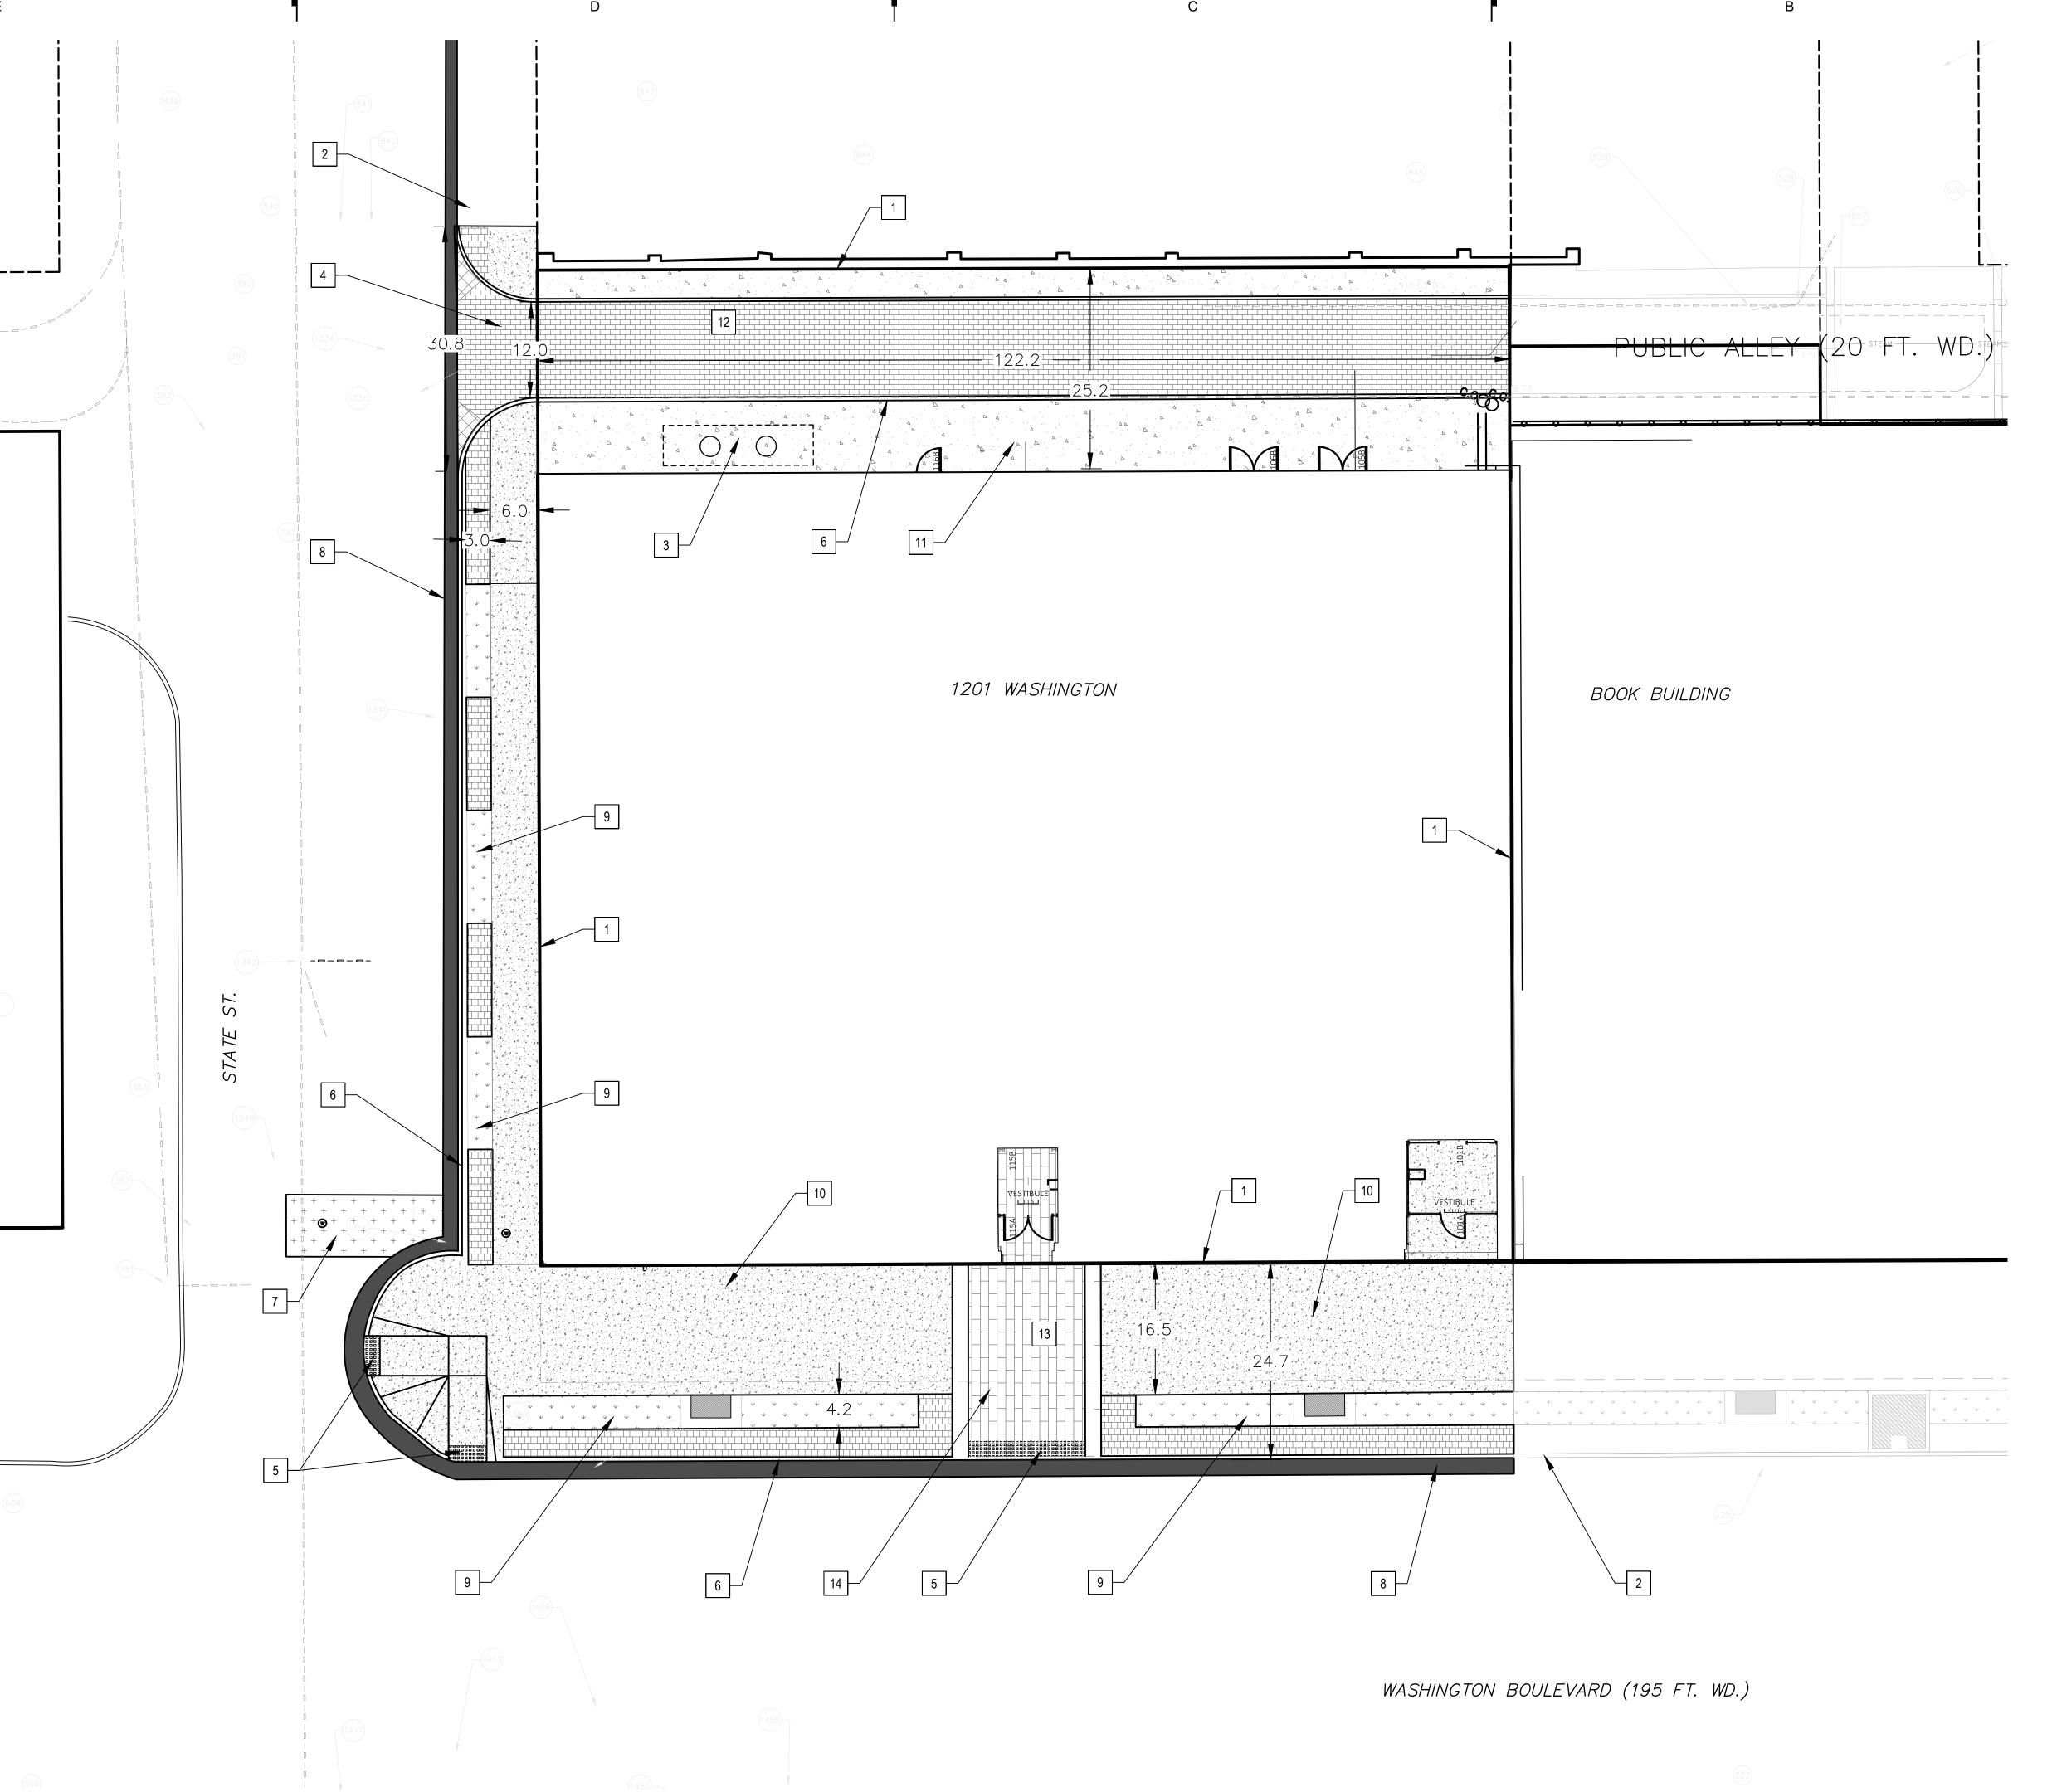


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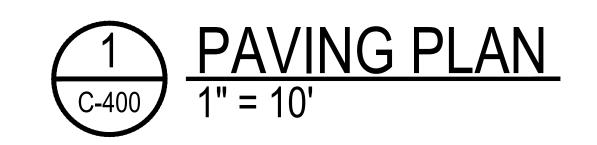
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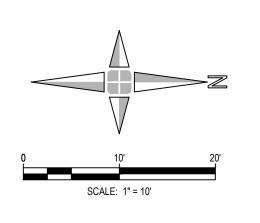
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EXTERIOR WALL
SECTIONS


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OLD Drawing -Revised Paving Plan on following page







PAVING PLAN - LEGEND
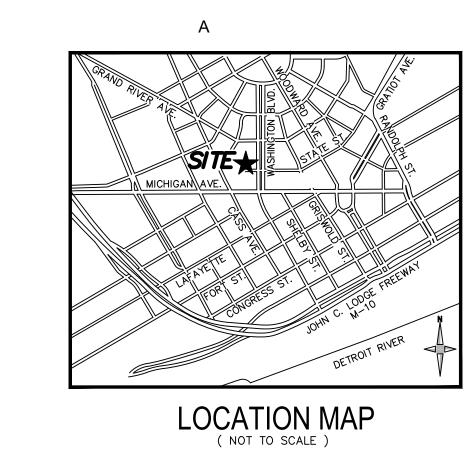
| COMPOSITE PAVEMENT REPAIR | + |
|----------------------------|--|
| ASPHALT PAVEMENT REPAIR | |
| LANDSCAPE | \(\psi\) \(\ |
| CONCRETE SIDEWALK PAVEMENT | |
| CONCRETE ALLEY PAVEMENT | 4 |
| COBBLE PAVERS | |
| PERMEABLE PAVERS | |
| LIMESTONE PAVERS - TYPE A | |
| LIMESTONE PAVERS - TYPE B | |

PAVING PLAN - KEY NOTES

EXISTING PROPERTY LINE, TYP. PROTECT ADJACENT EXISTING CURB THROUGH CONSTRUCTION, TYP.

PROPOSED LOCATION FOR NEW DTE NETWORK/TRANSFORMER PEDESTAL

NEW DRIVE APPROACH WITH 6" CONCRETE SIDEWALK ON BOTH SIDES, SEE DETAIL SHEET X-XXX, TYP.

NEW DETECTABLE WARNING STRIP PER CITY OF DETROIT STANDARDS, SEE DETAIL SHEET X-XXX, TYP.


NEW GRANITE CURB, SEE DETAIL SHEET X-XXX, TYP.

COMPOSITE PAVEMENT REPAIR FOR INSTALLATION OF NEW UTILITIES PER CITY OF DETROIT STANDARDS AND SPECIFICATIONS, SEE DETAIL SHEET X-XXX, TYP. ASPHALT PAVEMENT REPAIR, 2'-0" WIDE (MIN.), PER CITY OF DETROIT STANDARDS AND SPECIFICATIONS. EXISTING STREET ASPHALT PAVEMENT SHALL BE MILLED AND REPAIRED TO NEW GUTTER GRADE PER GRADING PLAN. ASPHALT PAVEMENT SHALL AN INSTRUMENT OF PROFESSIONAL SERVICE ARE THE PROPERTY OF KRAEMER DESIGN GROUP, LLC AND ARE NOT TO BE USED IN WHOLE OR IN PART FOR ANY REASON WITHOUT THE WRITTEN AUTHORIZATION OF HAVE UNIFORM SLOPE TOWARDS FACE OF CURB. SEE DETAIL SHEET X-XXX, TYP. NEW LANDSCAPE, SEE SHEET X-XXX, TYP. NEW CONCRETE SIDEWALK PAVEMENT, SEE DETAIL SHEET X-XXX, TYP. NEW CONCRETE ALLEY PAVEMENT, SEE DETAIL SHEET X-XXX, TYP. NEW COBBLE PAVERS, SEE DETAIL SHEET X-XXX, TYP. NEW STONE PAVERS - TYPE A, SEE DETAIL SHEET X-XXX, TYP. NEW STONE PAVERS - TYPE B, SEE DETAIL SHEET X-XXX, TYP. SCHEMATIC DESIGN 12-10-20 Sheet Title
PAVING PLAN

GIFFELS WEBSTER


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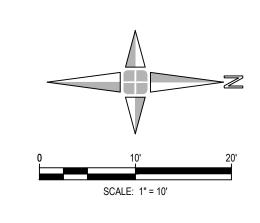
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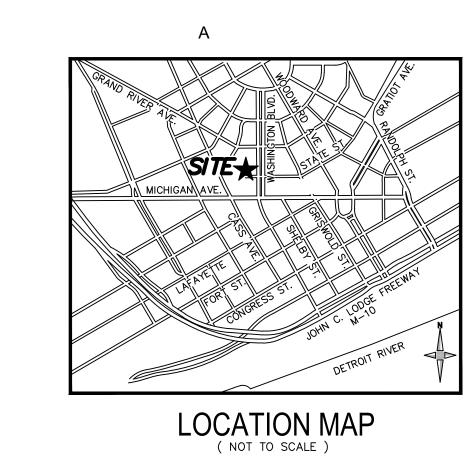


WASHINGTON BOULEVARD (195 FT. WD.)

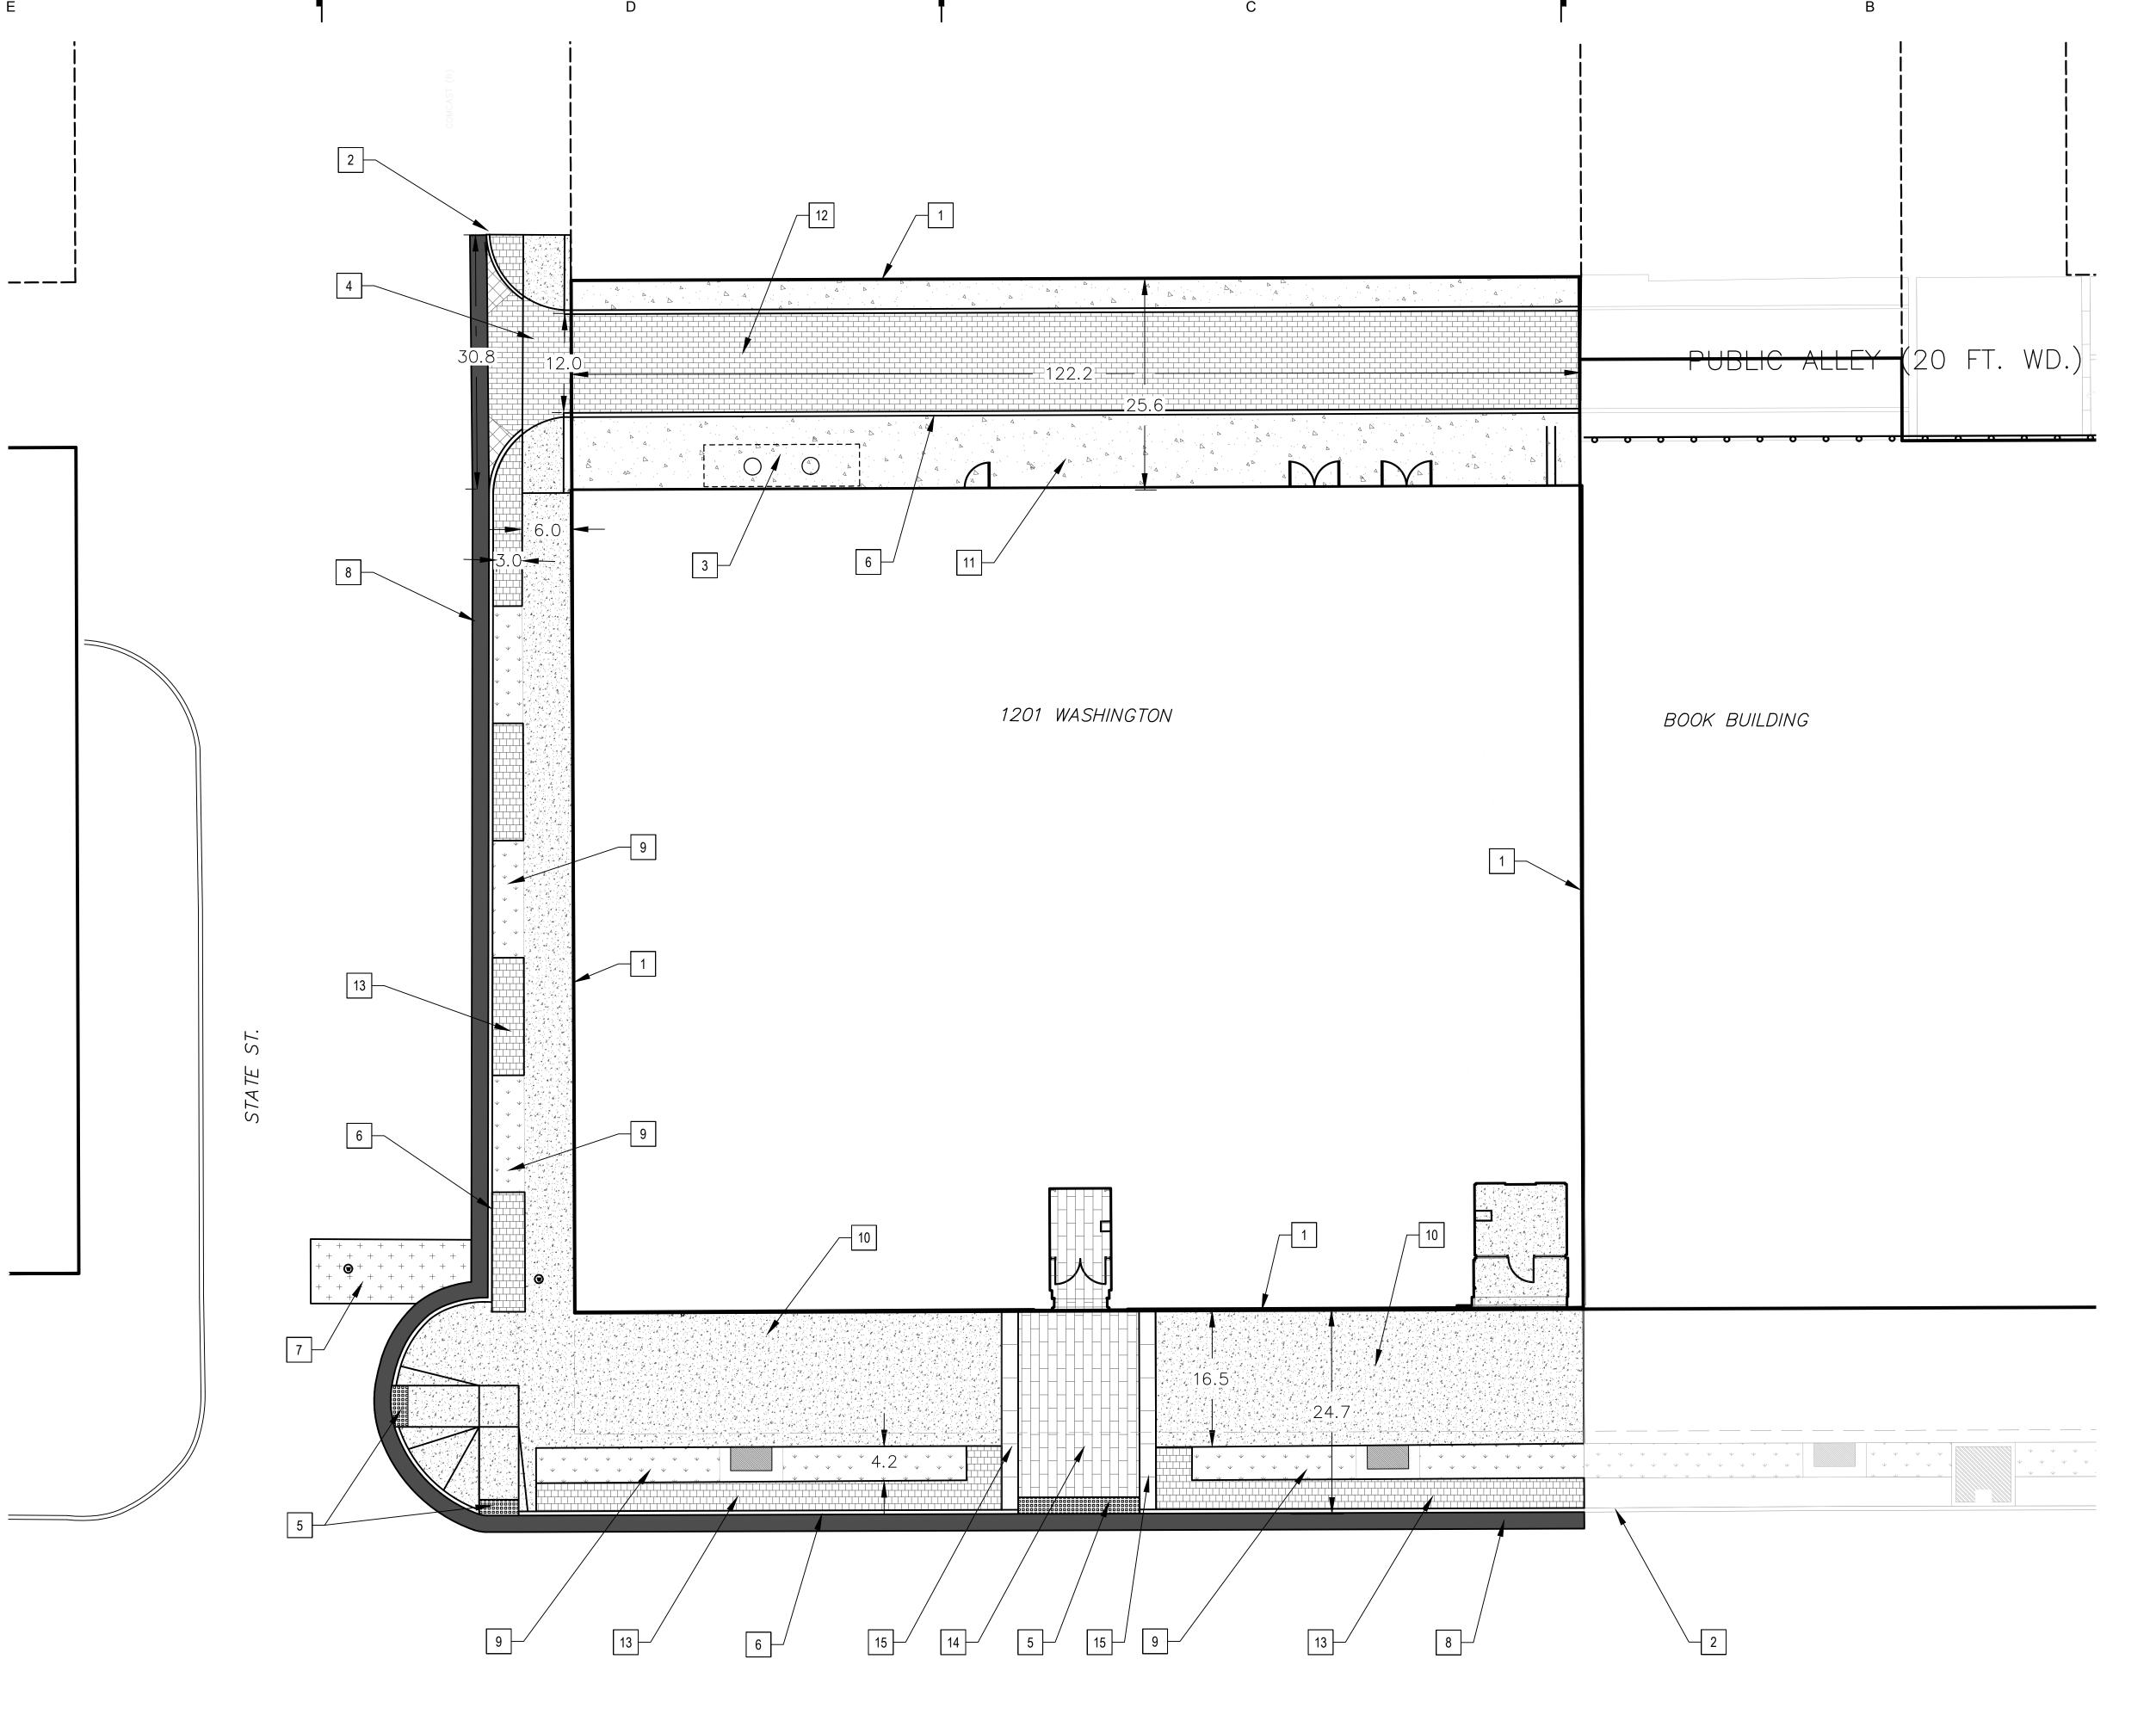05-10-22 Revised Paving Plan





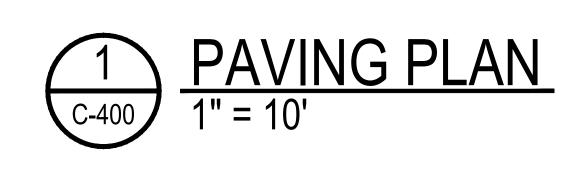

PAVING PLAN - LEGEND

| COMPOSITE PAVEMENT REPAIR | + |
|---------------------------------------|--|
| ASPHALT PAVEMENT REPAIR | |
| LANDSCAPE | \(\psi\) \(\ |
| CONCRETE SIDEWALK PAVEMENT | |
| CONCRETE ALLEY PAVEMENT | |
| COBBLE PAVERS | |
| PERMEABLE PAVERS (6" X 12") | |
| LIMESTONE PAVERS - TYPE A (18" X 24") | |
| LIMESTONE PAVERS - TYPE B (24" X 36") | |

PAVING PLAN - KEY NOTES

EXISTING PROPERTY LINE, TYP.

PROPOSED LOCATION FOR NEW DTE NETWORK/TRANSFORMER PEDESTAL

PROTECT ADJACENT EXISTING CURB THROUGH CONSTRUCTION, TYP.

NEW DRIVE APPROACH WITH 6" CONCRETE SIDEWALK ON BOTH SIDES,

SEE DETAIL SHEET X-XXX, TYP.

NEW DETECTABLE WARNING STRIP PER CITY OF DETROIT STANDARDS, SEE DETAIL SHEET X-XXX, TYP.

NEW GRANITE CURB, SEE DETAIL SHEET X-XXX, TYP.

COMPOSITE PAVEMENT REPAIR FOR INSTALLATION OF NEW UTILITIES PER CITY OF DETROIT STANDARDS AND SPECIFICATIONS, SEE DETAIL SHEET X-XXX, TYP.

ASPHALT PAVEMENT REPAIR, 2'-0" WIDE (MIN.), PER CITY OF DETROIT STANDARDS AND SPECIFICATIONS. EXISTING STREET ASPHALT PAVEMENT SHALL BE MILLED AND REPAIRED TO NEW GUTTER GRADE PER GRADING PLAN. ASPHALT PAVEMENT SHALL HAVE UNIFORM SLOPE TOWARDS FACE OF CURB. SEE DETAIL SHEET X-XXX, TYP.

NEW LANDSCAPE, SEE SHEET X-XXX, TYP.

NEW CONCRETE SIDEWALK PAVEMENT, SEE DETAIL SHEET X-XXX, TYP.

NEW CONCRETE ALLEY PAVEMENT, SEE DETAIL SHEET X-XXX, TYP.

NEW COBBLE PAVERS, SEE DETAIL SHEET X-XXX, TYP.

NEW PERMEABLE PAVERS (6" X 12"), SEE DETAIL SHEET X-XXX, TYP.

NEW LIMESTONE PAVERS - TYPE A (18" X 24"), SEE DETAIL SHEET X-XXX, TYP.

NEW LIMESTONE PAVERS - TYPE B (24" X 36"), SEE DETAIL SHEET X-XXX, TYP.

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02-23-21 SCHEMATIC DESIGN 12-10-20

PAVING PLAN

C-400

HVAC GENERAL NOTES

THESE DRAWINGS ARE DIAGRAMMATIC AND INDICATE THE GENERAL EXTENT OF THE WORK. PROVIDE HVAC SYSTEMS COMPLETE PER SPECIFICATION, SMACNA STANDARDS, AND PER APPLICABLE CODES INCLUDING ALL NECESSARY OFFSETS, FITTINGS, SPECIAL RADIUS OR MITERED ELBOWS WHICH ARE REQUIRED DUE TO SPACE CONSTRAINTS OR STRUCTURAL CONDITIONS OR OTHER CONDITIONS.
 CONTRACTOR SHALL COORDINATE THEIR WORK WITH THE WORK OF ALL OTHER TRADES. ALL DUCTWORK IS TO BE ROUTED AS HIGH AS POSSIBLE. PROVIDE ACCESS AROUND ALL NEW EQUIPMENT PER MANUFACTURER'S RECOMMENDATIONS. VERIFY ALL CLEARANCES PRIOR TO THE FABRICATION OF ANY WORK.

PRIOR TO THE FABRICATION OF ANY WORK.

3. DUCTWORK/PIPING SHALL BE ROUTED AS HIGH AS POSSIBLE AND SHALL NOT BE LOCATED OVER ELECTRICAL EQUIPMENT/PANELS. PROVIDE REQUIRED CLEARANCE IN FRONT OF ELECTRICAL EQUIPMENT. DUCTWORK/PIPING SHALL NOT INTERFERE WITH ELECTRICAL

EQUIPMENT CLEARANCE.
4. DUCTWORK/PIPING SHALL NOT BE INSTALLED IN A LOCATION THAT RESTRICTS THE ACCESS TO MECHANICAL DEVICES REQUIRING ACCESS.
5. THE CONTRACTOR SHALL PROVIDE ALL MISCELLANEOUS SUPPORTING STEEL, ETC. FOR THE PROPER INSTALLATION OF ALL MECHANICAL SYSTEMS.
6. COORDINATE FLOOR, WALL, ROOF PENETRATIONS, LOUVER SIZES, PAD LOCATIONS ETC.

WITH ARCHITECTURAL TRADES. SEAL ALL PIPING AND DUCT PENETRATIONS.
THE CONTRACTOR SHALL REFER TO ARCHITECTURAL REFLECTED CEILING PLANS FOR EXACT LOCATION OF GRILLES, REGISTERS, AND DIFFUSERS.
COORDINATE AND PROVIDE ACCESS DOORS IN HARD CEILING AREAS FOR ACCESS TO BALANCING DAMPERS, ETC. REFER TO ARCHITECTURAL DRAWINGS FOR CEILING TYPES.


BRANCH DUCTWORK TO GRILLES, REGISTERS AND DIFFUSERS SHALL BE THE SAME SIZE AS THE GRILLE, REGISTER OR DIFFUSER NECK SIZE WHERE NO DUCT SIZE IS INDICATED ON PLAN.
 MAXIMUM LENGTH OF FLEXIBLE DUCT SHALL BE 5'-0".
 FOR EQUIPMENT VALVING, COMPONENT, AND PIPING ARRANGEMENT, REFER TO PIPING DIAGRAMS AND DETAILS.

12. PAINT ALL VISIBLE INTERIOR SURFACES OF EXHAUST/RETURN GRILLES, REGISTERS AND VISIBLE ASSOCIATED DUCTWORK FLAT BLACK.

THE CEILING SPACE IS USED AS A RETURN AIR PLENUM. NO PLASTIC MATERIALS INCLUDING PVC PIPING, CONDUIT, WIRING, ETC. SHALL BE USED. ALL MATERIAL IN THE CEILING SPACE IS TO BE PLENUM RATED.
 PROVIDE CODE REQUIRED CLEARANCE/ACCESS DOORS FOR DAMPERS, VALVES, AND CLEANOUTS LOCATED IN WALLS OR ABOVE HARD CEILINGS. COORDINATE LOCATIONS WITH ARCHITECT. REFER TO ARCHITECTURAL PLANS FOR CEILING TYPES.

DUCTWORK TO AND FROM VAV BOXES/TERMINAL UNITS SHALL BE EQUAL TO THE BOX CONNECTIONS SIZES UNLESS INDICATED OTHERWISE.
 CONNECTION TO EQUIPMENT SHALL BE VERIFIED WITH MANUFACTURER'S CERTIFIED DRAWINGS. TRANSITIONS TO ALL EQUIPMENT SHALL BE VERIFIED AND PROVIDED FOR EQUIPMENT FURNISHED.
 ALL BRANCH PIPING TO TERMINAL UNITS TO BE 3/4" UNLESS OTHERWISE NOTED.

HVAC KEYED NOTES

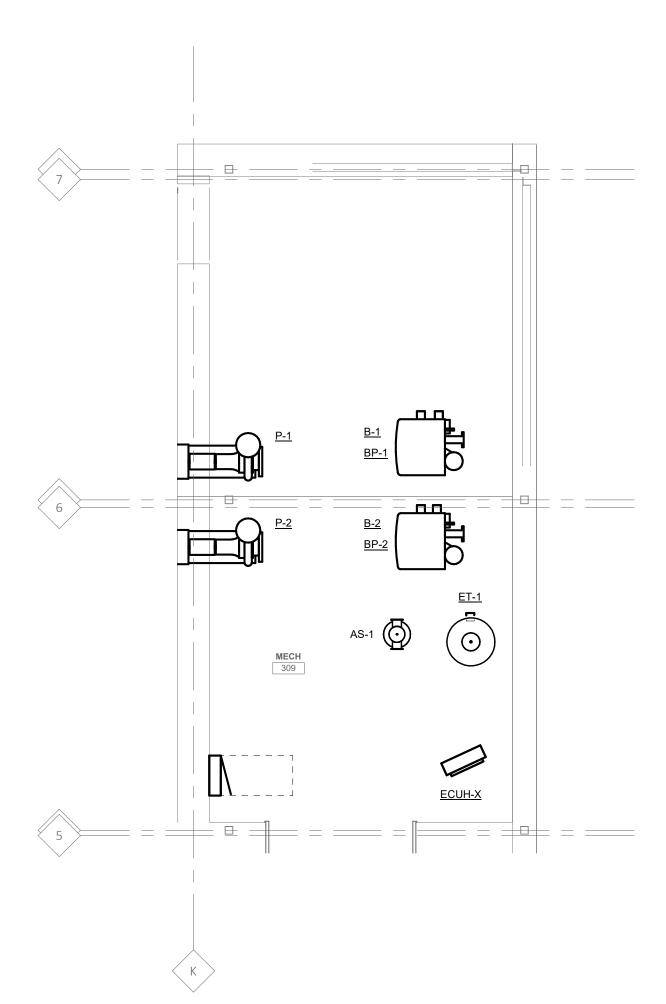

PENTHOUSE AND LOWER ROOF ENLARGED MECHANICAL PLAN
SCALE: 1/4" = 1'-0"

the proof of the state of the s

INNOVATIVE
PROPERTY
PARTNERS LLC
630 WOODWARD AVE.
DETROIT, MI

1201 WASHINGTON BLVD.
1201 WASHINGTON BLVD.
DETROIT, MI

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05-13-22

Revision

Project Number

Sheet Title

PENTHOUSE AND LOWER ROOF MECHANICAL PLAN

Sheet Number

M-103









VIEW DOWN ALLEY













