FORREST HOME

Mount Park

Mount Park

Monopour

Control Park

Control Pa



ARCHITECT
ELISE DECHARD
END STUDIO, LLC
1533 MERRICK STREET
DETROIT, MI 48208
908.419.8398
ELISE@E-N-D-STUDIO.COM

CONTRACTOR TBD STRUCTURAL ENGINEER

PROJECT INFORMATION

OWNER: TOM & SHERRIE FORREST

ADDRESS: 1694 BAGLEY ST.

PARCEL ID NUMBER: 08000377

REGULATING BODY: CITY OF DETROIT

CODE: 2015 MICHIGAN RESIDENTIAL CODE

DETROIT, MI 48216

LUTHER BEECHERS

ZONING: B2 - LOCAL BUSINESS AND RESIDENTIAL

HISTORIC DISTRICT: CORKTOWN

SUBDIVISION:

ZONING REVIEW

PRIMARY STRUCTURE REGULATIONS

MAX. BUILDING HEIGHT
MAX. STORIES
MAX. LOT COVERAGE

MIN. LOT WIDTH
MIN. LOT AREA

35'
NOT LISTED

NOT LISTED

6,000 SF

FRONT YARD SETBACK 20'
REAR YARD SETBACK 30'
SIDE YARD SETBACK 6'-7

6'-7 3/4" (FORMULA A)
CAN BE REDUCED TO 3' MIN., 10' COMBINED
PER DETROIT ZONING SEC. 50-13-24.

EXISTING

USE TWO-FAMILY RESIDENTIAL

FRONT YARD SETBACK 14' - 4"

REAR YARD SETBACK 49' - 1 3/4"

SIDE YARD SETBACK 1'-0" TO 8'-0" EAST / 2'-0" TO 2'-5" WEST

EX. HOUSE AREA 1,806 SF EX. BUILDING HEIGHT 19'-8" STORIES 1

PROPOSED

USE TWO-FAMILY RESIDENTIAL

EX. HOUSE FOOTPRINT 1,628 SF
ADDITION FOOTPRINT 170 SF
EX. ACCESSORY FOOTPRINT 435 SF
TOTAL FOOTPRINT 2,233 SF
LOT COVERAGE 52% · N/A


FRONT YARD SETBACK 14'-4"
REAR YARD SETBACK 49' - 1 3/4"

SIDE YARD SETBACK 1'-0" TO 8'-0" EAST / 2'-0" TO 3'-3/4" WEST

HOUSE AREA 1812 SF
BUILDING HEIGHT 19'-8"
STORIES 1

SHEET LIST

#	DRAWING NAME	HDC SUBMISSION SET AUGUST 16, 2021
T-000	TITLE SHEET & SITE PLAN	•
G-001	GENERAL NOTES	•
D-100	DEMO PLANS	•
A-000	SCHEDULES	•
A-101	FIRST FLOOR, FOUNDATION & ROOF PLAN	•
A-121	FRAMING PLANS	
A-201	FIRST FLOOR RCP	
A-300	EXTERIOR ELEVATIONS	•
A-400	BUILDING SECTION	
A-600	INTERIOR ELEVATIONS	
A-700	INTERIOR DETAILS	
E-101	ELECTRICAL PLANS	
M-101	MECHANICAL & PLUMBING PLANS	

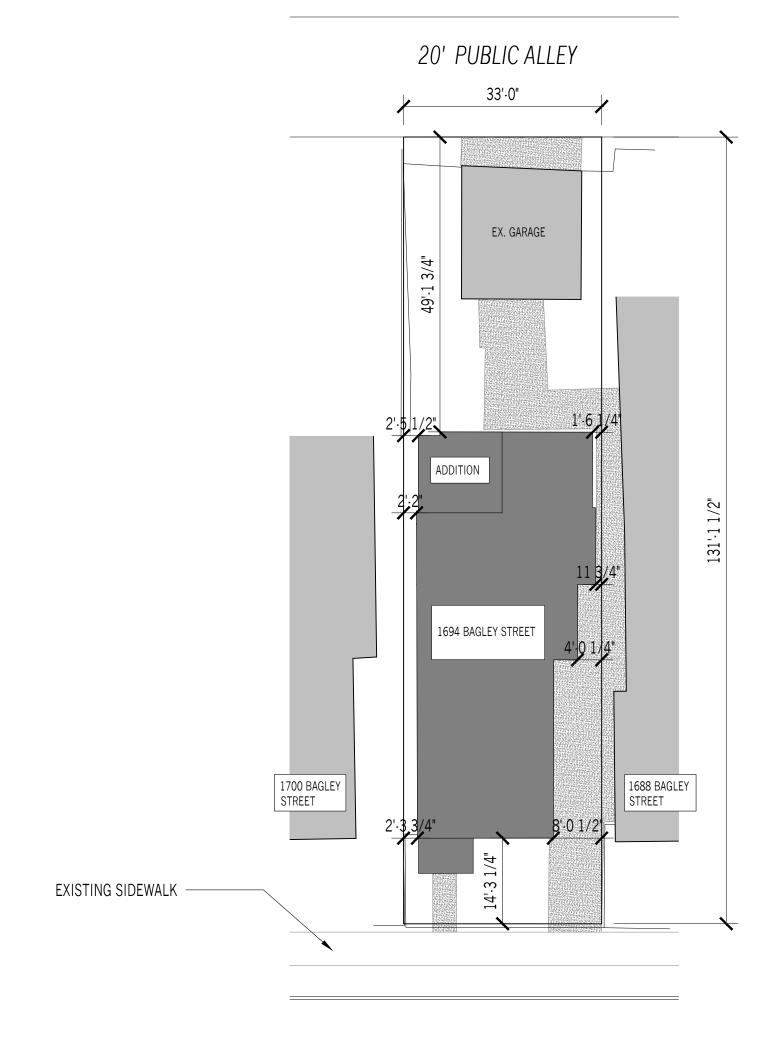

BAGLEY STREET R.O.W.

 $O1 \frac{\text{SITE PLAN}}{\text{SCALE: } 1/16" = 1' \cdot 0"}$



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NO. ISSUE/REV. DATE

--- HDC SUBMISSION 08/16/21

TITLE &
SITE PLAN

T-000

MATERIAL KEY EXISTING WALL TO DRYWALL / PLASTER REMAIN EARTH / SOIL **NEW WALL** CONSTRUCTION CAST IN PLACE PLYWOOD CONCRETE CONCRETE MASONRY UNIT (CMU) **BRICK MASONRY** WOOD - DIMENSIONAL WOOD - BLOCKING CRUSHED STONE **BATT INSULATION** STEEL SPRAY FOAM ALUMINUM INSULATION DEMO WALL RIGID INSULATION DRAWING SYMBOL KEY 101 SECTION **ROOM TAG ROOM NAME** DWG NUMBER ## SF SHEET NUMBER DOOR TAG 1.01 (01) WINDOW TAG **F** FLOOR \longrightarrow A W WALL PLUMBING /EQUIP TAG CEILING (P-1)-----BASE BASE FINISH TAG TRIM A-301 EXTERIOR ELEVATION CROWN DWG NUMBER MILLWORK SHEET NUMBER MOON CROWN INTERIOR 4 (A-801 ELEVATION(S) **REVISION TAG** —— - - — LOT LINE STRUCTURAL

GRID LINE

ELEVATION MARKER

LIGHTING TAG

EXHAUST FAN

FLOOR/CLNG SUPPLY REGISTER

FLOOR/CLNG RETURN GRILLE

WALL/HORIZ. SUPPLY REGISTER

WALL/HORIZ. SUPPLY REGISTER

CEILING GRID SUPPLY REGISTER

CEILING GRID RETURN GRILLE

ROUND SUPPLY REGISTER

LINEAR SLOT DIFFUSER

THERMOSTAT

MECHANICAL KEY

SYMBOL DESCRIPTION

 \bigcirc

—— SETBACK

PLUMBING KEY

SYMBOL DESCRIPTION

—— DRAIN PIPE

----- VENT PIPE

⋈ VALVE

---- HOT WATER SUPPLY

---- COLD WATER SUPPLY

PLUMBING DRAIN

FLOOR DRAIN

• ROOF DRAIN

ONE HOUR WALL

TWO HOUR WALL

POWER, DATA, & LIGHTING KEY

SYMBOL	DESCRIPTION	SYMBOL	DESCRIPTION
\Rightarrow	DUPLEX	\$	SWITCH
42"	DUPLEX - SPECIFIC MOUNTING HT.	\$D	DIMMER SWITCH
→ GFI	DUPLEX - GFI	\$3	THREE-WAY SWITCH
GFI UC	DUPLEX - UNDER CABINET GFI	\$ 3D	THREE-WAY DIMMER SWITCH
 	QUADPLEX	\$ J	JAMB SWITCH
	DUPLEX IN FLOOR	Y	TELEPHONE
<u>S</u> >	SMOKE DETECTOR	Y	INTERNET
<u>C</u> >	CARBON MONOXIDE DETECTOR	₹ÿ>	TELEVISION
S	SPEAKER LOCATION	\oplus	PENDANT FIXTURE
S _{IN}	SPEAKER INPUT		FLUSH MOUNT FIXTURE
0	RECESSED FIXTURE		LED STRIP LIGHT
2	WALL MOUNTED SCONCE		VENTILATION FAN
W	DENOTES WET-RATED FIXTURE	X	EXISTING FIXTURES, TYP.
$\overline{\nabla}$	TRACK LIGHTING		CEILING FAN
□ \ M	MOTION SENSOR FLOOD LIGHT	- \ \	REC. LIGHT VENT FAN COMBO
22	EXTERIOR FLOOD LIGHT		CAMERA

TYPICAL MOUNTING HEIGHTS OUTLET OUTL

FLOORING

GENERAL NOTES

- 1. ALL WORK SHALL BE DONE IN ACCORDANCE WITH THE REQUIREMENTS OF THE 2015 MICHIGAN RESIDENTIAL CODE AND ALL OTHER APPLICABLE LAWS, INCLUDING FIRE DEPARTMENT REGULATIONS, UTILITY COMPANY REQUIREMENTS, AND BEST TRADE PRACTICES.
 - CONTRACTOR SHALL FURNISH ALL MATERIALS, LABOR, INCIDENTALS, AND ANY OTHER ITEMS REQUIRED FOR THE COMPLETION OF THE WORK AS SHOWN IN THE CONTRACT DOCUMENTS, UNLESS OTHERWISE NOTED.
 - BEFORE COMMENCING WORK, THE CONTRACTOR SHALL FILE ALL REQUIRED CERTIFICATES OF INSURANCE WITH THE BUILDING DEPARTMENT, OBTAIN ALL REQUIRED PERMITS, AND PAY ALL FEES REQUIRED BY GOVERNING AGENCIES.
- 4. NOTIFY ARCHITECT FOR CLARIFICATION IN CASE OF ANY DISCREPANCIES, CONFLICTS, OR OMISSIONS IN THE CONSTRUCTION DRAWINGS AND SPECIFICATIONS. AN ADDENDUM TO THE CONTRACT DOCUMENTS WILL BE PROVIDED AS NECESSARY.
- 5. CONTRACTOR SHALL VERIFY ALL EXISTING CONDITIONS AND DIMENSIONS SHOWN ON PLANS AT THE JOB SITE BEFORE COMMENCING ANY WORK, AND SHALL REPORT ANY DISCREPANCIES BETWEEN DRAWINGS AND FIELD CONDITIONS TO THE ARCHITECT.
- 6. DIMENSIONING RULES:
 - 6.1. DIMENSIONS ARE TAKEN FROM FACE OF FINISHED SURFACE TO FACE OF FINISHES SURFACE, UNLESS OTHERWISE NOTED.
 - 6.2. DIMENSIONS MARKED "VERIFY", "VERIFY IN FIELD" OR "VIF" SHALL BE FIELD VERIFIED BY THE CONTRACTOR AND DISCUSSED WITH THE ARCHITECT IF DISCREPANCIES ARISE.
 - 6.3. DIMENSIONS MARKED "CLEAR" OR "CLR" OR "HOLD" MUST BE PRECISELY
 - 6.4. DIMENSIONS ARE NOT ADJUSTABLE WITHOUT APPROVAL BY ARCHITECT UNLESS MARKED "+/-"
- 7. THE CONTRACTOR SHALL LAY OUT THEIR OWN WORK, AND SHALL PROVIDE ALL DIMENSIONS REQUIRED FOR OTHER TRADES (MECHANICAL, ELECTRICAL, PLUMBING, ETC).
- 8. THE CONTRACTOR IS NOT TO SCALE DRAWINGS OR DETAILS, ONLY WRITTEN DIMENSIONS SHALL BE USED. WHERE REQUIRED DIMENSIONS ARE MISSING, NOTIFY ARCHITECT FOR CLARIFICATION.
- . ABBREVIATIONS ON THE DRAWINGS ARE AS NOTED IN THE KEY. NOTIFY ARCHITECT OF ANY ABBREVIATIONS IN QUESTION.
- 10. SUBMIT SHOP DRAWINGS, MOCK-UPS, SAMPLES, AND OTHER REQUIRED SUBMITTALS IN A TIMELY FASHION AND ALLOW ARCHITECT SUFFICIENT TIME, MINIMUM OF (5) WORKING DAYS, FOR REVIEW PRIOR TO FABRICATION OR ORDER PLACEMENT.

DEMO PLAN NOTES

HOT WATER HEATER

- 1. DEMOLITION SHALL COMPLY WITH ALL APPLICABLE LOCAL, STATE, AND FEDERAL CODES, ORDINANCES, AND REGULATIONS PERTAINING TO SAFETY OF PERSONS, PROPERTY, AND ENVIRONMENTAL PROTECTION.
- 2. ALL EXISTING WALLS, GLAZING, AND OTHER WORK TO REMAIN SHALL BE FULLY PROTECTED FROM DAMAGE PROVIDE BRACING OR SHORING AS REQUIRED TO SUPPORT THE STRUCTURE DURING DEMOLITION. THE CONTRACTOR SHALL ASSUME FULL RESPONSIBILITY FOR DAMAGE AND SHALL MAKE REQUIRED REPAIRS WITHOUT ADDITIONAL COST TO THE OWNER. REPAIR DAMAGED SURFACES TO MATCH ADJACENT SURFACES

- COORDINATE DEMOLITION REQUIRED TO PERFORM NEW WORK WITH CONTRACT DOCUMENTS. NOTIFY ARCHITECT OF ANY DISCREPANCIES.
- 4. REMOVE ABANDONED HVAC EQUIPMENT, DUCTWORK, ELECTRICAL, AND PLUMBING BACK TO THEIR PRIMARY SOURCE OR AS DIRECTED. DISCONNECT, CAP, AND IDENTIFY ALL UTILITIES IN AREAS OF DEMOLITION. MAINTAIN UTILITIES TO ALL OCCUPIED AREAS OF THE BUILDING AND COORDINATE TEMPORARY DISRUPTION WITH OWNER AND ANY OTHER AFFECTED PARTIES.
- 5. CAREFULLY REMOVE, PROTECT, AND STORE FOR REINSTALLATION OR SALVAGE ALL: LIGHT FIXTURES, PLUMBING FIXTURES, DOORS, FIRE SAFETY & EMERGENCY FIXTURES.
- 5. PROVIDE ENCLOSURE AND PROTECTION AS REQUIRED TO CONTAIN SPREAD OF ALL DUST, FUMES, ETC. PRODUCED DURING DEMOLITION AND CONSTRUCTION.
- 7. REMOVE AND LEGALLY DISPOSE OF ALL DEBRIS, RUBBISH, AND OTHER MATERIALS RESULTING FROM DEMOLITION OR CONSTRUCTION. IN OCCUPIED AREAS, CLEAN AND DISPOSE OF MATERIALS DAILY.
- 8. REMOVE TOOLS AND EQUIPMENT FROM SITE UPON COMPLETION OF WORK. LEAVE AREAS AND SITE BROOM SWEPT, ORDERLY, AND IN CONDITION ACCEPTABLE FOR CONSTRUCTION.

POWER, LIGHTING, & RCP NOTES

- 1. UNLESS OTHERWISE NOTED, ALL RECEPTACLES & LIGHT FIXTURES SHALL BE CENTERED ON WALL OR BETWEEN OR BENEATH THE WINDOWS, DOORS, OTHER WORK, OR OTHER FIXTURES THEY ARE LOCATED IN RELATION TO.
- 2. RECEPTACLES SHOULD BE MOUNTED TO MATCH THE HEIGHT AND ORIENTATION OF EXISTING RECEPTACLES IN ROOM. SWITCHES TO BE MOUNTED TO MATCH THE HEIGHT OF EXISTING SWITCHES IN ROOM. IF NO REFERENCE EXISTS, ALL RECEPTACLES & LIGHT FIXTURES SHALL BE MOUNTED AT THE HEIGHTS SPECIFIED IN THE TYPICAL MOUNTING HEIGHTS DIAGRAM, UNLESS OTHERWISE NOTED.
- 3. SWITCHES, FIXTURES, AND RECEPTACLES SHOWN ADJACENT ON PLAN WITH DIMENSION ONLY TO ONE OF THEM SHOULD BE COMBINED IN BANKS OR STACKED VERTICALLY.
- 4. CONTRACTOR TO COORDINATE ALL APPLIANCE-SPECIFIC OUTLETS WITH APPLIANCE SELECTION.
- 5. EXISTING OUTLETS, FIXTURES, AND SWITCHES NOT SHOWN ON PLAN TO REMAIN AND BE REUSED.
- 6. OUTLETS AND SWITCHES SHOULD NOT BE INSTALLED BACK-TO-BACK WITHOUT SEPARATING STUD OR INSULATION.
- 7. PROVIDE GFCI OUTLETS AND WET-RATED FIXTURES IN ALL WET AREAS, OUTDOOR AREAS, AND ANY OTHER LOCATION REQUIRED BY CODE.
- 8. ALL SWITCH PLATES AND OUTLETS COVERS, ETC., SHOULD BE INSTALLED AFTER PAINTING AND WALL COVERINGS ARE INSTALLED.PROTECTIVE COVERINGS ON ALL FIXTURES SHALL REMAIN IN PLACE UNTIL CONSTRUCTION IS COMPLETED. DAMAGED FIXTURES SHALL BE REPLACED AT THE CONTRACTORS EXPENSE.
- COORDINATE LIGHT FIXTURE AND MECHANICAL REGISTER LOCATIONS WITH ARCHITECT PRIOR TO INSTALLATION. IF ANY CONFLICT OCCURS BETWEEN THE WORK OF SEPARATE TRADES OR BETWEEN DRAWINGS AND EXISTING CONDITIONS, COORDINATE WITH ARCHITECT IN FIELD.

ABBREVIATIONS

COLD WATER

ABV	ABOVE			FLR	FLOOR	ID	INSIDE DIAMETER	MISC	MISCELLANEOUS	R	RISER	VNL	VINYL
ACOUS	ACOUSTICAL	DBL	DOUBLE	FLUOR	FLUORESCENT	IN	INCH	MMR	MOISTURE & MOLD	RAD	RADIUS	VERT	VERTICAL
ADA	AMERICANS WITH	DEMO	DEMOLITION	FND	FOUNDATION	INCAD	INCANDESCENT		RESISTANT	RD	ROOF DRAIN	VEST	VESTIBULE
	DISABILITIES ACT	DIA	DIAMETER	FP	FIRE PROOFING	INSUL	INSULATION	MO	MASONRY OPENING	RECT	RECTANGULAR	VIF	VERIFY IN FIELD
ADD	ADDITIONAL	DEG	DEGREE	FO	FACE OF	INT	INTERIOR	MTL	METAL	REF	REFERENCE		
ADJ	ADJACENT	DIM	DIMENSION	FT	FOOT/FEET			MUL	MULLION	REINF	REINFORCED	W	WIDTH
AFF	ABOVE FINISHED FLOOR	DW	DRYWALL	FTG	FOOTING	JBOX	JUNCTION BOX			REQD	REQUIRED	W/	WITH
ALT	ALTERNATE	DISP	DISPENSER			JC	JANITORS CLOSET	NFC	NOT FOR CONSTRUCTION	REV	REVISION	W/O	WITHOUT
ALW	ALLOW	DN	DOWN	GA	GAUGE	JST	JOIST	NIC	NOT IN CONTRACT	RF	ROOF	WAT	WATER
ALWB	ALLOWABLE	DR	DOOR	GALV	GALVANIZED	JNT	JOINT	NO	NUMBER	RM	ROOM		
ALUM	ALUMINUM	DSPT	DOWNSPOUT	GAR	GARAGE			NOM	NOMINAL	RO	ROUGH OPENING	WC	WATER CLOSET
ANOD	ANODIZED	DTL	DETAIL	GC	GENERAL CONTRACTOR	KIT	KITCHEN	NTS	NOT TO SCALE			WD	WOOD
ARCH	ARCHITECT	DWG	DRAWING	GFRC	GLASS FIBER REINFORCED					SAN	SANITARY	WP	WATERPROOFING
ASMB	ASSEMBLY				CONCRETE	L	LENGTH	OC	ON CENTER	SCHED	SCHEDULE	WPT	WORKING POINT
		EA	EACH	GLZ	GLAZING	LAM	LAMINATE	OD	OUTSIDE DIAMETER	SECT	SECTION	WT	WEIGHT
BLDG	BUILDING	EC	ELECTRICAL CONTRACTOR	GR	GRADE	LAV	LAVATORY	OPNG	OPENING	SF	SQUARE FOOT		
BLT-IN	BUILT-IN	EL	ELEVATION	GUT	GUTTER	LBS	POUNDS	OPP	OPPOSITE	SHT	SHEET	&, +	AND
		ELEC	ELECTRICAL	GWB	GYPSUM WALL BOARD	LF	LINEAR FEET	OPT	OPTION(AL)	SIM	SIMILAR	@	AT
CAB	CABINET	ELEV	ELEVATOR			LN	LINEAR	OZ	OUNCE	SPEC	SPECIFICATION		
CEM	CEMENT	ENCL	ENCLOSURE	H/C	HANDICAPPED	LT	LIGHT			SQ	SQUARE		
CIP	CAST IN PLACE	ENG	ENGINEER	HALG	HALOGEN			PH	PENTHOUSE	SS	STAINLESS STEEL		
CL	CENTER LINE	EQ	EQUAL	HB	HOSE BIB	MACH	MACHINE	PL	PROPERTY LINE	STD	STANDARD		
CLG	CEILING	EQUIP	EQUIPMENT	HC	HOLLOW CORE	MAS	MASONRY	PLAS	PLASTIC	STL	STEEL		
CLO	CLOSET	EST	ESTIMATE(D)	HD	HEAD	MAX	MAXIMUM	PLUM	PLUMBING	STR	STAIR		
CMU	CONCRETE MASONRY	EXH	EXHAUST	HDF	HIGH DENSITY FIBER	MC	MECHANICAL	PLY	PLYWOOD	STRUC	STRUCTURE		
	UNIT	EXP JT	EXPANSION JOINT		BOARD		CONTRACTOR	PNT	PAINT	SUP	SUPPLY		
COL	COLUMN	EXIST	EXISTING	HDWR	HARDWARE	MDF	MEDIUM DENSITY FIBER	POL	POLISHED	SUSP	SUSPENDED		
CONC	CONCRETE	EXT	EXTERIOR	HM	HOLLOW METAL		BOARD	PRTN	PARTITION	SYM	SYMMETRICAL		
CONST	CONSTRUCTION			HORZ	HORIZONTAL	MECH	MECHANICAL	PSF	POUNDS PER SQUARE	SYST	SYSTEM		
CONT	CONTINUOUS	F&I	FURNISH AND INSTALL	HR	HOUR	MEMB	MEMBRANE		FOOT				
COORD	COORDINATE	FAB	FABRICATE	HT	HEIGHT	MFTD	MANUFACTURED	PT	PRESSURE TREATED	UL	UNDERWRITERS		
CORR	CORRIDOR	FB0	FURNISH BY OWNER	HVAC	HEATING, VENTILATION &	MFTR	MANUFACTURER	PTD	PAINTED		LABORATORY		
CPT	CARPET	FLDR	FLOOR DRAIN		AIR CONDITIONING	MH	MANHOLE			UON	UNLESS OTHERWISE		
CTR	CENTER	FIN	FINISH(ED)	HW	HOT WATER	MIN	MINIMUM	QUAL	QUALITY		NOTED		

MIRROR

MIR

QTY

QUANTITY



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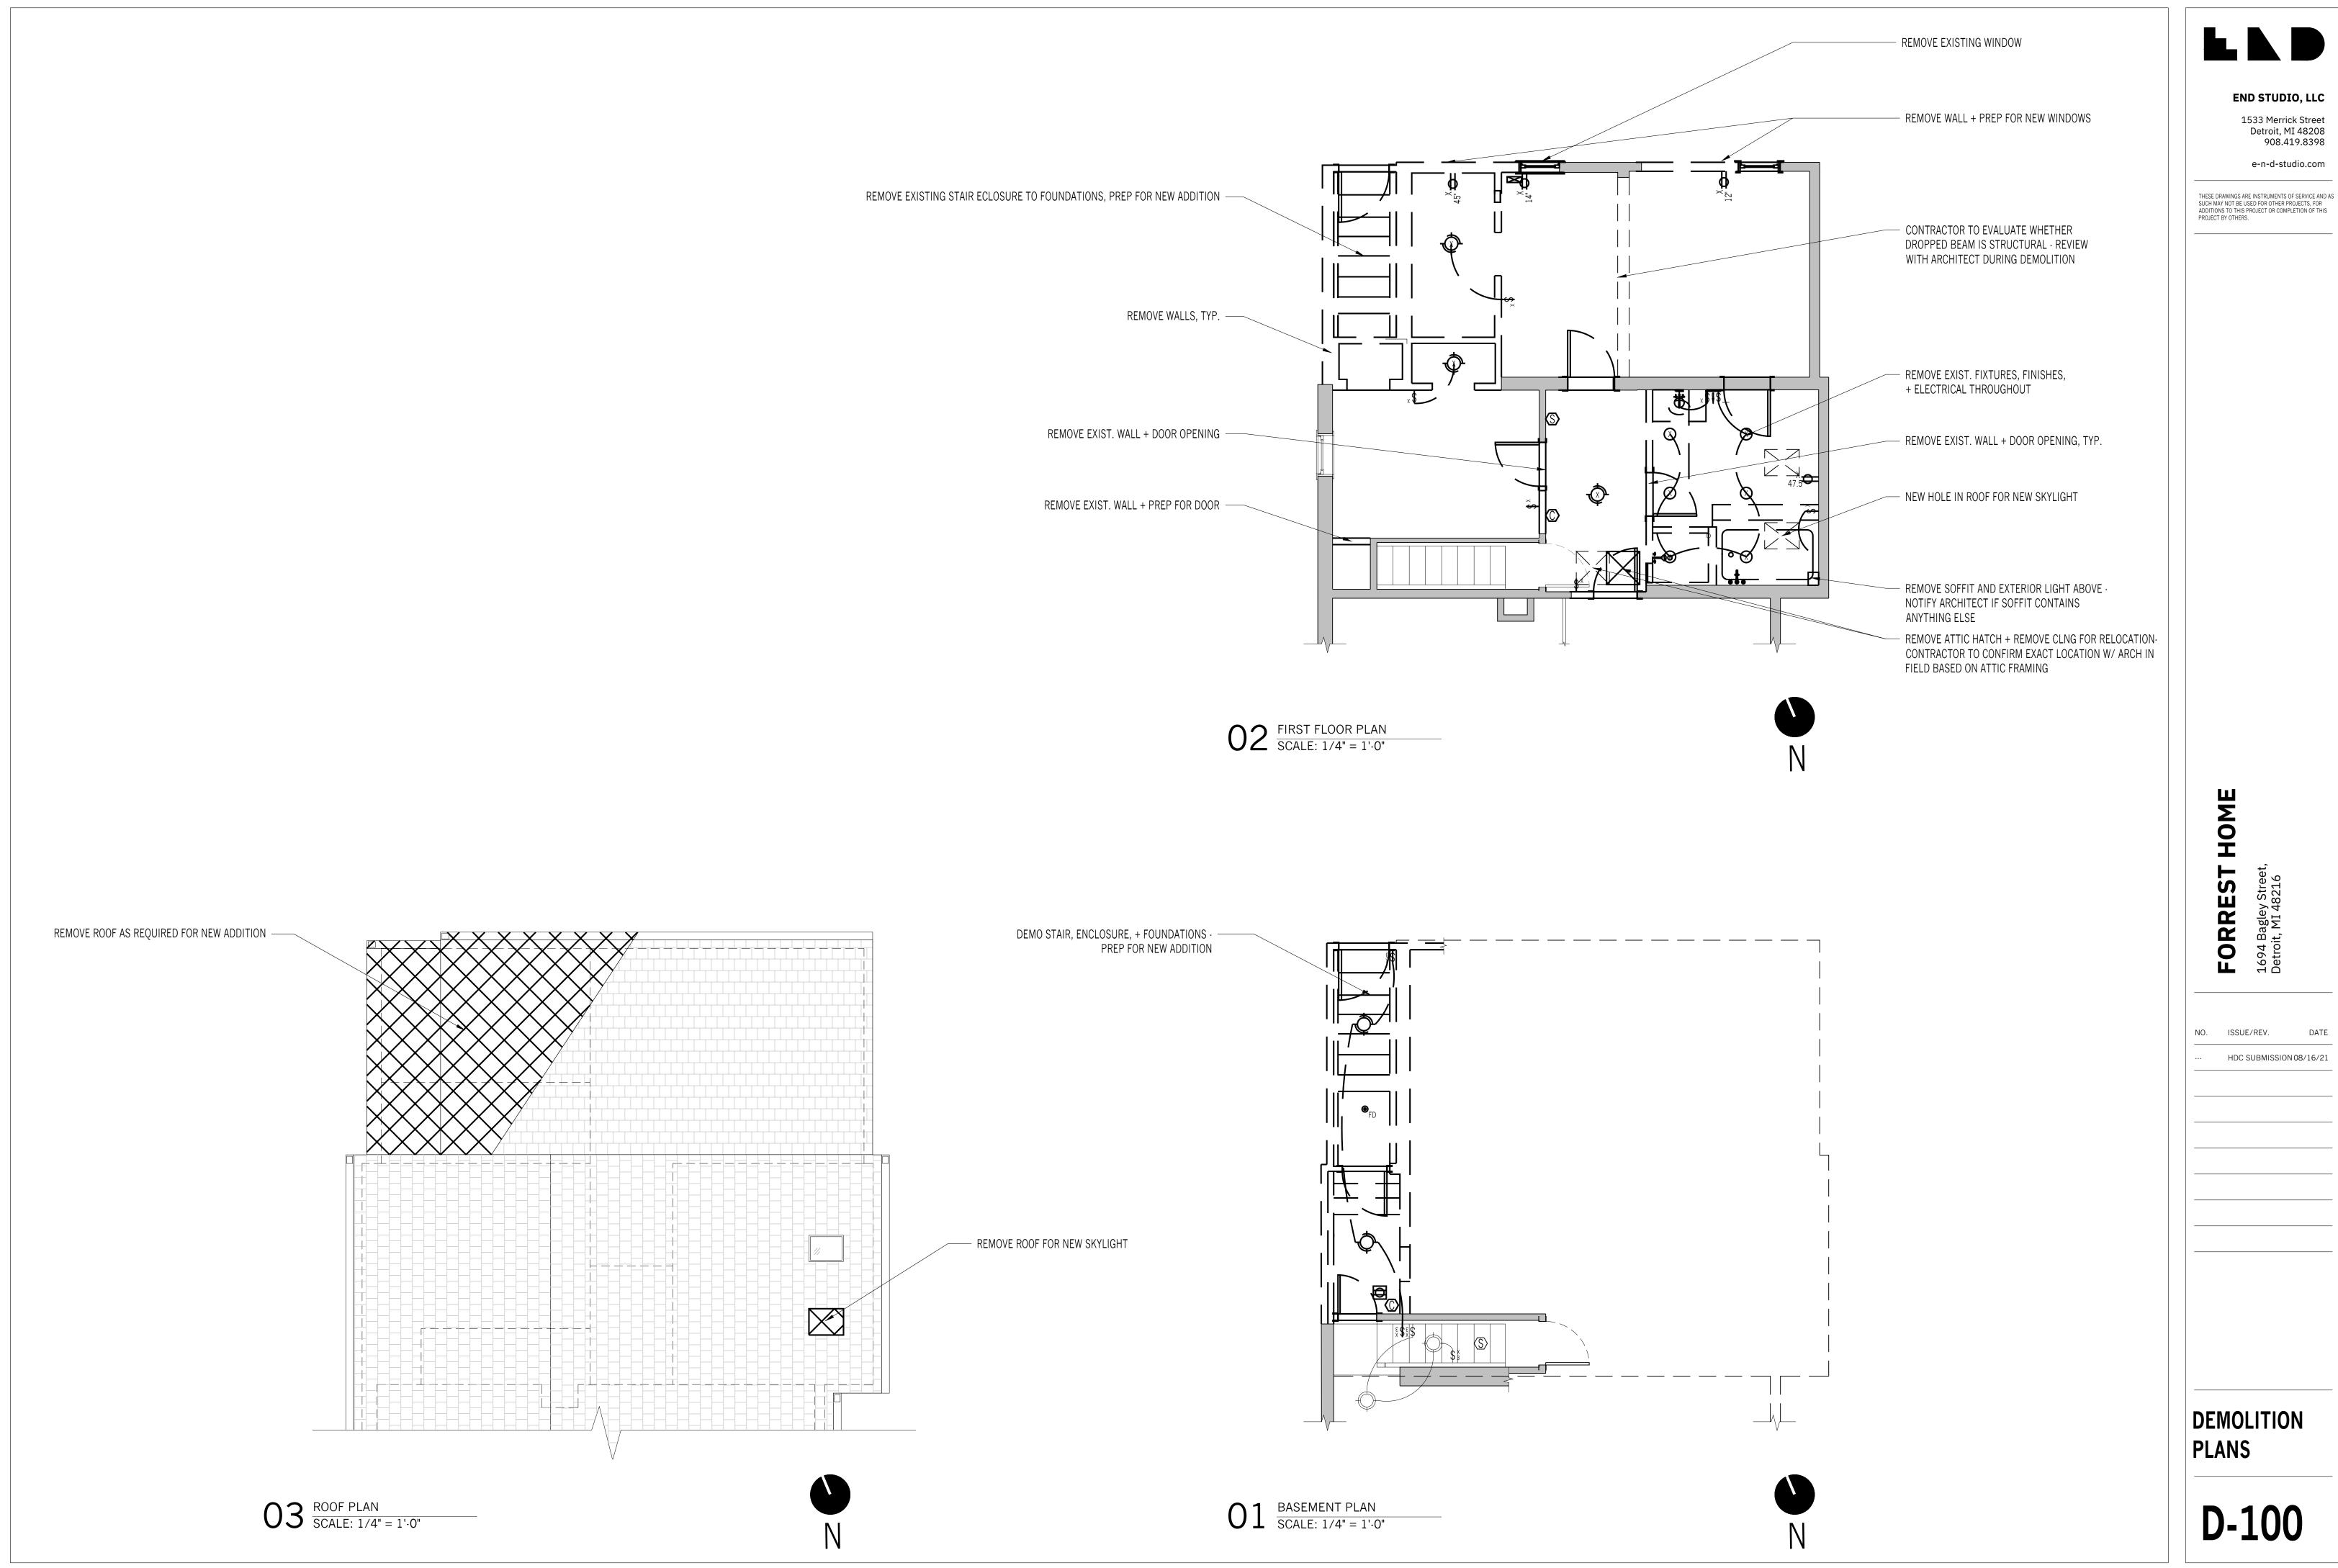
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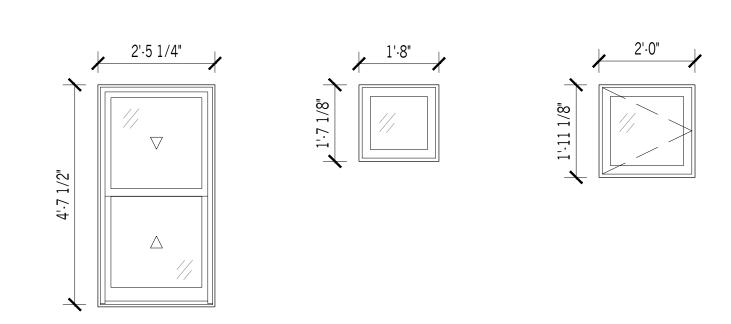
GENERAL NOTES

G-001




VINDOW SCHEDULE									
				SIZE		FINISH			NOTES
#	MANUFACTURER	MODEL/STYLE	w	н	H TYPE	INT	EXT	GLAZ	
WINDOWS									
W-01 MARVIN		ULTIMATE DOUBLE HUNG G2	2'-5 1/4"	X 4'-7 1/2"	А	BLACK	BLACK	DBL IGU LOW E W/ ARGON	
W-02 MARVIN		ULTIMATE DOUBLE HUNG G2	2'-5 1/4"	X 4'-7 1/2"	А	BLACK	BLACK	DBL IGU LOW E W/ ARGON	
W-03 MARVIN		ULTIMATE DOUBLE HUNG G2	2'-5 1/4"	X 4'-7 1/2"	А	BLACK	BLACK	DBL IGU LOW E W/ ARGON	
W-04 MARVIN		ULTIMATE CASEMENT	1'-8"	X 1'-7 1/8"	В	BLACK	BLACK	DBL IGU LOW E W/ ARGON	
W-05 MARVIN		ULTIMATE CASEMENT PUSH OUT	2'-0"	X 1'-11 1/8"	С	BLACK	BLACK	DBL IGU LOW E W/ ARGON	
W-06 MARVIN		ULTIMATE CASEMENT PUSH OUT	2'-0"	X 1'-11 1/8"	С	BLACK	BLACK	DBL IGU LOW E W/ ARGON	
W-07 MARVIN		ULTIMATE CASEMENT PUSH OUT	2'-0"	X 1'-11 1/8"	С	BLACK	BLACK	DBL IGU LOW E W/ ARGON	
W-08 VELUX		FS C01 FIXED SKYLIGHT	21-1/2"	X 27 3/8"	D	BLACK	BLACK	DBL IGU LOW E W/ ARGON	

DOOR SCH	IEDULE								
	MANUFACTURER	MODEL/STYLE	SIZE			FINISH		NOTES	
#			W H	TYPE	INT	EXT	GLAZ		
EXTERIOR	EXTERIOR DOORS								
D-01		ULTIMATE INSWING FRENCH DOUBLE DOOR W/ TALL BOTTOM RAIL + TWO SIDELIGHTS	8'-4 1/2" X 6-10"	A	BLACK	BLACK	DBL IGU LOW E W/ ARGON		



 $01_{\frac{\text{WINDOW TYPE A}}{\text{SCALE: }1/2"=1'-0"}} 02_{\frac{\text{WINDOW TYPE B}}{\text{SCALE: }1/2"=1'-0"}} 03_{\frac{\text{WINDOW TYPE C}}{\text{SCALE: }1/2"=1'-0"}}$

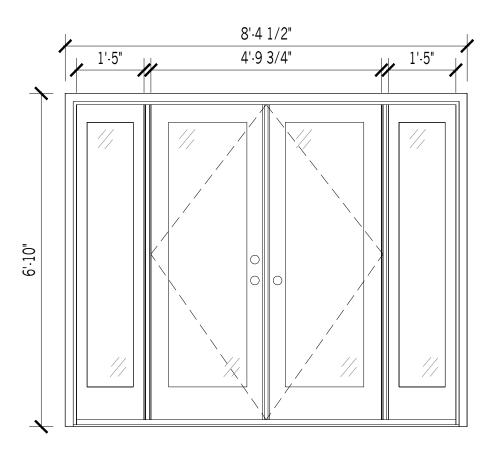

 $01 \frac{\text{DOOR TYPE A}}{\text{SCALE: } 1/2" = 1' \cdot 0"}$

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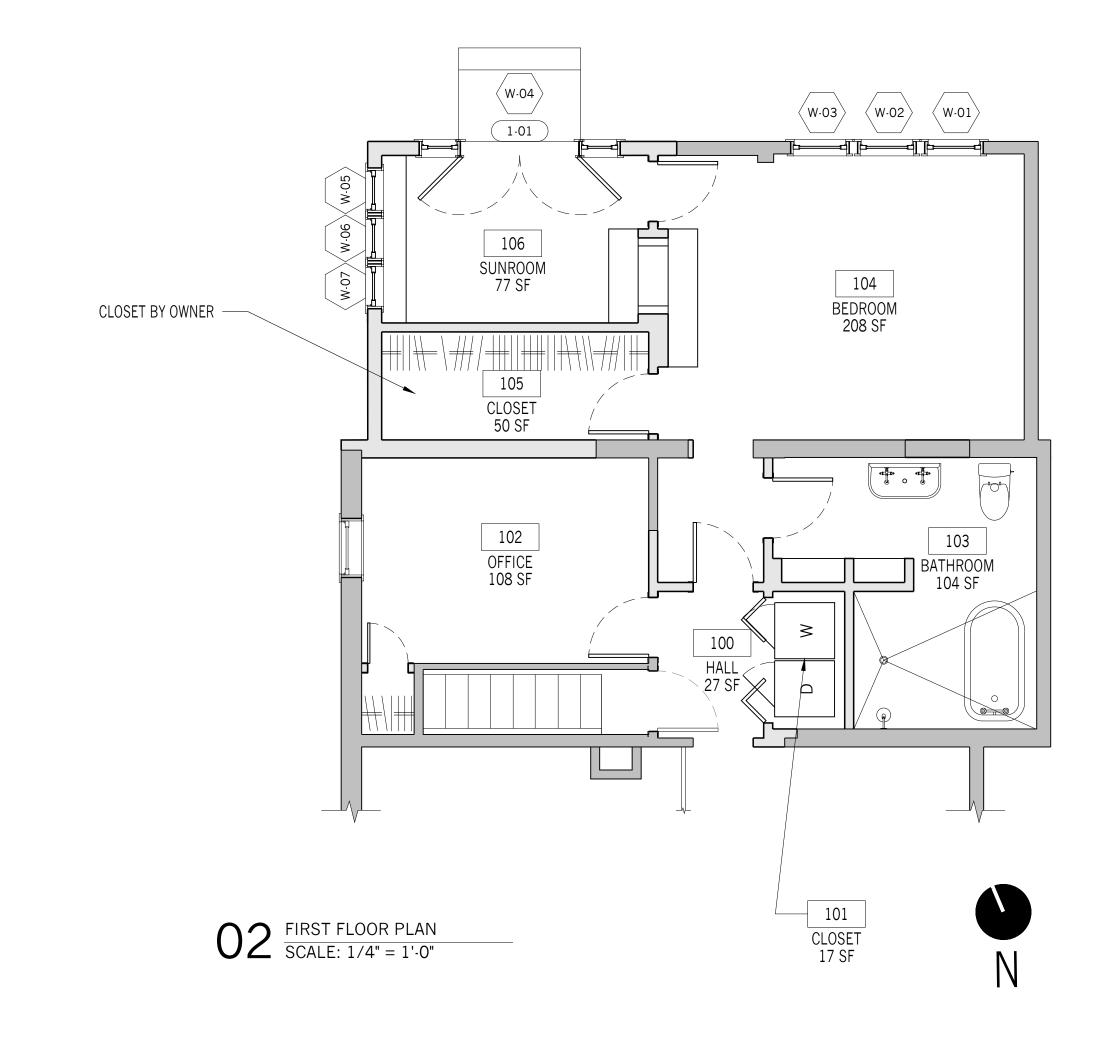
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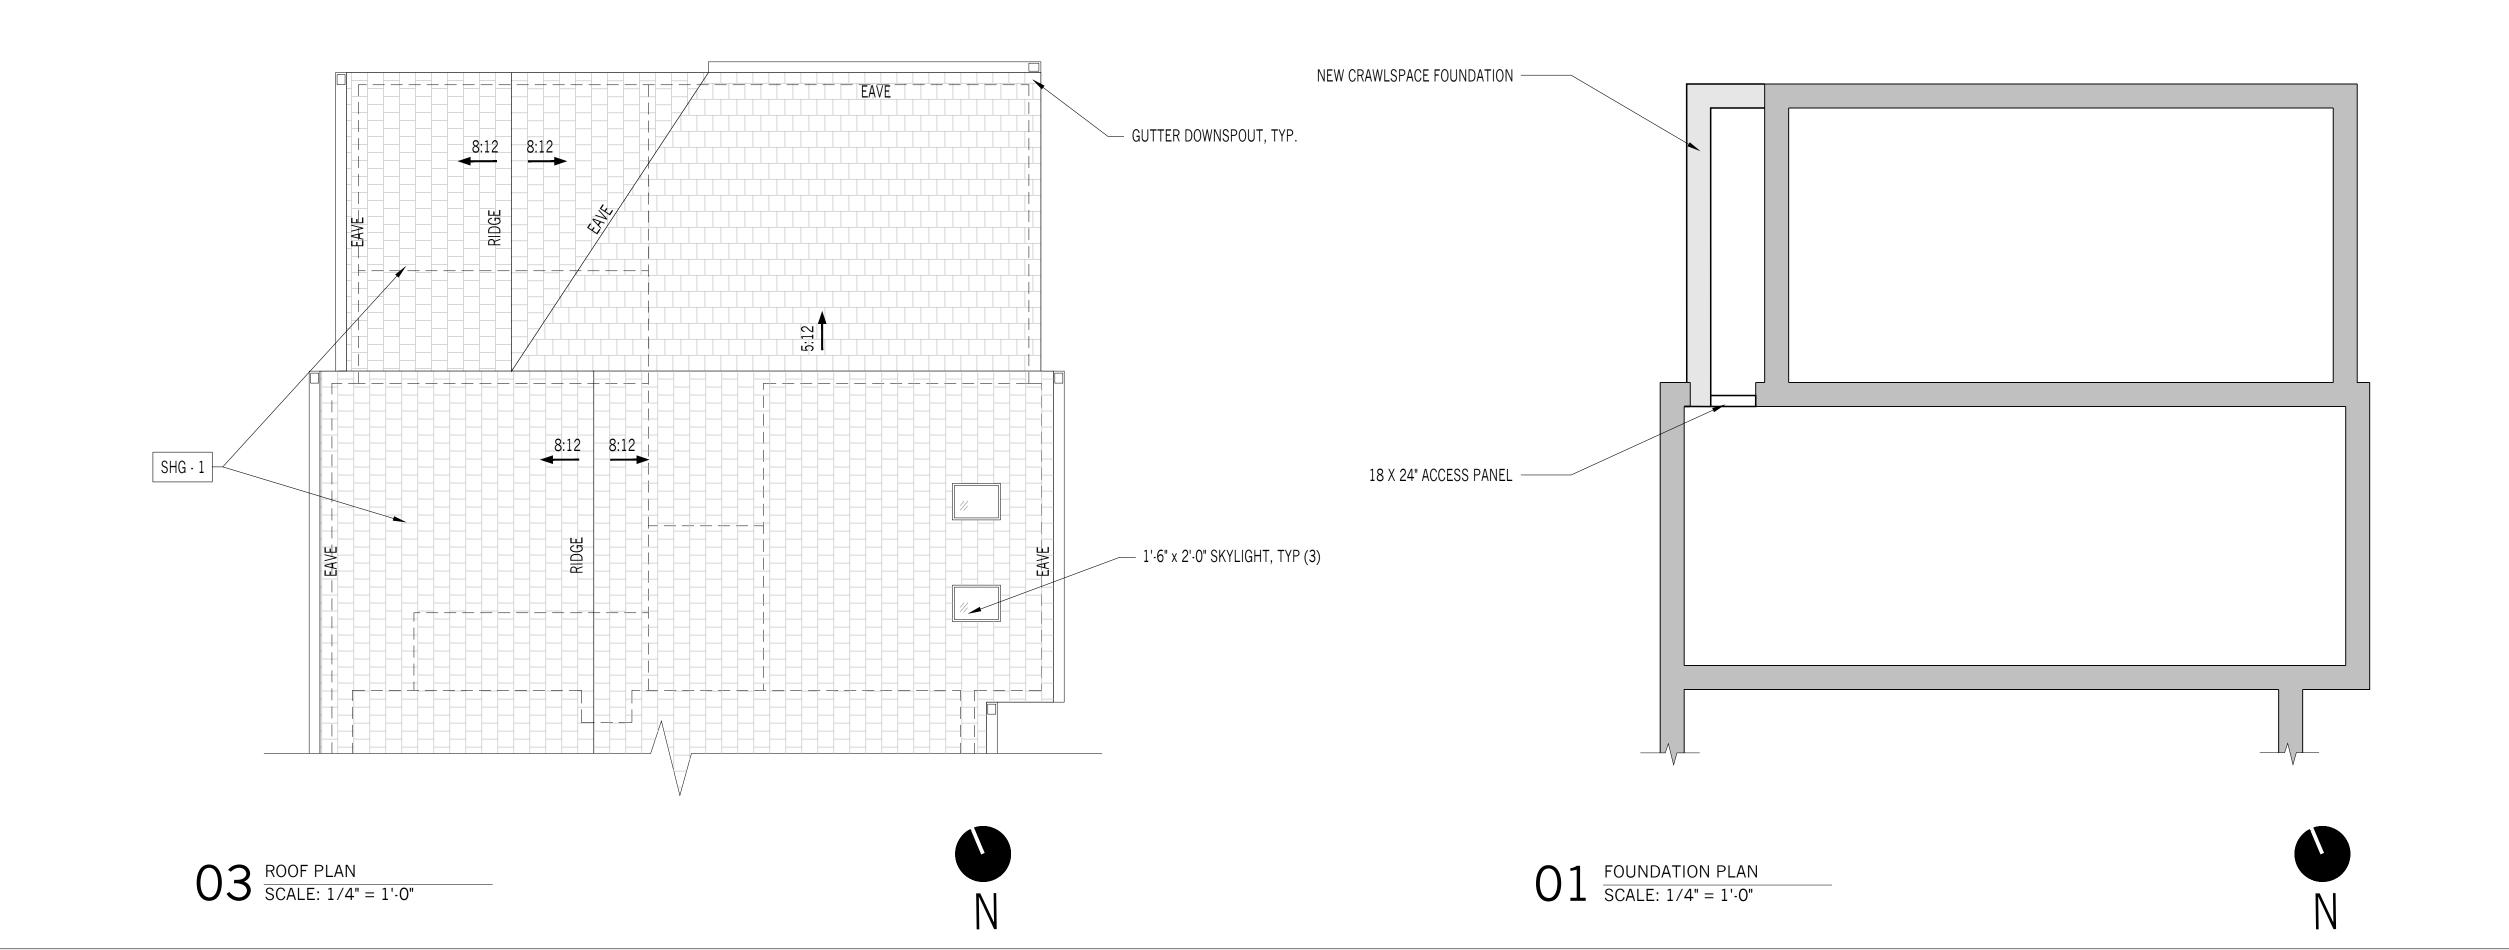
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SCHEDULES

A-000





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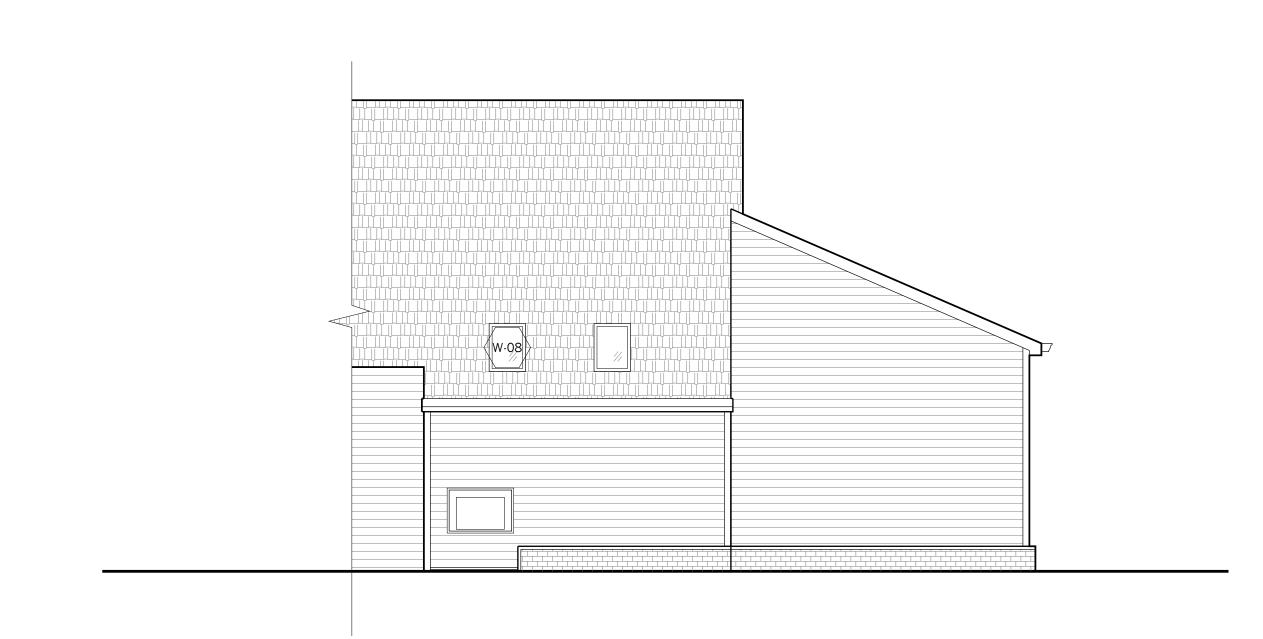
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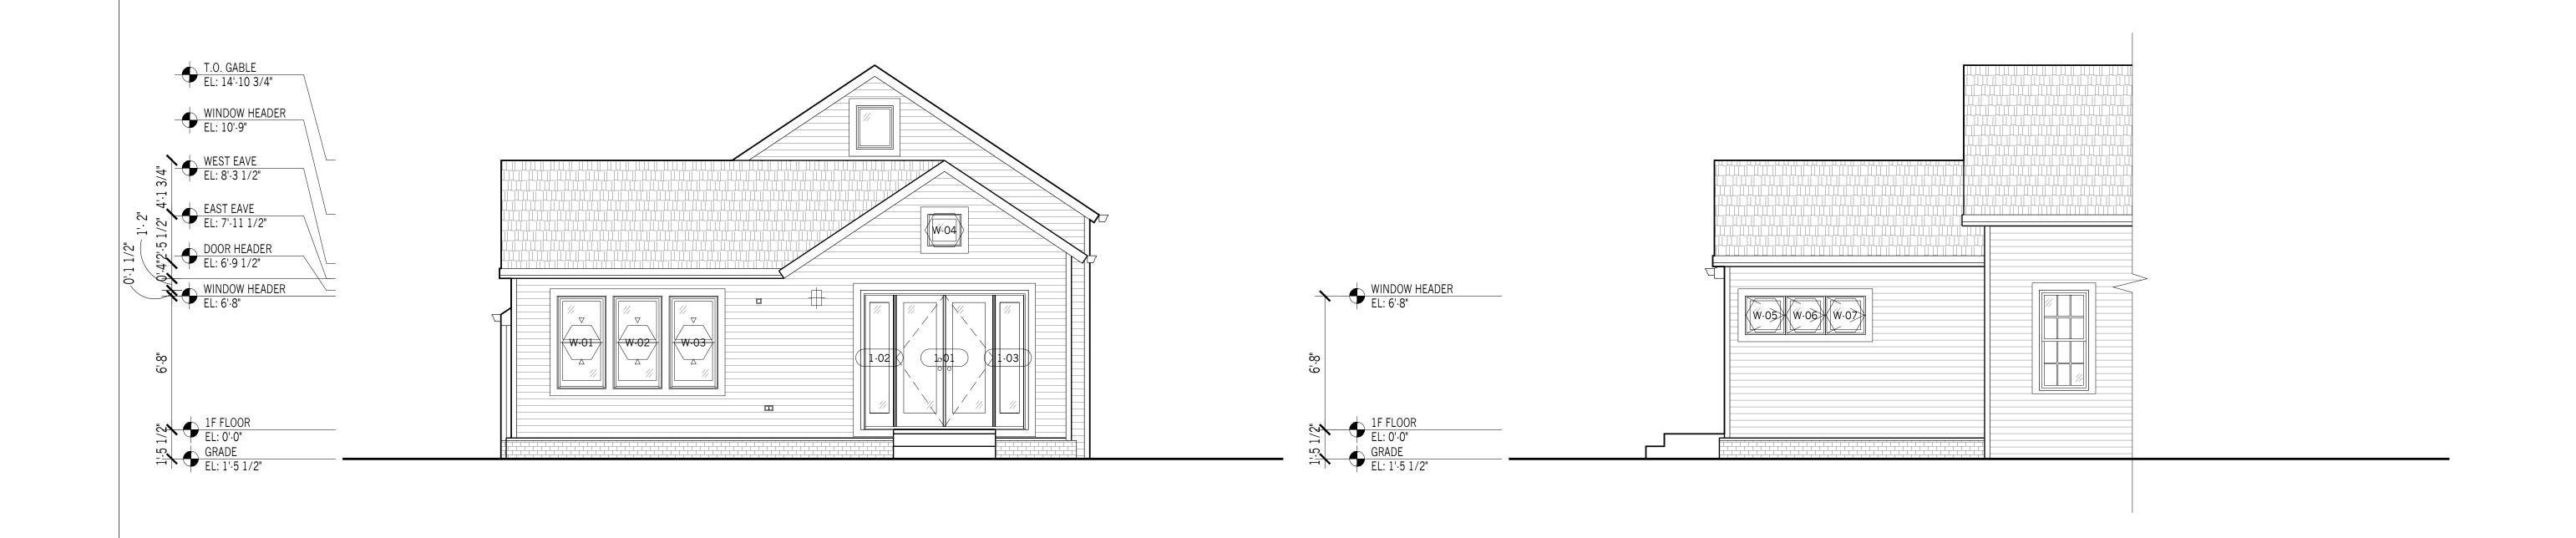
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FLOOR, ROOF & FOUNDATION PLANS

A-101



 $03 \frac{\text{WEST ELEVATION}}{\text{SCALE: } 1/4" = 1' \cdot 0"}$



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EXTERIOR ELEVATIONS

A-300