THE RECTORY

1920 ATKINSON ST. Detroit, Michigan 48206

Owner:

Amy Peterson, Antonio Luck, Betsy Murdoch

Architect:

Iannuzzi Studio PLLC 1410 Service St. Suite 202 Detroit, MI 48207

Contact: David Jannuzzi, AJA T: 313.920.5688 di@iannuzzistudio.com

General Contractor: T.B.D.

Structural Engineer:

Mechanical Engineer:

M A Engineering 400 S. Old Woodward Ave., Suite 100 Birmingham, MI 48009

T: 248.258.1610

General Requirements

Provide all labor, materials, equipment, and services and provide all operations required to accomplish the work as indicated and/or implied by the drawings and these general notes and specifications.

0141 CODES AND ORDINANCES

All construction to comply with all applicable codes, ordinances, safety orders and regulations including building, Americans with Disabilities Act ADA, OSHA, plumbing, mechanical, and electrical codes, ordinances and requirements.

Plans, notes, and specifications are done to the reference code listed as of the date originally prepared. Any use in other jurisdictions will require these documents to be reviewed and/or modified by a local design professional licensed to practice in that jurisdiction.

PERMITS AND TESTS

Obtain and pay for all required permits, inspections, and tests. All re-inspection fees for work not ready or in compliance with local codes to be paid for by Contractor.

All Contractors shall carry broad form, comprehensive liability insurance (minimum \$1,000,000 liability) and workmen's compensation insurance and shall submit certificates of insurance to the Owner prior to execution of any work. All Contractors shall name lannuzzi Studio PLLC, Nepelu LLC, and financing organizations as additional insured on all insurance policies.

COORDINATION WITH OTHER TRADES

Coordinate all work before and during construction with all other affected trades. Where interferences develop notify architect. Relocation of conflicting installed work due to lack of coordination or poor coordination will not be considered extra work.

WORKMANSHIP

All work executed shall be performed in a first class and safe, workmanlike manner in accordance with the latest accepted standards and practice for the work involved. The workmanship shall be subject to the approval of the

SCHEDULE

Within 7 days after date of Agreement, submit preliminary schedule defining planned operations for the first 60 days of Work, with a general outline for remainder of Work. Within 7 days after date of joint review, submit complete schedule. If preliminary schedule requires revision after review, submit revised schedule within 7 days. Show complete sequence of construction by activity, with dates for beginning and completion of each element of

EXAMINATION OF EXISTING CONDITIONS

Before submitting proposals for the work, the Contractor shall be held to have examined the site and satisfied as to the existing conditions under which it will be obliged to operate in performance of the work. Contractor shall inform the Owner of any probable contingencies, which may influence the execution of the work with their bid. No extras will be allowed to the Contractor because of their failure to make this specified examination or neglect to include all materials and labor required in their work. Contractor to notify Architect of any hidden conditions for which an extra time or money is going to be requested prior to proceeding with the work. Failure to notify may result in denial of the extra expense.

APPROVED MANUFACTURERS

Use only materials specifically indicated in contract documents, or comparable materials by other listed acceptable or Architect-approved manufacturers. Note that "acceptable manufacturer" does not construe automatic approval of specific materials by one or all of the listed acceptable manufacturers. Architect reserves the right of final determination of acceptability of each item

SUBMISSION OF SHOP DRAWINGS AND CUT SHEETS

Submit complete shop drawings and/or manufacturer's cut-sheets for all materials, fabrication, and equipment intended for use on this project. Shop drawings shall clearly indicate all physical and performance characteristics for all materials and equipment. Submit electronic copies of all shop drawings for review by architect. No work is to be installed prior to review and return of architect-approved shop drawings.

APPROVAL OF SHOP DRAWINGS

Architect's review/approval of shop drawings is for adherence to design concept only. General and sub-contractors, suppliers, and fabricators to field verify all dimensions and site conditions for compliance with shop drawing requirements prior to release for fabrication. Architect to be given 10 days minimum to review all required shop drawings and/or selections.

DIMENSIONS

Review and verify all dimensions on the drawings before commencing with the work. If dimensional errors occur, the Contractor shall notify the Architect before proceeding with the work. DO NOT SCALE DRAWINGS. Any Contractor that scales a drawing to determine a location for any part of the work shall take full responsibility, should that portion of the work be improperly located.

ERRORS AND OMISSIONS

Any errors, omissions, or conflicts between various elements on the drawings and/or in these general notes shall be brought to the attention of the Architect before proceeding with the work. Failure to do so shall result in the Contractor taking full responsibility and liability for the work as installed.

Applicable Codes

All construction to comply with all applicable codes including local building, plumbing, mechanical, and electrical codes, ordinances and requirements.

2015 MICHIGAN REHABILITATION CODE FOR EXISTING BUILDINGS

- ALTERATION LEVEL III 2015 MICHIGAN MECHANICAL CODE
- 2015 MICHIGAN ELECTRICAL CODE 2015 MICHIGAN PLUMBING CODE
- 2015 UNIFORM ENERGY CODE

LEGAL DESCRIPTION

PROPERTY EXEMPT FROM AD VALOREM TAXES AND ASSESSED ON THE SPECIAL ACT ROLL PURSUANT TO PA261 OF 2003 EXPIRING 12/30/2024. N ATKINSON 680 JOY ARM SUB L32 P40 PLATS, WCR⁸/₁₂₈ 40 X 133.5 PARCEL ID: 08002810

ZONING CLASSIFICATION SD-1

BUILDING AREA

Basement	926 sq.ft.
First Floor	926 sq.ft
Second Floor	909 sq. ft.
Third Floor	467 sq.ft.
Gross Square Fo	ootage 3,228sq. ft.

CONSTRUCTION TYPE

FIRE RESISTANCE RATING (MBC TABLE 601)

Primary Structural Frame	0	Wood Framing
Bearing walls		
Interior	0	Wood Framing
Exterior	2	Brick Masonry
Nonbearing		·
Interior	0	Wood Framing
Exterior	0	Brick Masonry
Floor/Roof	0	Wood Framing

OCCUPANCY AND USE Use classification

cation	A-2	Assembly
	R-2	Residential
	R-2	

OCCUPANT LOAD FACTOR(TA	BLE NO. 1004.1.2 - MBC 2015)	
Type	Area/Occupancy	Total
FIRST FLOOR		
Interior Destarrant	-f / 1 T /	

intendi Nestaurant	31 / 10/ 000	occupant
Kitchen/Bar	sf /200/occ	occupant
Storage	sf /300/occ	occupants
Business	sf/100/occ	occupants
SECOND FLOOR		
Residential	sf/200/occ	occupant
THIRD FLOOR		
Residential	sf/200/occ	occupant

BUILDING TOTAL OCCUPANTS FIRE SUPPRESSION REQUIREMENTS

Required for use over 100 occupants - OK

Required for use over 5,000 sq. ft. - OK

Required for use with fire area on a floor other than the level of exit discharge serving such

Width

9.2"

MEANS OF EGRESS AND EXIT ACCESS Egress Capacity 0.2" (door) 46 persons

Exits Required 1st floor 2 for occ < 501 persons Max Egress Travel Distance 200' for use - OK (TABLE NO. 1017.2 - MBC)

REQUIRED PLUMBING FACILITIES/TABLE NO. 403.1 - MPC 2015)

QUIRED PLUMB	ING FAUILITIES (TABLE NO. 403. 1 -	MPC 2015)
	Required:	Provided:
ater Closet:	1 per 75F, 1/75M Occ. (2)	Single Occ.
vatory:	1/200 Occ. (2)	Total
inking Ftn:	1	0 Drinking Fountain
rvice Sink:	1	Service Sink

410.4 Substitution

Where restaurants provide drinking water in a container free of charge, drinking fountains shall not be required in those restaurants. In other occupancies where drinking fountains are required, water dispensers shall be permitted to be substituted for not more than 50 percent of the required number of drinking fountains. -OK

Scope of Work / General Notes:

RENOVATION OF EXISTING BUILDING, FIRST FLOOR RESTAURANT, SECOND AND THIRD FLOOR DWELLING.

ISSU ISSU	JED SHEET JED FOR REFERENCE ONLY TINCLUDED / NOT ISSUED	HDC Set			
		04-12-2021			
A0.0	COVER SHEET	•			
A0.1	ARCHITECTURAL SITE PLAN	•			
A0.2	LIFE SAFETY PLAN				
ARCHI	ITECTURAL				
D1.0	DEMO PLANS	•			
D2.0	DEMO ELEVATIONS	•			
A1.0	FLOOR PLANS	•			
A1.1	REFLECTED CEILING PLANS				
A2.0	EXTERIOR ELEVATIONS	•			
A2.1	EXTERIOR ELEVATIONS	•			
A3.0	BUILDING SECTION				
A3.1	WALL SECTIONS				
A4.0	INTERIOR ELEVATIONS				
A7.0	SCHEDULES	•			

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T: 313.625.9500


PROJECT:

Detroit, MI 48206

Site Location Map

SHEET TITLE:

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PROJECT:

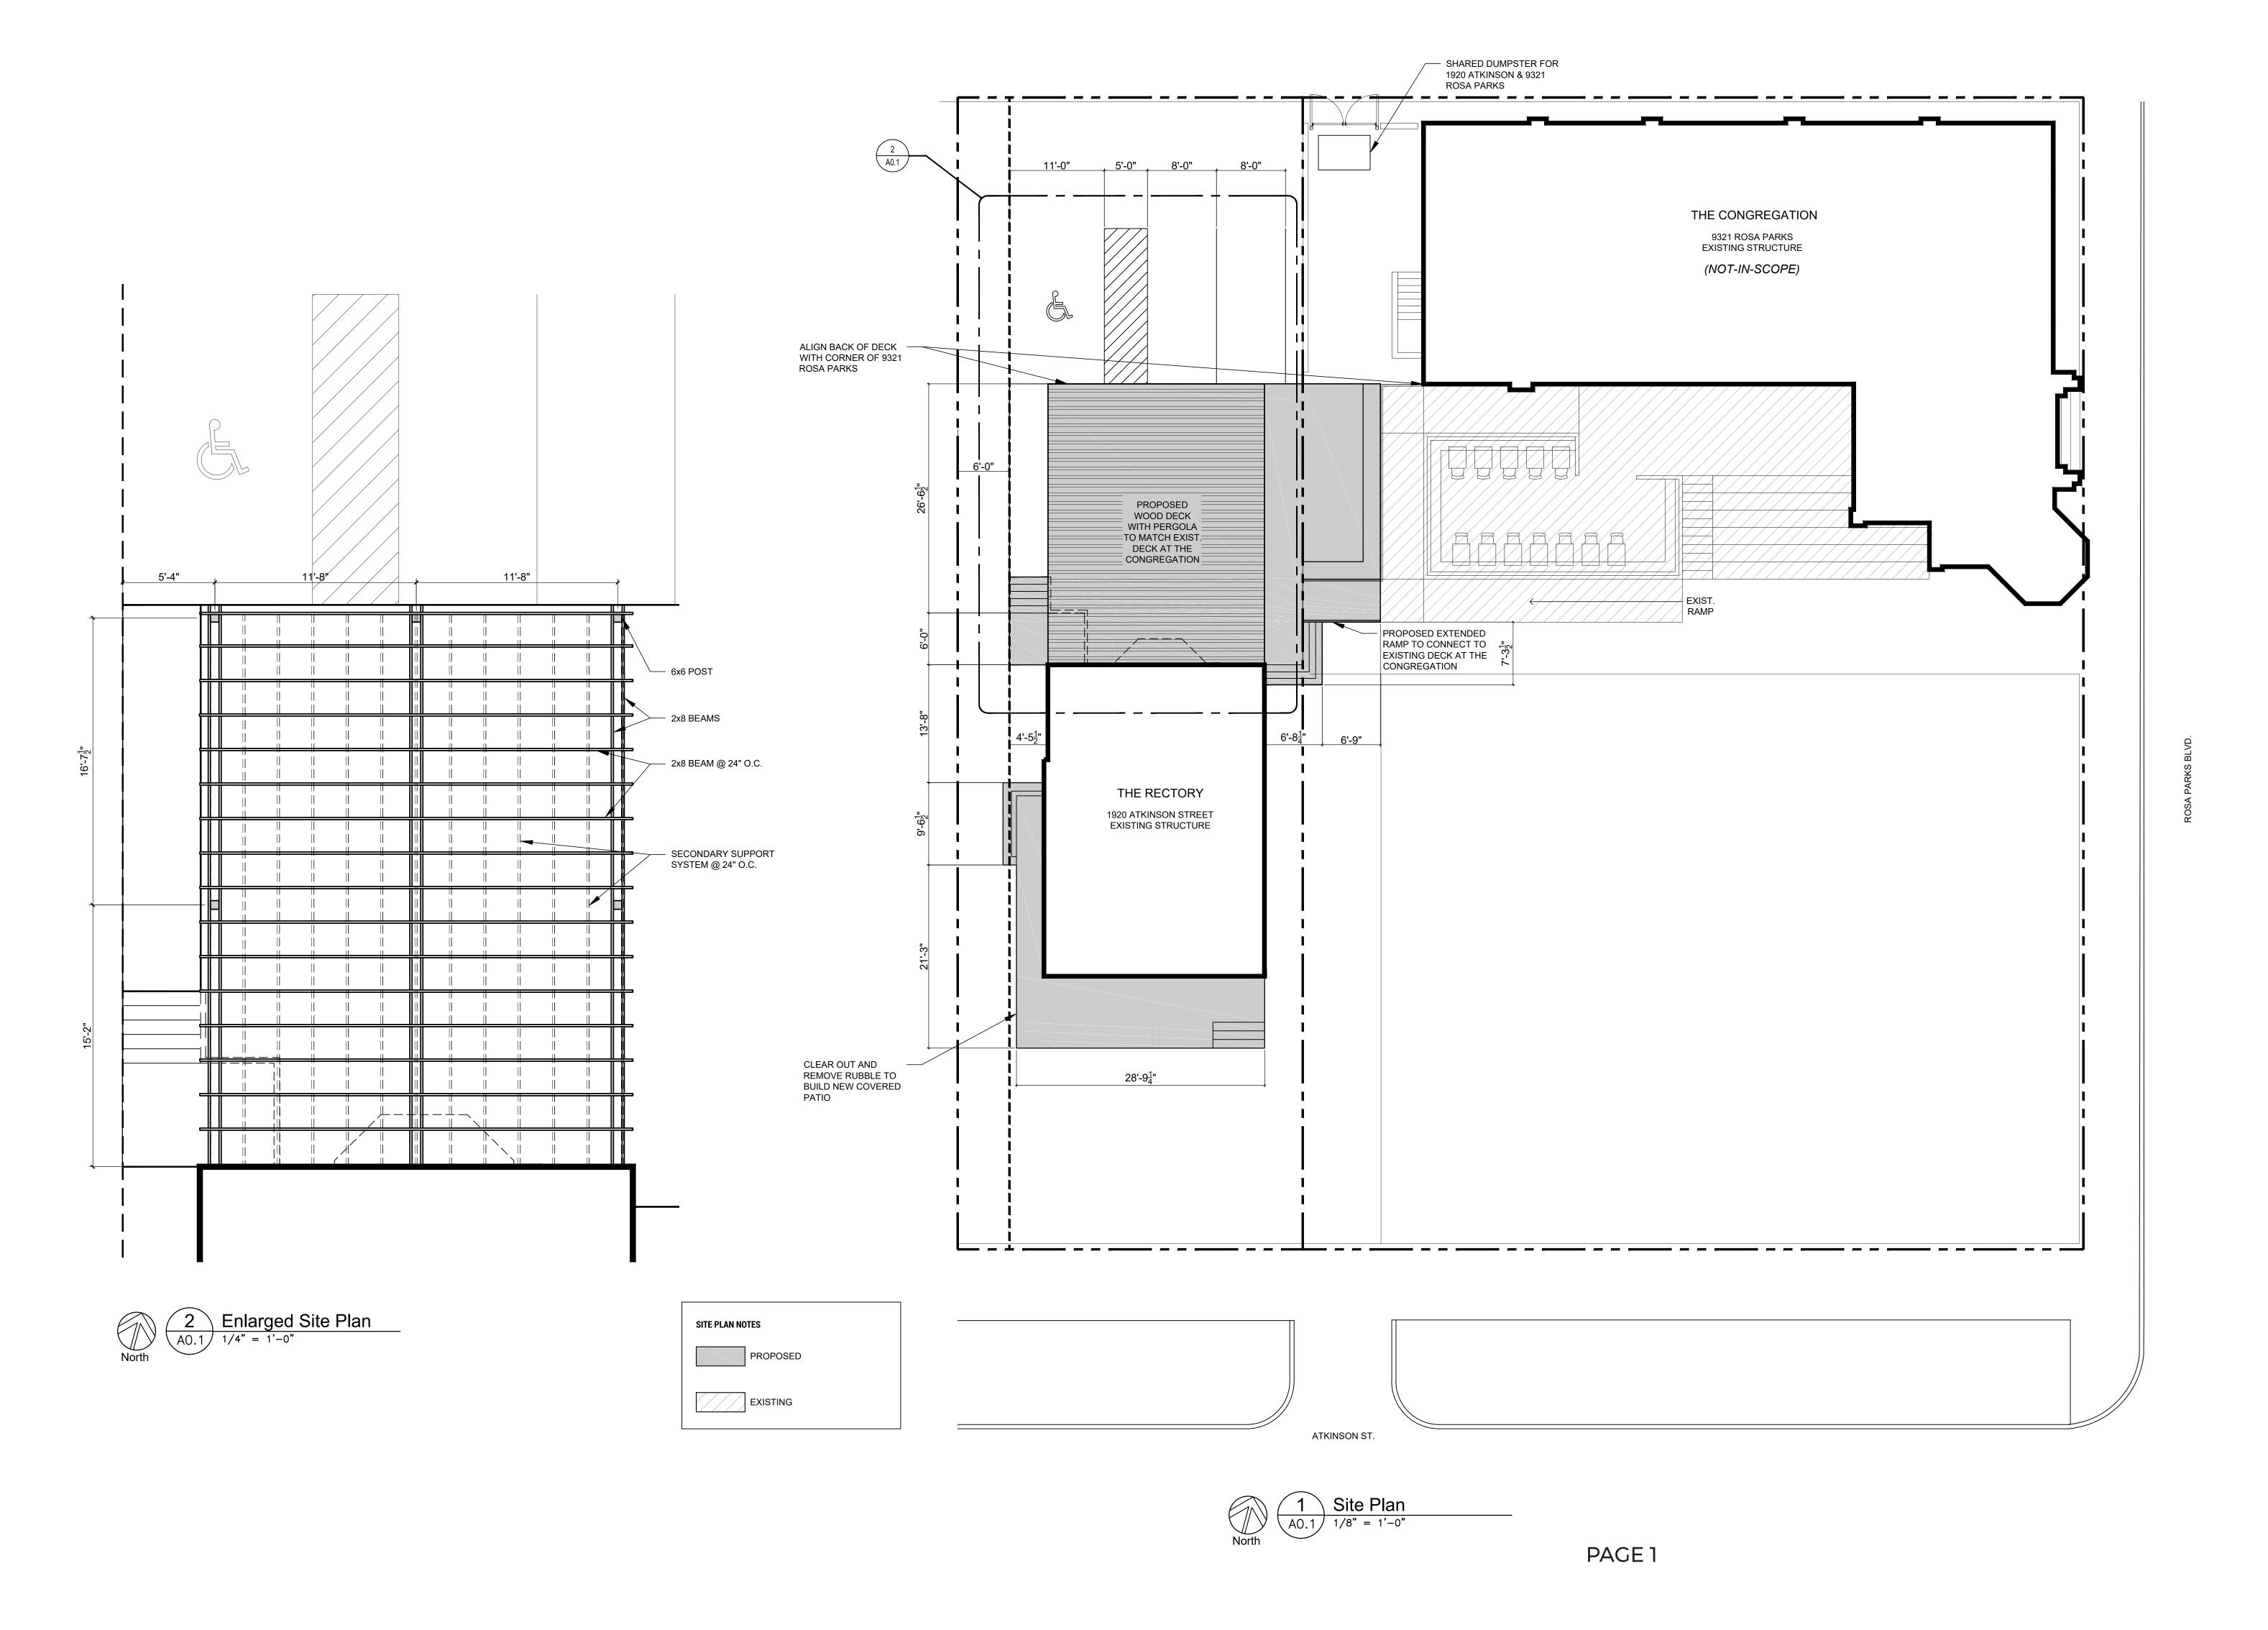The Rectory 1920 Atkinson St. Detroit, MI 48206

SHEET NUMBER:

AO.1

SHEET TITLE:
ARCHITECTURAL
SITE PLAN
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DEMOLITION WALL KEY

Z/Z/Z/Z/Z EXISTING WALL TO BE DEMOLISHED

EXISTING WALL TO REMAIN

ARCHITECTURE KEY NOTES

D100

D101 REMOVE EXISTING INTERIOR WALLS, TYP.

D102 REMOVE STAIRS AND LANDING AND PREP FOR NEW WORK.
REMOVE FLOORING AND PREP FOR NEW WORK

D103


D104


D105 REMOVE EXISTING MASONRY WALL AND PREPARE FOR NEW


D106

GENERAL NOTES


1.: ALL WINDOWS, BRICK MODELS, AND WINDOW SILLS WILL BE RESTORED OR REBUILT TO MATCH CURRENT. COLOR IS TO BE B:18 DARK REDDISH BROWN WITH A:8 BLACKISH GREEN FOR THE TRIM PER HDC'S DESIGN GUIDELINES

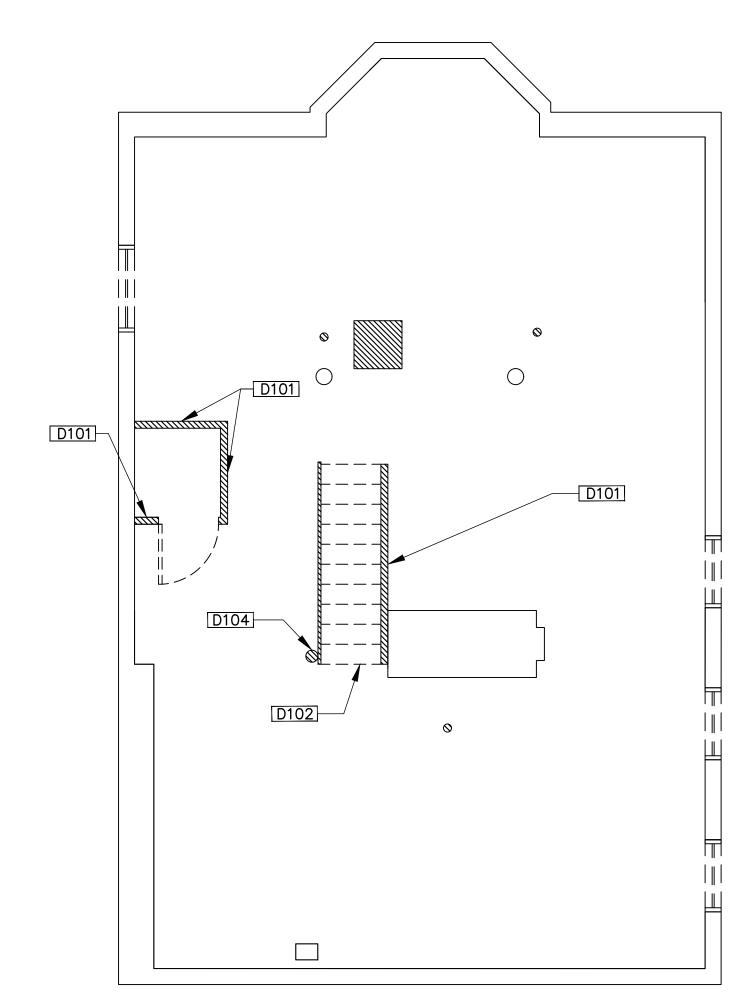


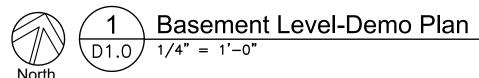


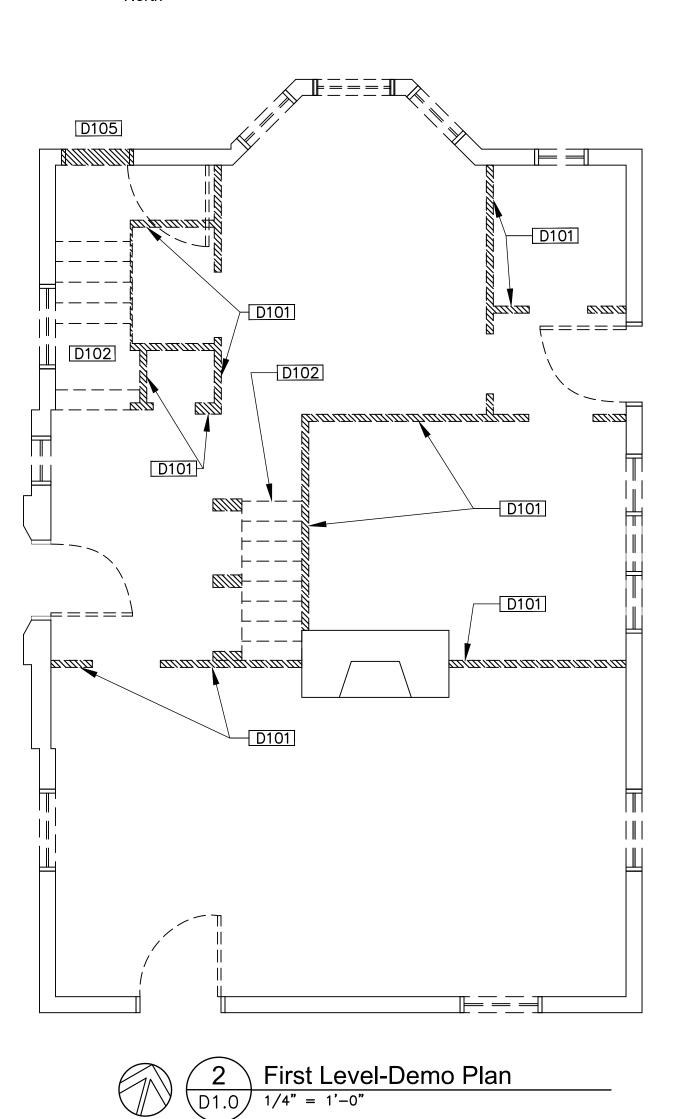



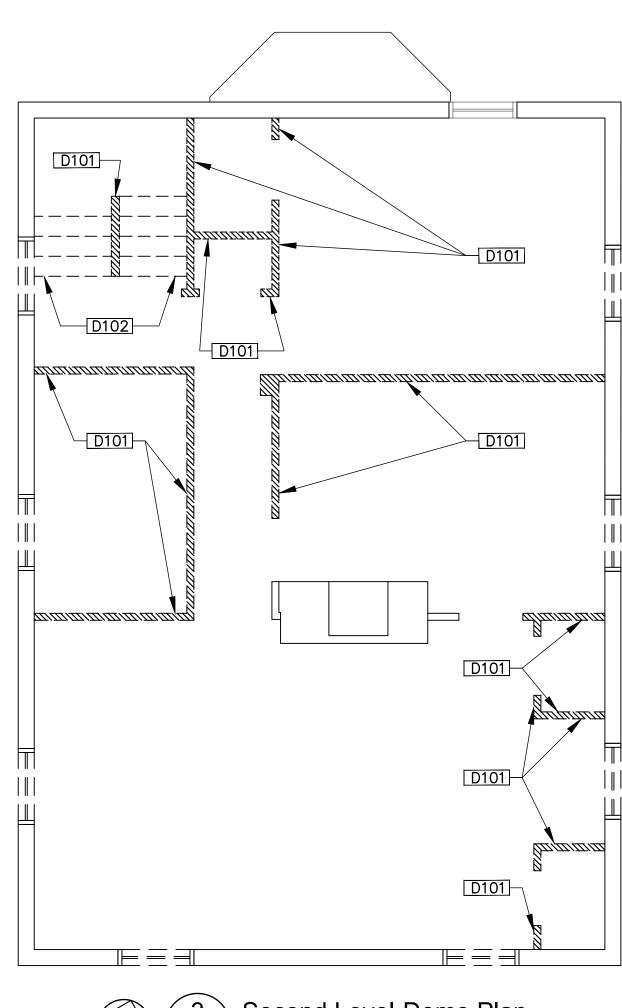

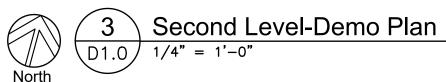

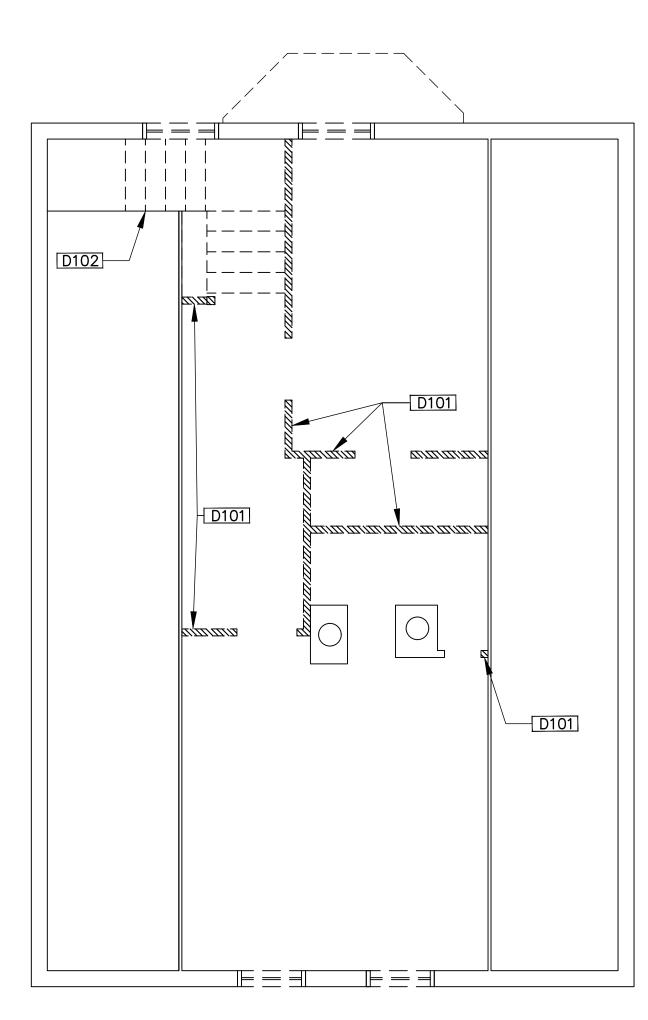



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PROJECT:


The Rectory 1920 Atkinson St. Detroit, MI 48206

DATE:	ISSUED FOR:			
04 - 12 - 2021	HDC Set			

SHEET NUMBER:

SHEET TITLE:
DEMO PLANS

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WALL KEY

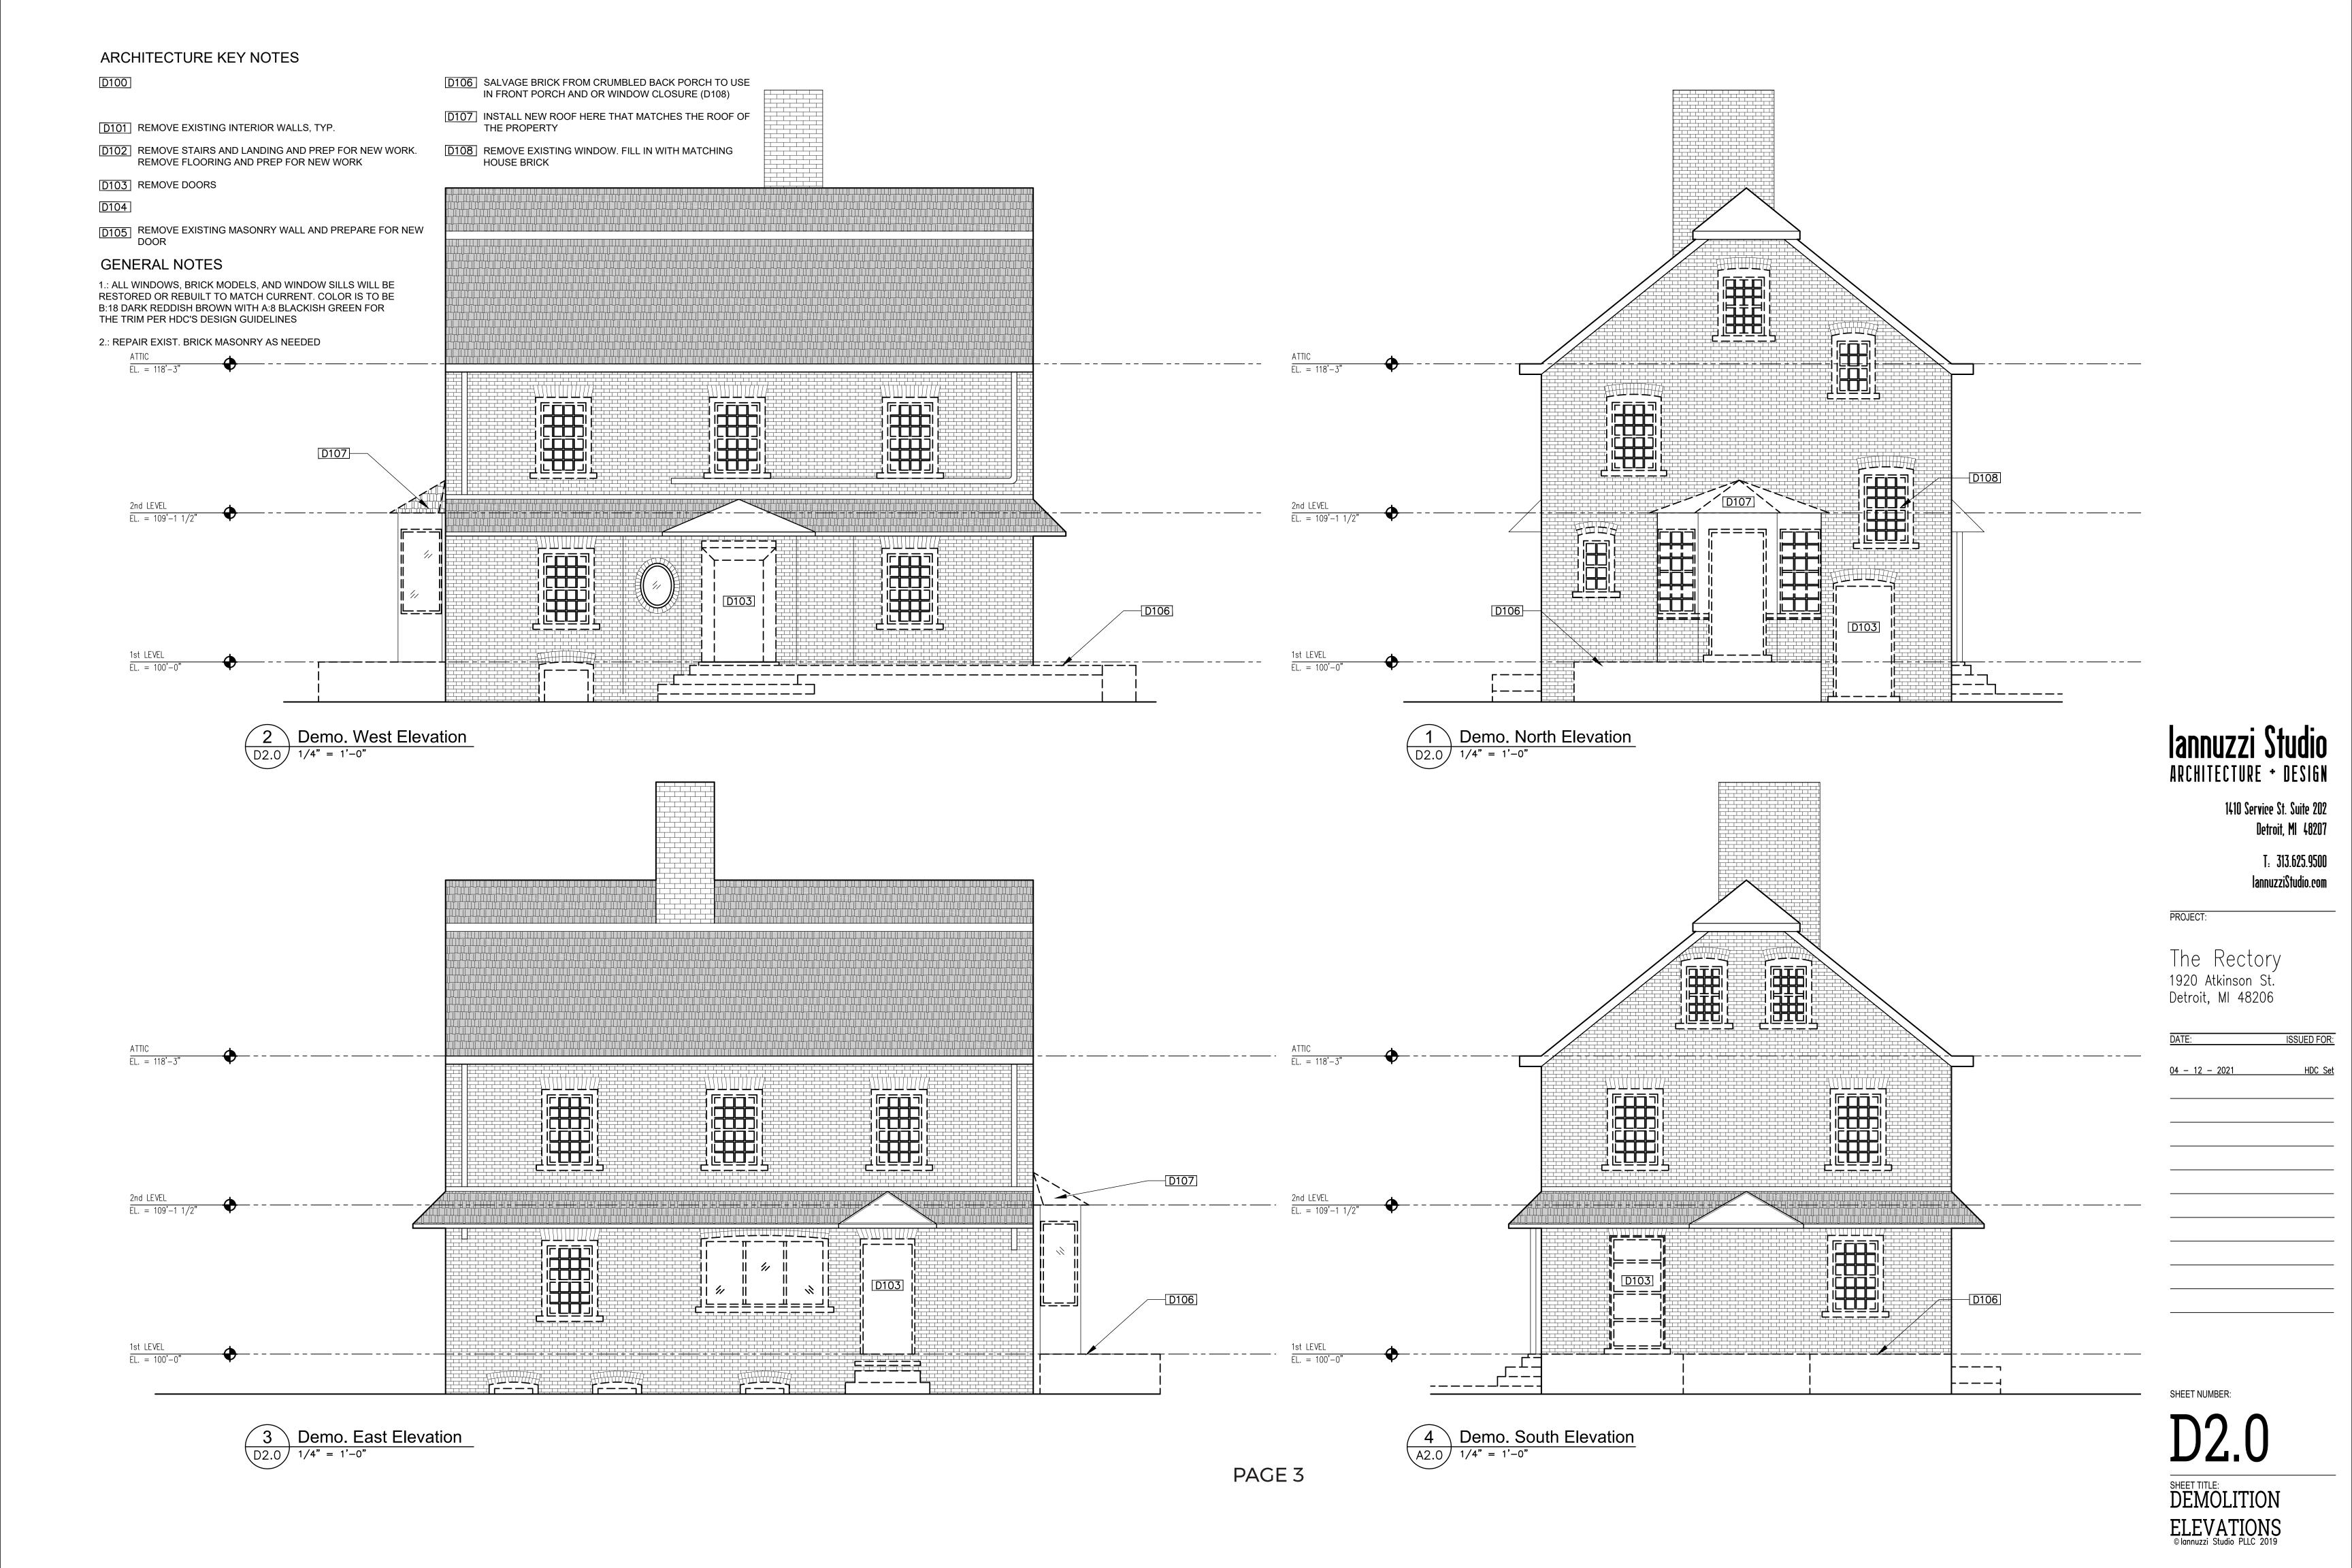EXISTING WALL TO REMAIN

NEW FULL HT WALL - SEE WALL TYPES FOR DETAILS

ARCHITECTURE KEY NOTES

A100 EXISTING MASONRY FIREPLACE & CHIMNEY

A101 FIRE-RATED WALL

A102

A103


A104 NEW DOOR


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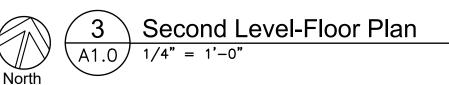
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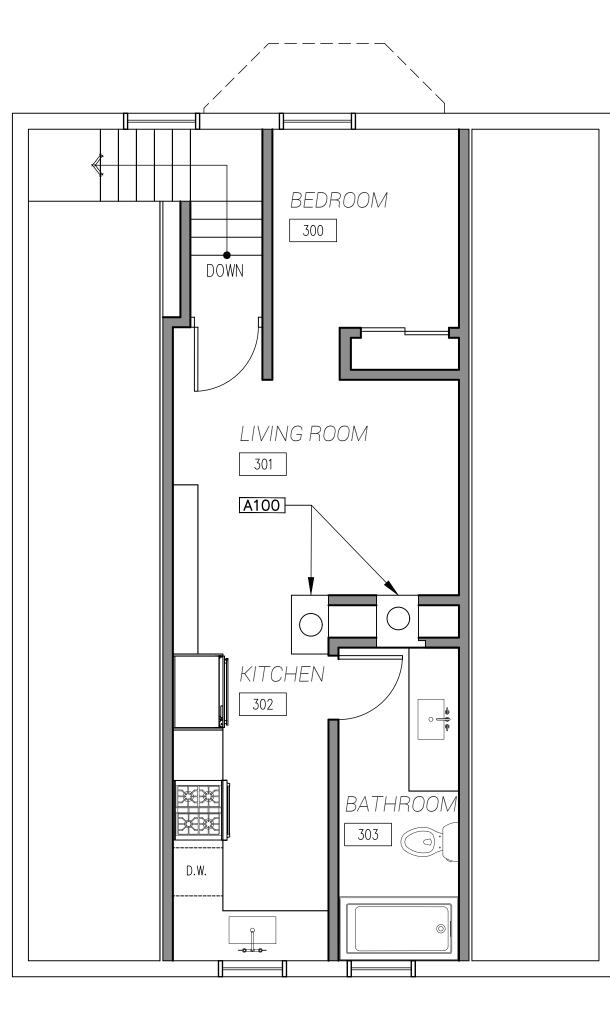
GENERAL NOTES


1.: ALL WINDOWS, BRICK MODELS, AND WINDOW SILLS WILL BE RESTORED OR REBUILT TO MATCH CURRENT. COLOR IS TO BE B:18 DARK REDDISH BROWN WITH A:8 BLACKISH GREEN FOR THE TRIM PER HDC'S DESIGN GUIDELINES





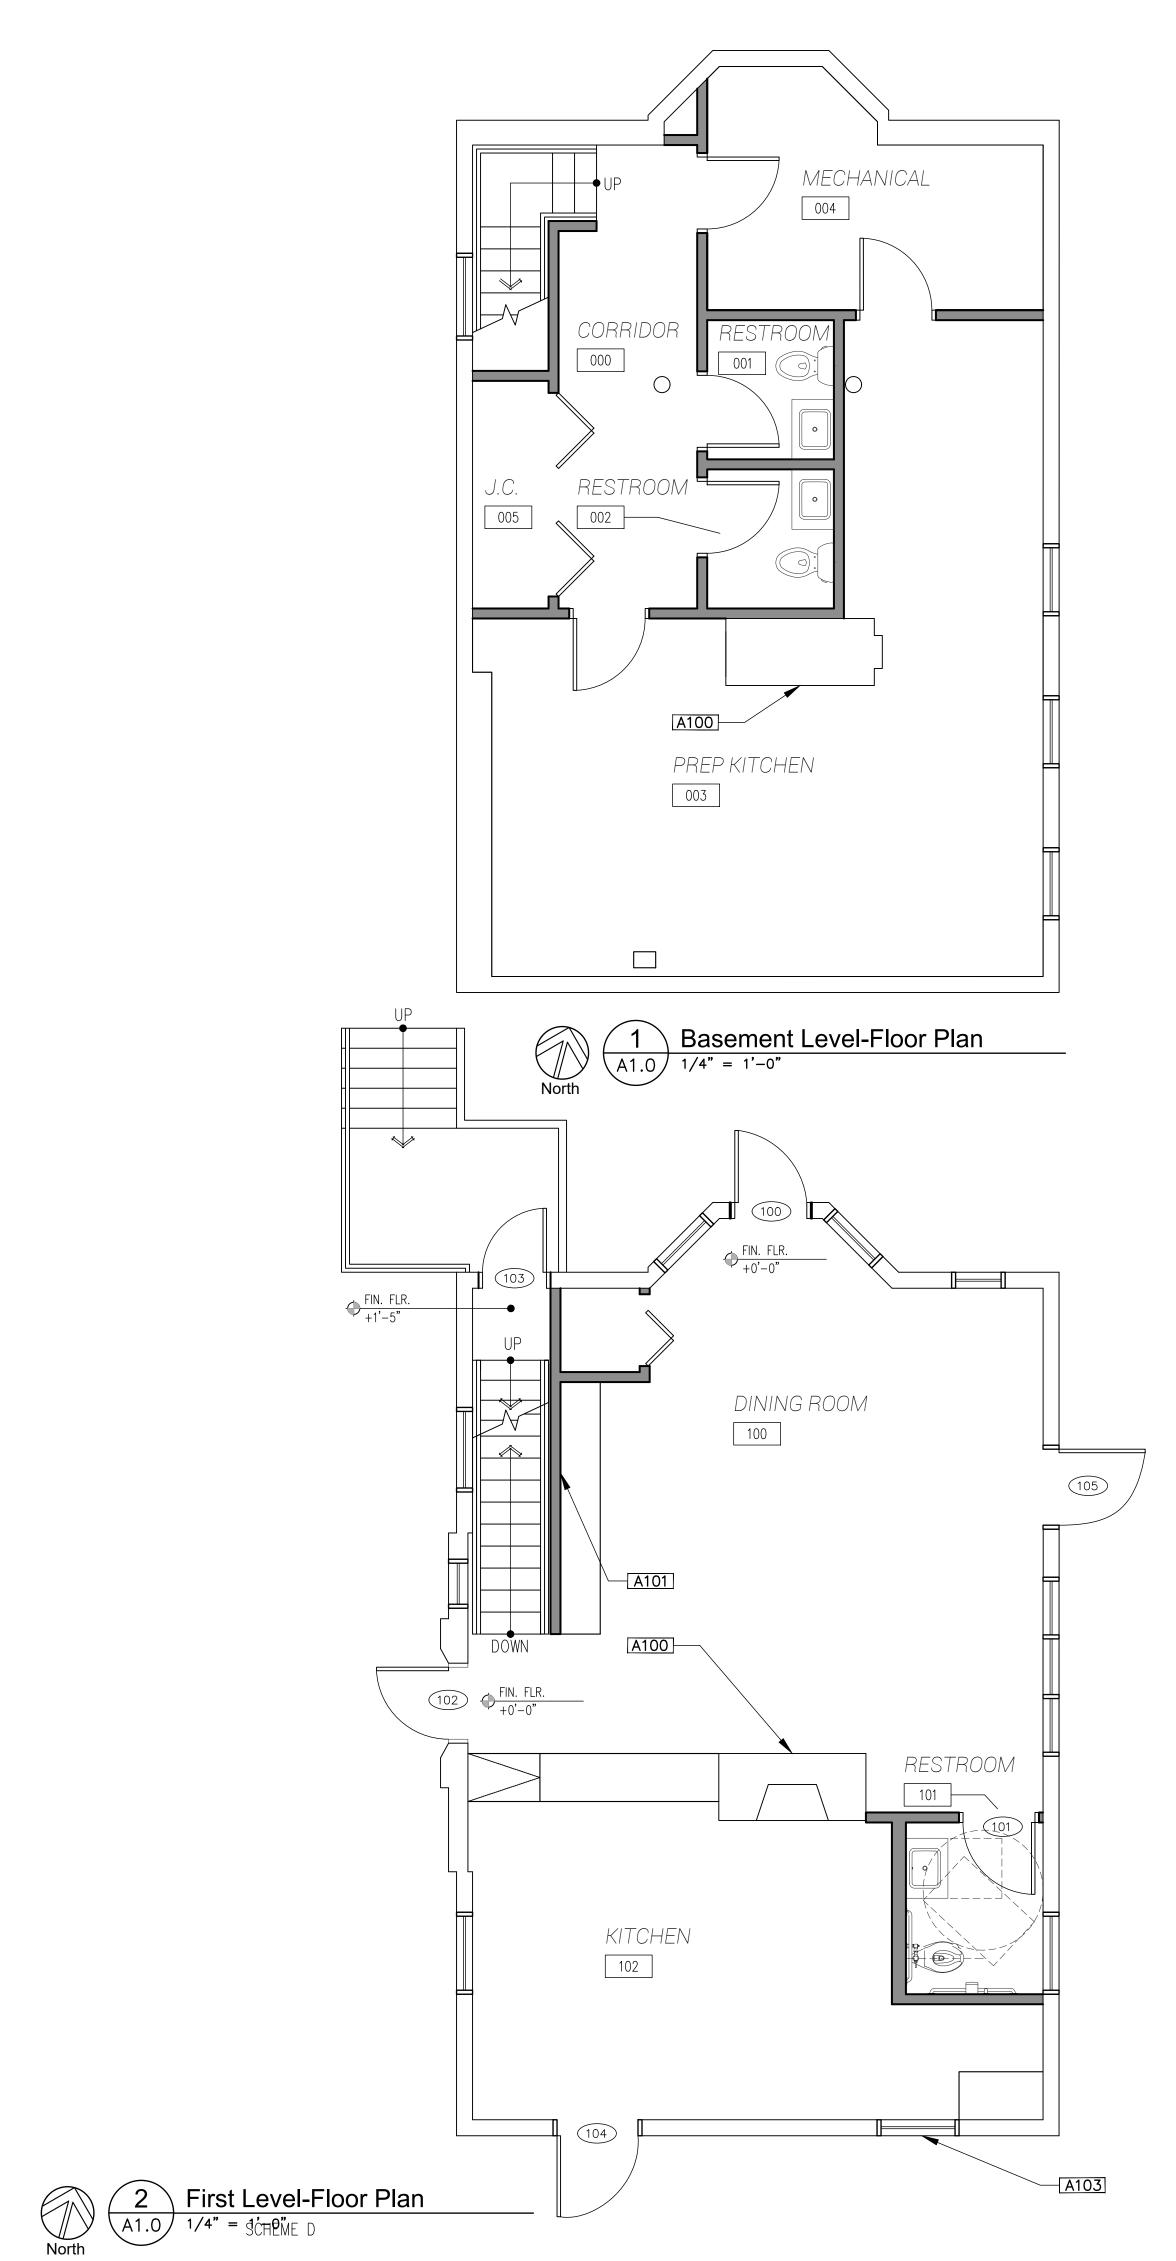

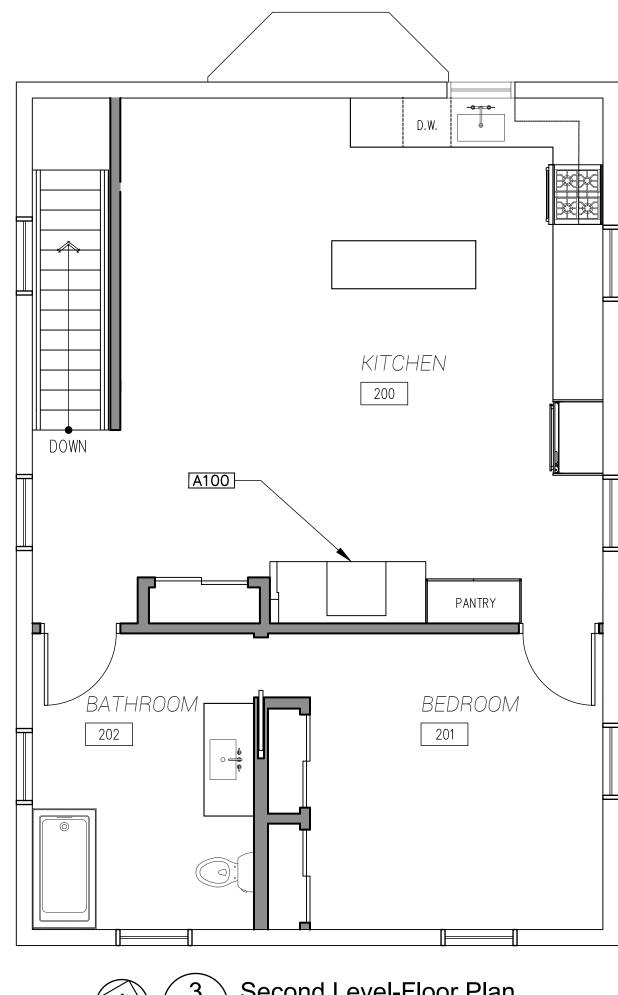

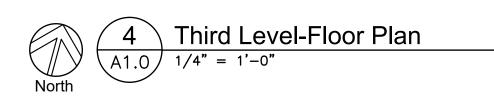

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PROJECT:


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DATE:	ISSUED FOR:
04 - 12 - 2021	HDC Set

SHEET NUMBER:

SHEET TITLE: FLOOR PLANS

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A106

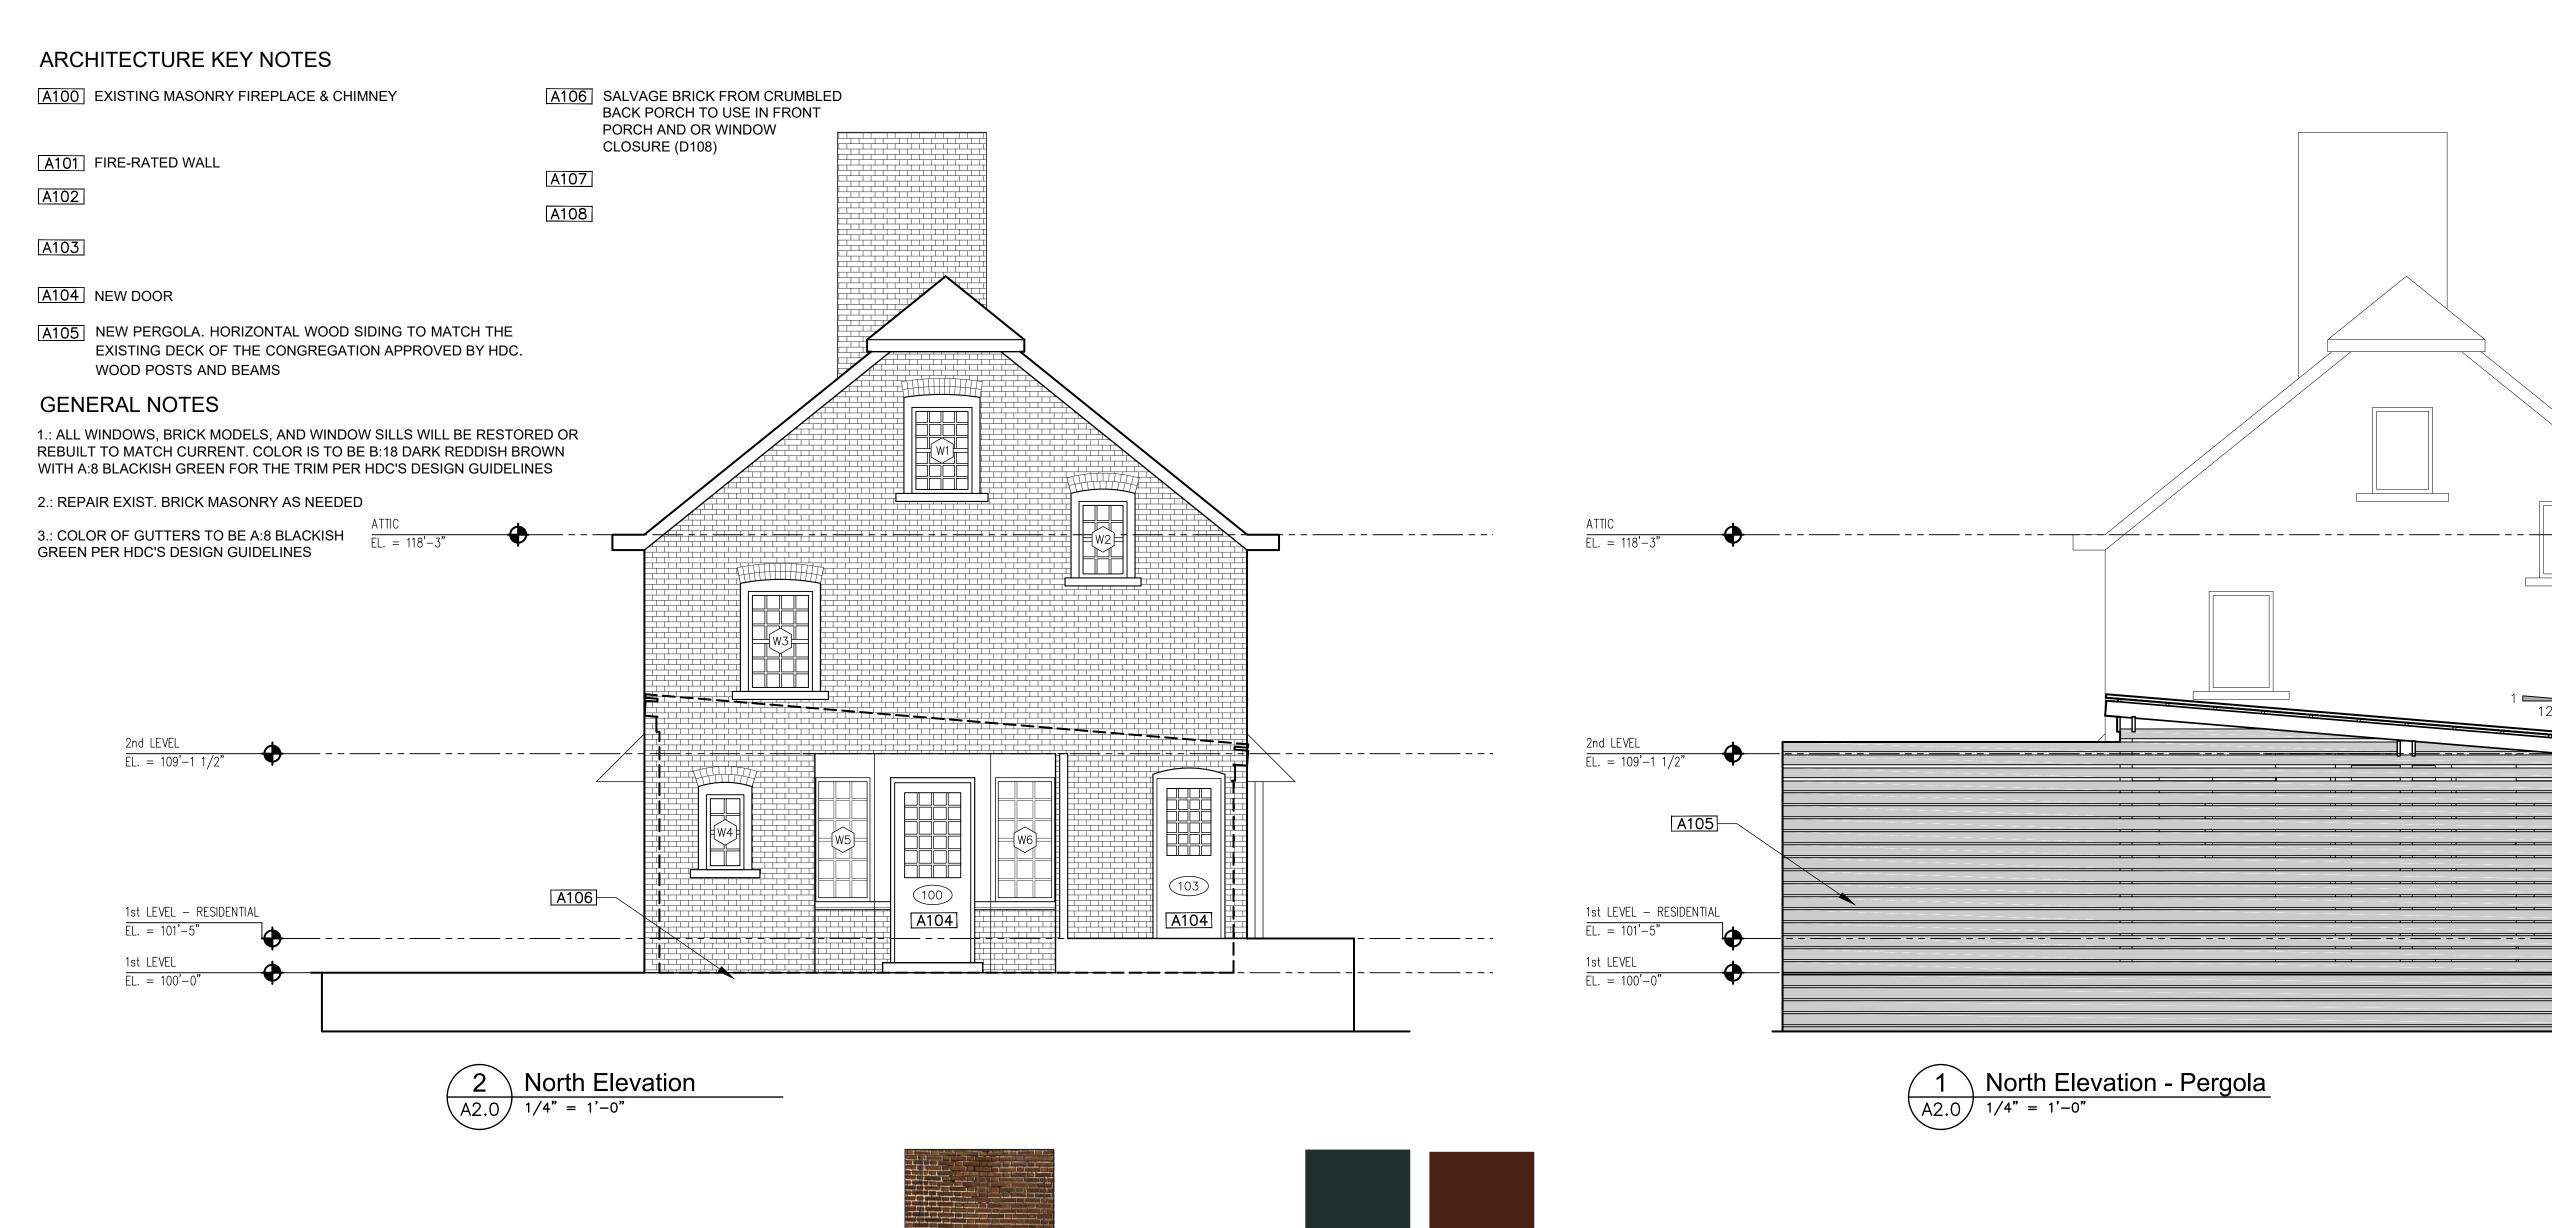

3 South Elevation
A2.0 1/4" = 1'-0"

1st LEVEL - RESIDENTIAL EL. = 101'-5"

 $\frac{1st LEVEL}{EL. = 100'-0"}$

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> > ISSUED FOR:

PROJECT:

The Rectory 1920 Atkinson St. Detroit, MI 48206

4 - 12 - 2021	HDC Set

SHEET NUMBER:

A2.0

SHEET TITLE: PROP. EXTERIOR

ELEVATIONS
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A100 EXISTING MASONRY FIREPLACE & CHIMNEY

A106 SALVAGE BRICK FROM CRUMBLED BACK PORCH TO USE IN FRONT PORCH AND OR WINDOW CLOSURE (D108)

A101 FIRE-RATED WALL

A107

A102

A103

A104 NEW DOOR

A105 NEW PERGOLA. HORIZONTAL WOOD SIDING TO MATCH THE EXISTING DECK OF THE CONGREGATION APPROVED BY HDC. WOOD POSTS AND BEAMS


GENERAL NOTES

1.: ALL WINDOWS, BRICK MODELS, AND WINDOW SILLS WILL BE RESTORED OR REBUILT TO MATCH CURRENT. COLOR IS TO BE B:18 DARK REDDISH BROWN WITH A:8 BLACKISH GREEN FOR THE TRIM PER HDC'S DESIGN GUIDELINES

2.: REPAIR EXIST. BRICK MASONRY AS NEEDED

3.: COLOR OF GUTTERS TO BE A:8 BLACKISH GREEN PER HDC'S DESIGN GUIDELINES



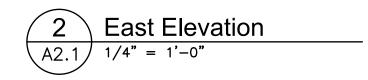

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PROJECT:

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SHEET NUMBER:

A2.1

SHEET TITLE: PROP. EXTERIOR

ELEVATIONS
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		V	WINDOW SCH	HEDULE		
LABEL	DIMENSIONS	LOCATION	OPERATION	MATERIAL	TRIM/SASH/SILL	COMMENTS
W1	2'-6" V.I.F.	NORTH ELEVATION	DOUBLE-HUNG	WOOD WINDOWS	REPAIRED TO MATCH EXIST. DIMENSIONS AND PROFILE; SEE ELEVATIONS FOR PROPOSED TRIM AND SASH COLORS	DETERIORATION: BROKEN GLASS PANES; ROTTED WOOD ON TRIM, SASH, AND SILL DUE TO YEARS OF NEGLECT
W2	,	NORTH ELEVATION	DOUBLE-HUNG	WOOD WINDOWS	REPAIRED TO MATCH	LIGHT CONFIGURATION TO MATCH EXISTING WINDOW DETERIORATION:
	2'-0" V.I.F.				EXIST. DIMENSIONS AND PROFILE; SEE ELEVATIONS FOR PROPOSED TRIM AND SASH COLORS	OVER-CAULKED GLASS PANES; ROTTED WOOD ON TRIM, SASH, AND SILL DUE TO YEARS OF NEGLECT
146	,	100711515147101		WOOD WINDOWS		LIGHT CONFIGURATION TO MATCH EXISTING WINDOW
W3	2'-8" V.I.F.	NORTH ELEVATION	DOUBLE-HUNG	WOOD WINDOWS	REPAIRED TO MATCH EXIST. DIMENSIONS AND PROFILE; SEE ELEVATIONS FOR PROPOSED TRIM AND SASH COLORS	DETERIORATION: OVER-CAULKED GLASS PANES; ROTTED WOOD ON TRIM, SASH, AND SILL DUE TO YEARS OF NEGLECT LIGHT CONFIGURATION TO MATCH EXISTING WINDOW
W4	1'-6 ³ " V.I.F.	NORTH ELEVATION	DOUBLE-HUNG	WOOD WINDOWS	REPAIRED TO MATCH EXIST. DIMENSIONS AND PROFILE; SEE ELEVATIONS FOR	DETERIORATION: MISSING GLASS PANES; ROTTED WOOD ON TRIM, SASH, AND SILL DUE TO YEARS
	3'-1 <u>1</u> " V.I.F.				PROPOSED TRIM AND SASH COLORS	OF NEGLECT LIGHT CONFIGURATION TO MATCH EXISTING WINDOW
W5	2'-10" V.I.F.	NORTH ELEVATION	DOUBLE-HUNG	WOOD WINDOWS	REPAIRED TO MATCH EXIST. DIMENSIONS AND PROFILE; SEE ELEVATIONS FOR PROPOSED TRIM AND SASH COLORS	DETERIORATION: MISSING GLASS PANES; ROTTED WOOD ON TRIM, SASH, AND SILL DUE TO YEARS OF NEGLECT
	2,-5"				S. C. T. G. C.	LIGHT CONFIGURATION TO MATCH EXISTING WINDOW
W6	2'-10" V.I.F.	NORTH ELEVATION	DOUBLE-HUNG	WOOD WINDOWS	REPAIRED TO MATCH EXIST. DIMENSIONS AND PROFILE; SEE ELEVATIONS FOR PROPOSED TRIM AND SASH COLORS	DETERIORATION: MISSING GLASS PANES; ROTTED WOOD ON TRIM, SASH, AND SILL DUE TO YEARS OF NEGLECT
	2,-2					LIGHT CONFIGURATION TO MATCH EXISTING WINDOW
W7	2'-2" V.I.F.	SOUTH ELEVATION	DOUBLE-HUNG	WOOD WINDOWS	REPAIRED TO MATCH EXIST. DIMENSIONS AND PROFILE; SEE ELEVATIONS FOR PROPOSED TRIM AND SASH COLORS	DETERIORATION: OVER-CAULKED GLASS PANES; MISSING GLASS PANE; ROTTED WOOD ON TRIM, SASH, AND SILL DUE TO YEARS OF NEGLECT
140		OOUTH ELEVATION	DOUBLE LINE	MOOD WINDOWS	DEDAIDED TO MATOU	LIGHT CONFIGURATION TO MATCH EXISTING WINDOW
W8	2'-2" V.I.F.	SOUTH ELEVATION	DOUBLE-HUNG	WOOD WINDOWS	REPAIRED TO MATCH EXIST. DIMENSIONS AND PROFILE; SEE ELEVATIONS FOR PROPOSED TRIM AND SASH COLORS	DETERIORATION: OVER-CAULKED GLASS PANES; MISSING GLASS PANES; ROTTED WOOD ON TRIM, SASH, AND SILL DUE TO YEARS OF NEGLECT
14/0		OOUTH ELEVATION	DOUBLE LINE	WOOD WINDOWS	DEDAIDED TO MATOU	MATCH EXISTING WINDOW
W9	2'-9" V.I.F.	SOUTH ELEVATION	DOUBLE-HUNG	WOOD WINDOWS	REPAIRED TO MATCH EXIST. DIMENSIONS AND PROFILE; SEE ELEVATIONS FOR PROPOSED TRIM AND SASH COLORS	DETERIORATION: MISSING GLASS PANES; ROTTED WOOD ON TRIM, SASH, AND SILL DUE TO YEARS OF NEGLECT LIGHT CONFIGURATION TO
	-4					MATCH EXISTING WINDOW
W10	2'-9" V.I.F.	SOUTH ELEVATION	DOUBLE-HUNG	WOOD WINDOWS	REPAIRED TO MATCH EXIST. DIMENSIONS AND PROFILE; SEE ELEVATIONS FOR PROPOSED TRIM AND SASH COLORS	DETERIORATION: MISSING GLASS PANES; ROTTED WOOD ON TRIM, SASH, AND SILL DUE TO YEARS OF NEGLECT
	4-,4					LIGHT CONFIGURATION TO MATCH EXISTING WINDOW
W11	2'-9" V.I.F.	SOUTH ELEVATION	DOUBLE-HUNG	WOOD WINDOWS	REPAIRED TO MATCH EXIST. DIMENSIONS AND PROFILE; SEE ELEVATIONS FOR PROPOSED TRIM AND SASH COLORS	DETERIORATION: MISSING GLASS PANES; ROTTED WOOD ON TRIM, SASH, AND SILL DUE TO YEARS OF NEGLECT
	4,-4"					LIGHT CONFIGURATION TO MATCH EXISTING WINDOW
W12	2'-9" V.I.F.	WEST ELEVATION	DOUBLE-HUNG	WOOD WINDOWS	REPAIRED TO MATCH EXIST. DIMENSIONS AND PROFILE; SEE ELEVATIONS FOR PROPOSED TRIM AND SASH COLORS	DETERIORATION: OVER-CAULKED GLASS PANES; ROTTED WOOD ON TRIM, SASH, AND SILL DUE TO YEARS OF NEGLECT
	4					LIGHT CONFIGURATION TO MATCH EXISTING WINDOW

	2'-9" V.I.F.	LOCATION WEST ELEVATION	OPERATION DOUBLE-HUNG	MATERIAL WOOD WINDOWS	TRIM/SASH/SILL REPAIRED TO MATCH	COMMENTS DETERIORATION:
L 3	*					
	7.V.F.				EXIST. DIMENSIONS AND PROFILE; SEE ELEVATIONS FOR PROPOSED TRIM AND SASH COLORS	MISSING GLASS PANE OVER-CAULKED GLAS PANES; ROTTED WOO ON TRIM, SASH, AND SILL DUE TO YEARS O NEGLECT
						LIGHT CONFIG. TO MATCH EXIST. WINDO
	2'-9" V.I.F.	WEST ELEVATION	DOUBLE-HUNG	WOOD WINDOWS	REPAIRED TO MATCH EXIST. DIMENSIONS AND PROFILE; SEE ELEVATIONS FOR PROPOSED TRIM AND SASH COLORS	DETERIORATION: MISSING GLASS PANE OVER-CAULKED GLAS PANES; ROTTED WOO ON TRIM, SASH, AND SILL DUE TO YEARS C NEGLECT
<u>+</u>	2'-9" V.I.F.	WEST ELEVATION	DOUBLE-HUNG	WOOD WINDOWS	REPAIRED TO MATCH EXIST. DIMENSIONS AND PROFILE; SEE ELEVATIONS FOR PROPOSED TRIM AND SASH COLORS	LIGHT CONFIG. TO MATCH EXIST. WINDO DETERIORATION: MISSING GLASS PANE ROTTED WOOD ON TRIM, SASH, AND SILL DUE TO YEARS OF NEGLECT
,	4					LIGHT CONFIG. TO MATCH EXIST. WINDO
W16	2'-0½" V.I.F.	WEST ELEVATION	FIXED	WOOD WINDOWS	REPAIRED TO MATCH EXIST. DIMENSIONS AND PROFILE; SEE ELEVATIONS FOR PROPOSED TRIM AND SASH COLORS	DETERIORATION: ROTTED WOOD ON TRIM, SASH, AND SILL DUE TO YEARS OF NEGLECT
	5,-9,				97677 00207.0	LIGHT CONFIG. TO MATCH EXIST. WINDO
W17	2'-9" V.I.F.	WEST ELEVATION	DOUBLE-HUNG	WOOD WINDOWS	REPAIRED TO MATCH	DETERIORATION:
L S					EXIST. DIMENSIONS AND PROFILE; SEE ELEVATIONS FOR PROPOSED TRIM AND SASH COLORS	MISSING GLASS PANE ROTTED WOOD ON TRIM, SASH, AND SILI DUE TO YEARS OF NEGLECT
}	4					LIGHT CONFIG. TO MATCH EXIST. WINDO
	2'-9" V.I.F.	EAST ELEVATION	DOUBLE-HUNG	WOOD WINDOWS	REPAIRED TO MATCH EXIST. DIMENSIONS AND PROFILE; SEE ELEVATIONS FOR PROPOSED TRIM AND SASH COLORS	DETERIORATION: MISSING GLASS PANI ROTTED WOOD ON TRIM, SASH, AND SILI DUE TO YEARS OF NEGLECT
-	4 - 3 - 3 - 3 - 3 - 3 - 3 - 3 - 3 - 3 -					LIGHT CONFIG. TO MATCH EXIST. WINDO
W19	2'-9" V.I.F.	EAST ELEVATION	DOUBLE-HUNG	WOOD WINDOWS	REPAIRED TO MATCH EXIST. DIMENSIONS AND PROFILE; SEE ELEVATIONS FOR PROPOSED TRIM AND	DETERIORATION: ROTTED WOOD ON TRIM, SASH, AND SILI DUE TO YEARS OF NEGLECT
6.	V. 4 - 25 - 7 - 7 - 7 - 7 - 7 - 7 - 7 - 7 - 7 -				SASH COLORS	LIGHT CONFIG. TO MATCH EXIST. WINDO
	2'-9" V.I.F.	EAST ELEVATION	DOUBLE-HUNG	WOOD WINDOWS	REPAIRED TO MATCH EXIST. DIMENSIONS AND PROFILE; SEE ELEVATIONS FOR PROPOSED TRIM AND SASH COLORS	DETERIORATION: MISSING GLASS PANI ROTTED WOOD ON TRIM, SASH, AND SILI DUE TO YEARS OF NEGLECT
,	4 - 32					LIGHT CONFIG. TO MATCH EXIST. WINDO
W21	2'-9" V.I.F.	EAST ELEVATION	DOUBLE-HUNG	WOOD WINDOWS	REPAIRED TO MATCH EXIST. DIMENSIONS AND PROFILE; SEE ELEVATIONS FOR PROPOSED TRIM AND SASH COLORS	DETERIORATION: MISSING GLASS PANI ROTTED WOOD ON TRIM, SASH, AND SILI DUE TO YEARS OF NEGLECT
	4					LIGHT CONFIG. TO MATCH EXIST. WINDO
W22	7'-1½" V.I.F.	EAST ELEVATION	FIXED CENTER; LEFT AND RIGHT CRANK OUT	WOOD WINDOWS	REPAIRED TO MATCH EXIST. DIMENSIONS AND PROFILE; SEE ELEVATIONS FOR PROPOSED TRIM AND SASH COLORS	DETERIORATION: MISSING GLASS PAN ROTTED WOOD ON TRIM, SASH, AND SIL DUE TO YEARS OF NEGLECT
						LIGHT CONFIG. TO MATCH EXIST. WINDO

	EXTERIOR DOOR SCHEDULE						
LABEL 100	J'-2" V.I.F.	LOCATION NORTH ELEVATION	MATERIAL FIBERGLASS	TRIM REPLACED TO MATCH EXIST. DIMENSIONS AND PROFILE; SEE ELEVATIONS FOR PROPOSED TRIM COLORS	COMMENTS DETERIORATION: BOARDED UP OPENING, NO DOOR IN PLACE COMMERCIAL GRADE MULTI-GRADE DOOR TO MATCH WINDOW'S DESIGN MAIN ENTRANCE TO RESTAURANT		
102	3'-0" V.I.F.	WEST ELEVATION	FIBERGLASS	REPLACED TO MATCH EXIST. DIMENSIONS AND PROFILE; SEE ELEVATIONS FOR PROPOSED TRIM COLORS	DETERIORATION: WOOD DOOR IN EXTREMELY POOR SHAPE COMMERCIAL GRADE MULTI-GRADE DOOR TO MATCH WINDOW'S DESIGN SECONDARY ENTRANCE TO RESTAURANT		
103	2'-8" V.I.F.	NORTH ELEVATION	FIBERGLASS	REPLACED TO MATCH EXIST. DIMENSIONS AND PROFILE; SEE ELEVATIONS FOR PROPOSED TRIM COLORS	DETERIORATION: WOOD DOOR IN EXTREMELY POOR SHAPE COMMERCIAL GRADE OR NEAR COMMERCIAL GRADE MULTI-GRADE DOOR TO MATCH WINDOW'S DESIGN ENTRANCE FOR RESIDENTIAL TENANT/S		
104	3'-2½" V.I.F.	SOUTH ELEVATION	FIBERGLASS	REPLACED TO MATCH EXIST. DIMENSIONS AND PROFILE; SEE ELEVATIONS FOR PROPOSED TRIM COLORS	NON-OPERABLE; NO HARDWARE TO MATCH WINDOW'S DESIGN		
105	3'-0" V.I.F.	EAST ELEVATION	FIBERGLASS	REPLACED TO MATCH EXIST. DIMENSIONS AND PROFILE; SEE ELEVATIONS FOR PROPOSED TRIM COLORS	NON-OPERABLE; NO HARDWARE TO MATCH WINDOW'S DESIGN		

lannuzzi Studio ARCHITECTURE + DESIGN 1410 Service St. Suite 202 Detroit, MI 48207 T: 313.625.9500 JannuzziStudio.com

ROJECT:

The Rectory 1920 Atkinson St. Detroit, MI 48206


04 - 12 - 2021 HDC

SHEET NUMBER:

A7.0

SHEET TITLE:
Door, Window &
Finish Schedule
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SITE PHOTOS



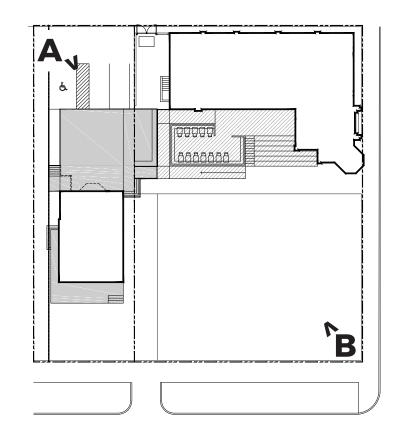





B-FRONT CORNER OF THE SITE

EXISTING ELEVATIONS







NORTH ELEVATION

REMOVING WINDOW TO
MOVE DOOR 103 UP FOR
NEW PATIO - SEE
ELEVATIONS AND PLANS



SOUTH ELEVATION



SOUTH ELEVATION

EXISTING ELEVATIONS










WEST ELEVATION EAST ELEVATION

EXISTING DETAILS





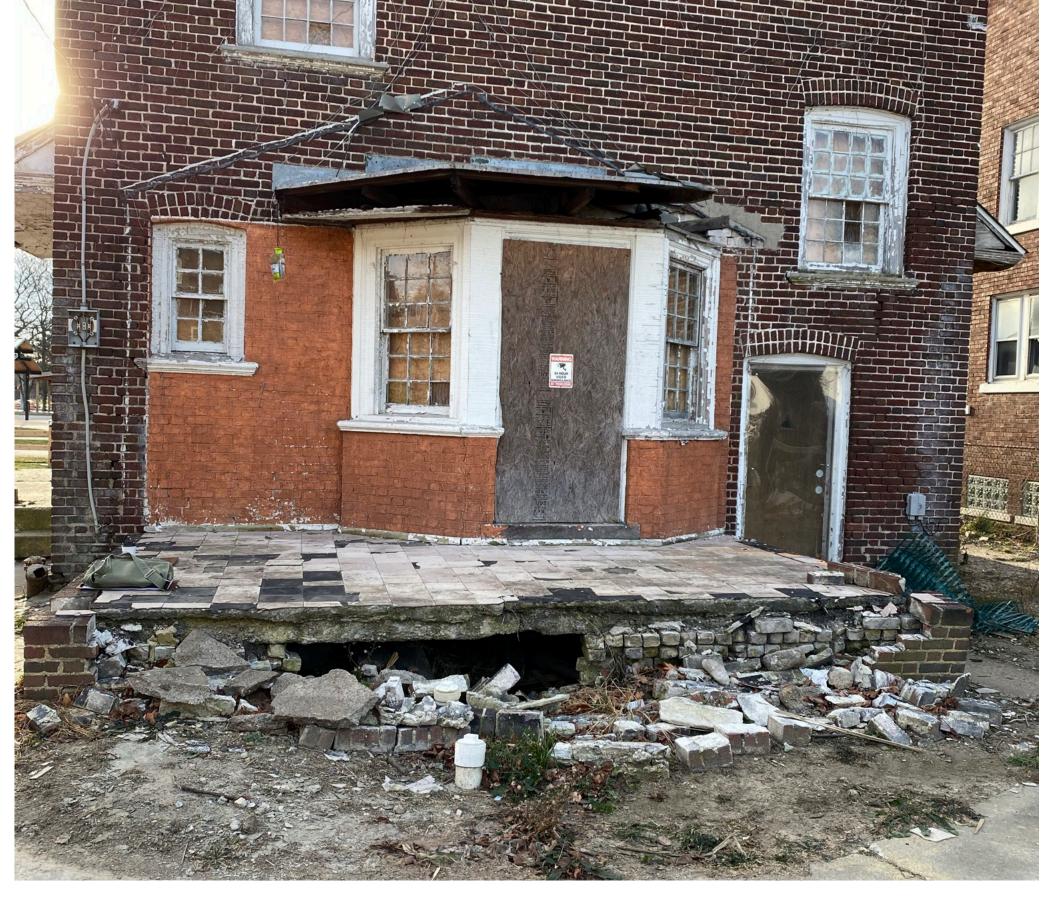

PORCHES

SALVAGE BRICK FROM CRUMBLED BACK PORCH TO USE IN FRONT PORCH AND OR WINDOW CLOSURE (D108)







WINDOWS

ALL WINDOWS, BRICK MODELS, AND WINDOW SILLS WILL BE RESTORED OR REBUILT TO MATCH CURRENT. COLOR IS TO BE B:18 DARK REDDISH BROWN WITH A:8 BLACKISH GREEN FOR THE TRIM PER HDC'S DESIGN GUIDELINES



GUTTERS

COLOR OF GUTTERS TO BE A:8 BLACKISH GREEN PER HDC'S DESIGN GUIDELINES

EXISTING DETAILS




DOOR A - NEW DOOR SILL HEIGHT AND DOOR (103) FOR RESIDENTIAL TENANTS - SEE DOOR SCHEDULE FOR DETAILS

EXISTING MATERIAL: WOOD




DOOR B - NEW DOOR (102) FOR SECONDARY ENTRANCE TO RESTAURANT - SEE DOOR SCHEDULE FOR DETAILS

EXISTING MATERIAL: WOOD; CURRENT DOOR IS MISSING AND IS HELD BY AN ACRYLIC PIECE

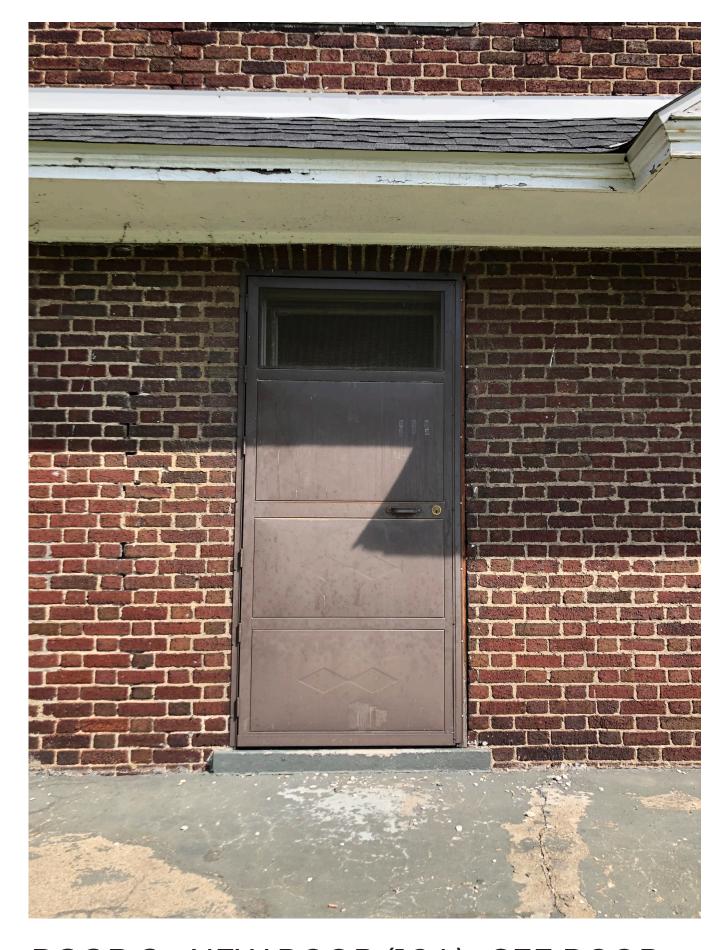

DOOR C - NEW DOOR (104) - SEE DOOR SCHEDULE FOR DETAILS

EXISTING MATERIAL: METAL

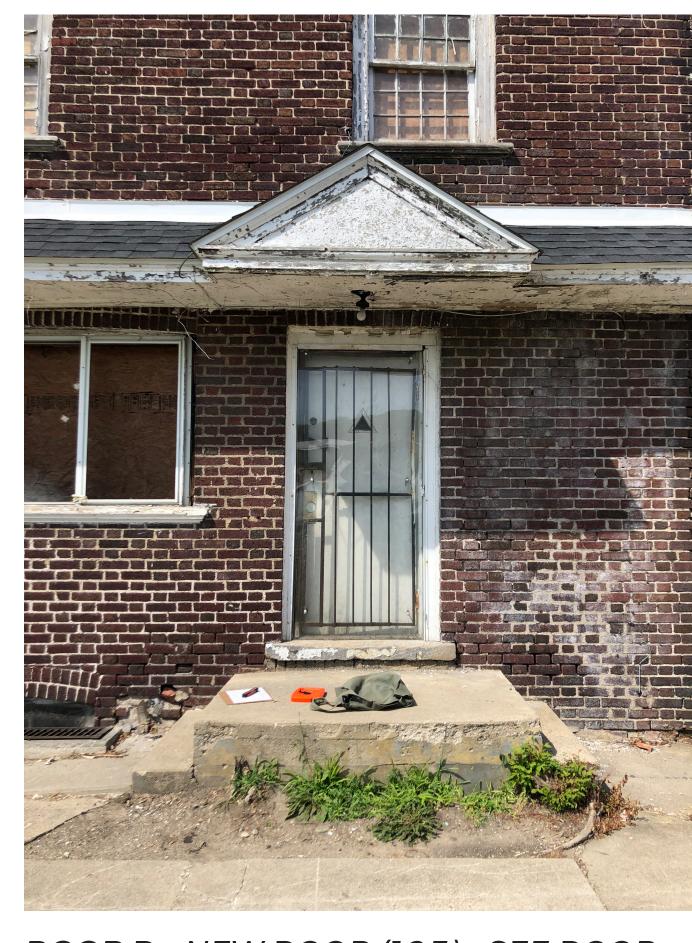

DOOR D - NEW DOOR (105) - SEE DOOR SCHEDULE FOR DETAILS

EXISTING MATERIAL: WOOD


DOORS


ALL EXTERIOR NON-HISTORIC DOORS TO BE REPLACED.


NORTH ELEVATION DOOR TO BE RELOCATED. SEE PROPOSED ELEVATIONS AND DOOR SCHEDULE.


THE DOOR WOOD TRIMS ARE ROTTED AND NEED TO BE REPLACED AS WELL. BECAUSE THE FIRST FLOOR WILL BE A COMMERCIAL SPACE, ALL EXISTING DOORS ARE NOT TO CODE AND MUST SWING OUT. NEW DOORS WILL MIMIC ADJACENT WINDOW DESIGN.

PERGOLA PROPOSAL

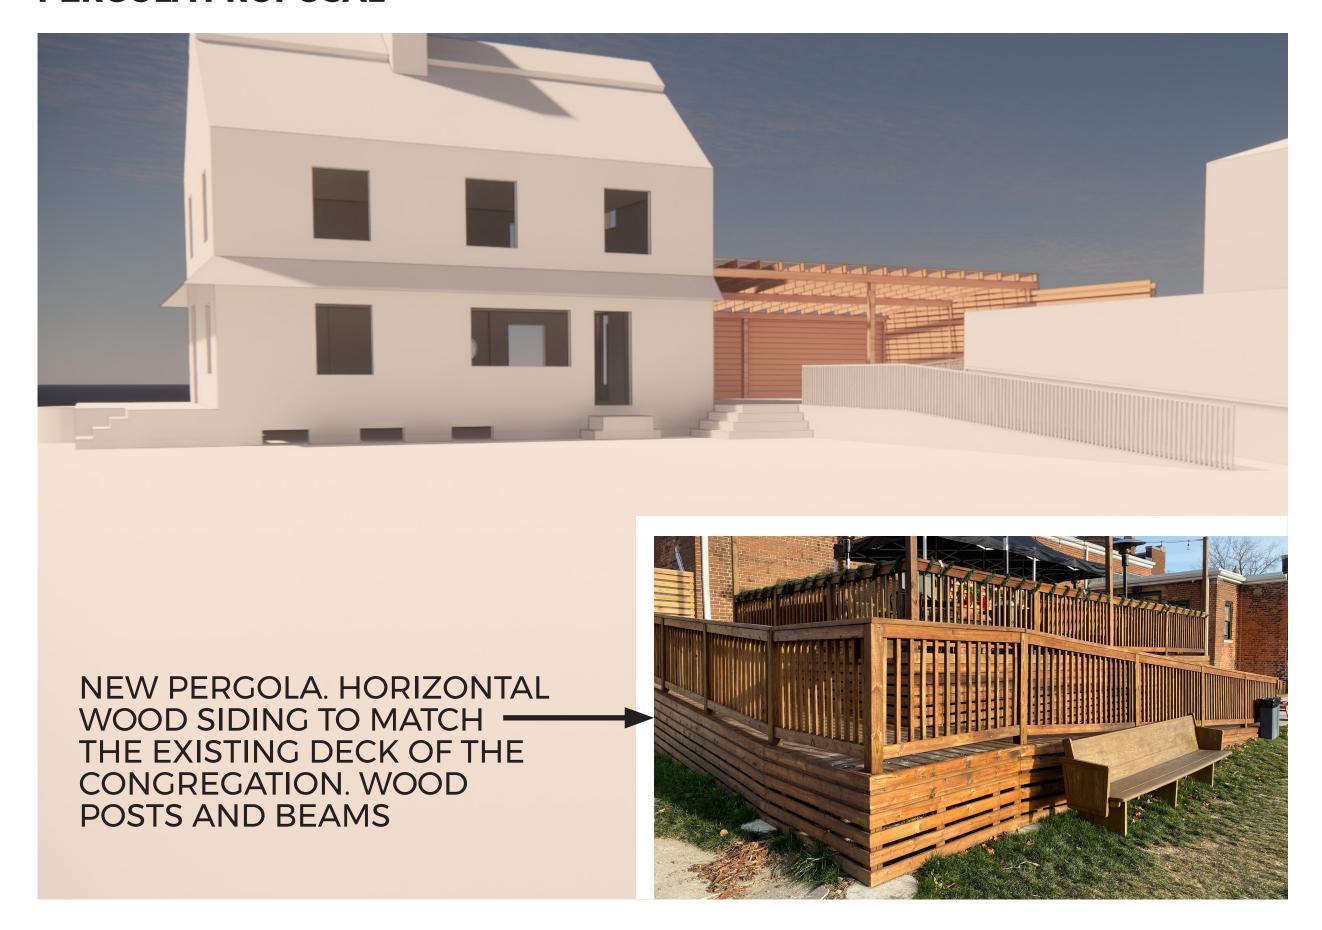

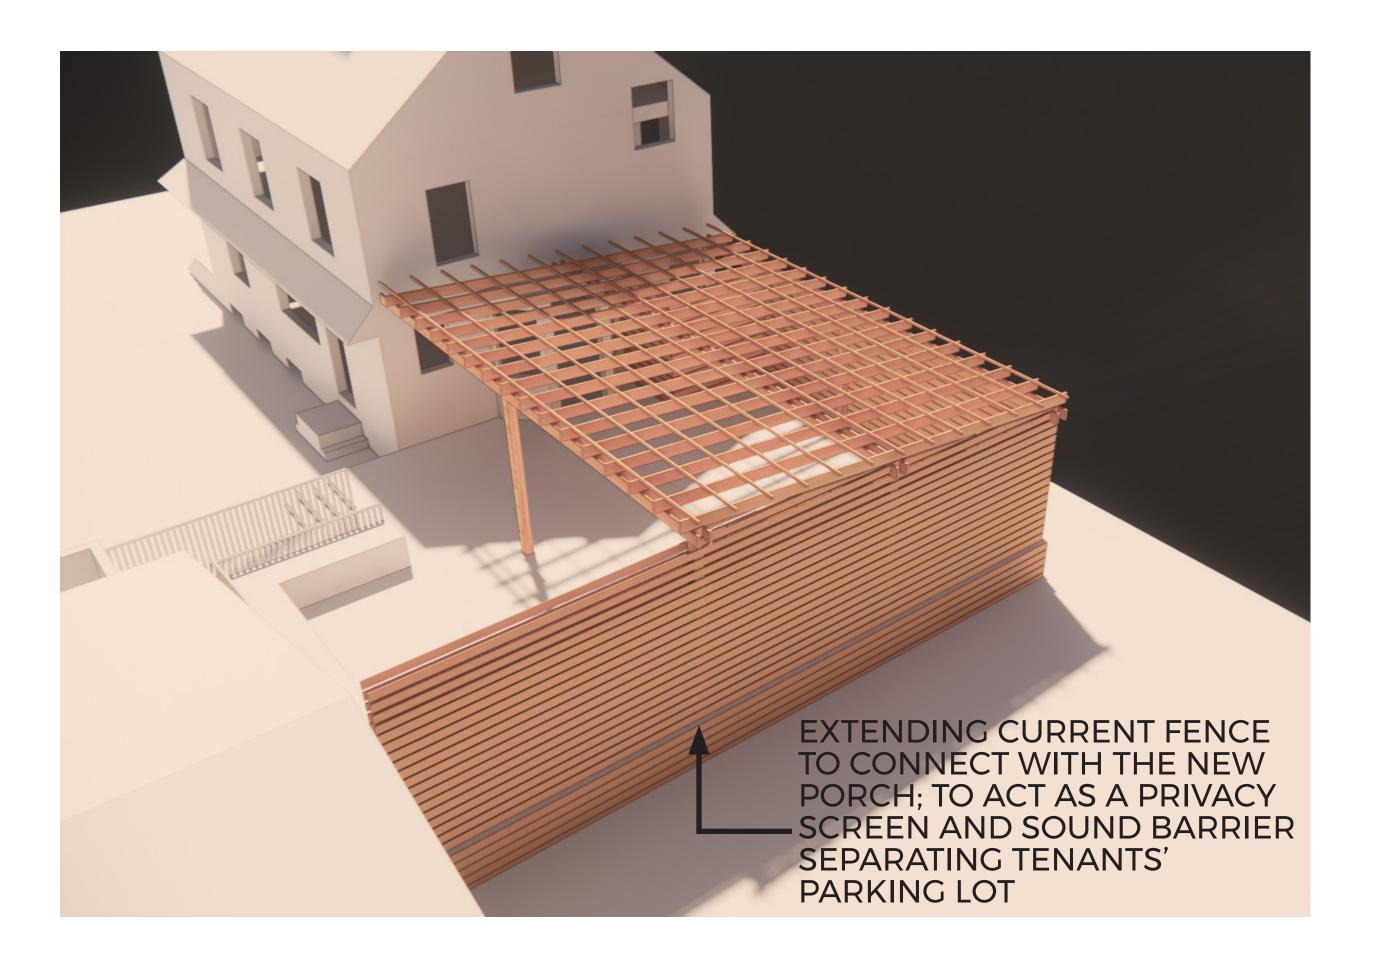

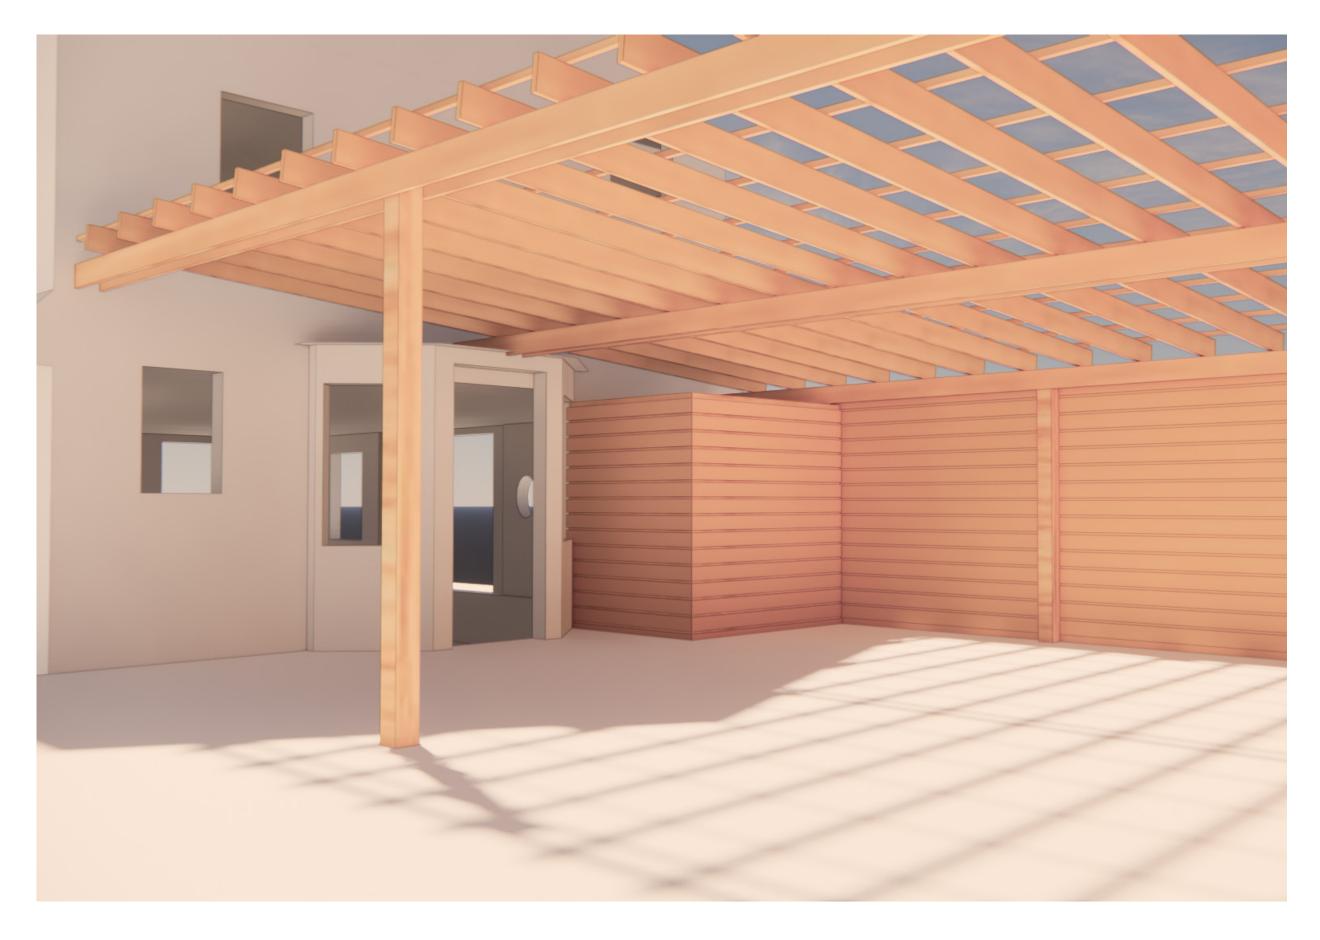

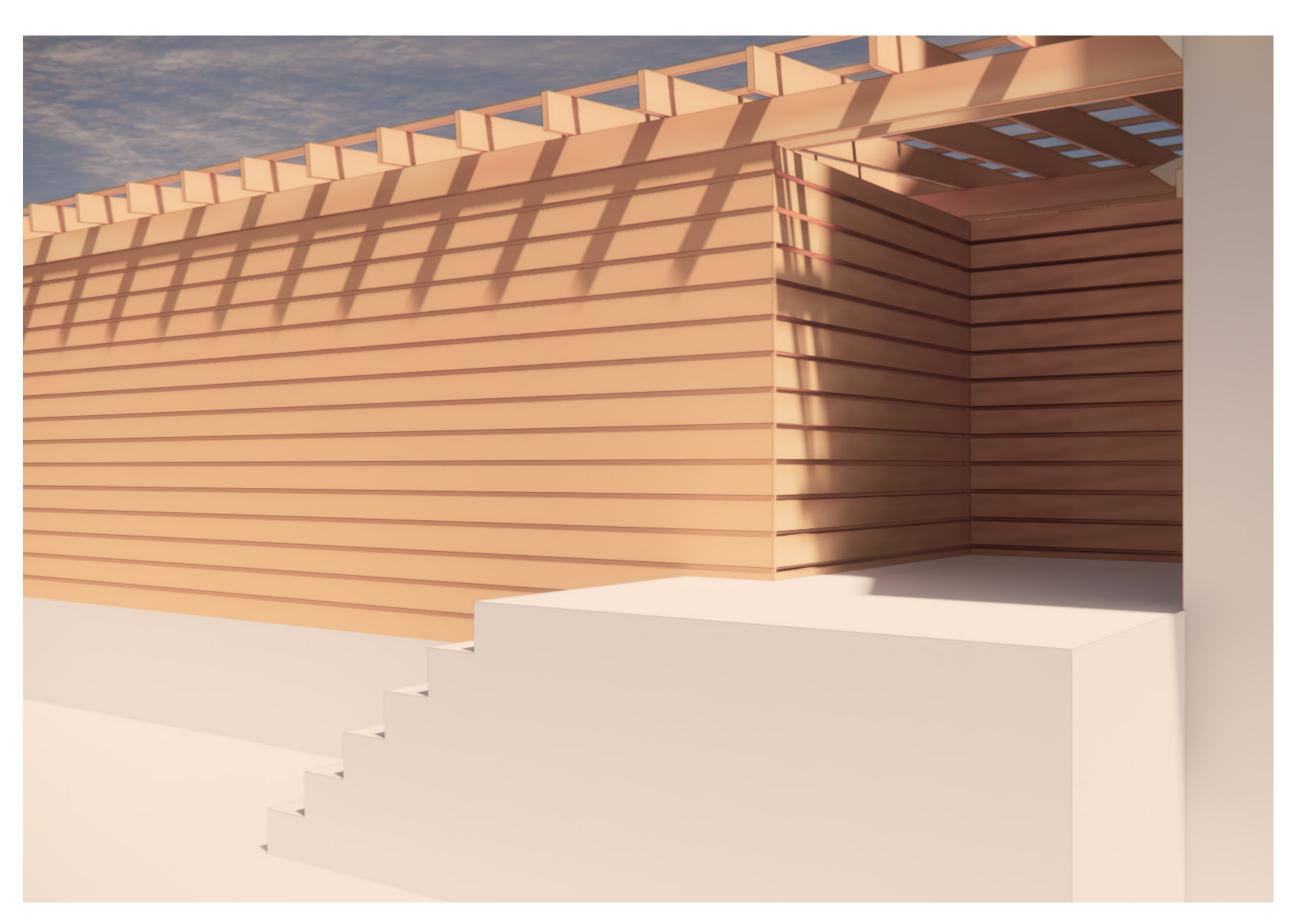

PERGOLA PROPOSAL

