


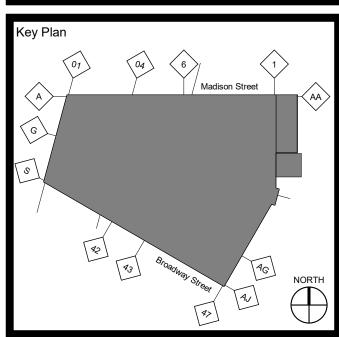

Issue History HDC REVIEW MECHANICAL BID PACKAGE OWNER REVIEW No. Description Refer To Sheet Index For Complete Issue History

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THEATRE


Detroit Opera House Renovation -Phase 1A

In Charge Z. TOLBERT Designed ZAT

Drawn By AD

Checked JK Approved J. GAINES Date 01/20/2

FIRST FLOOR PLAN

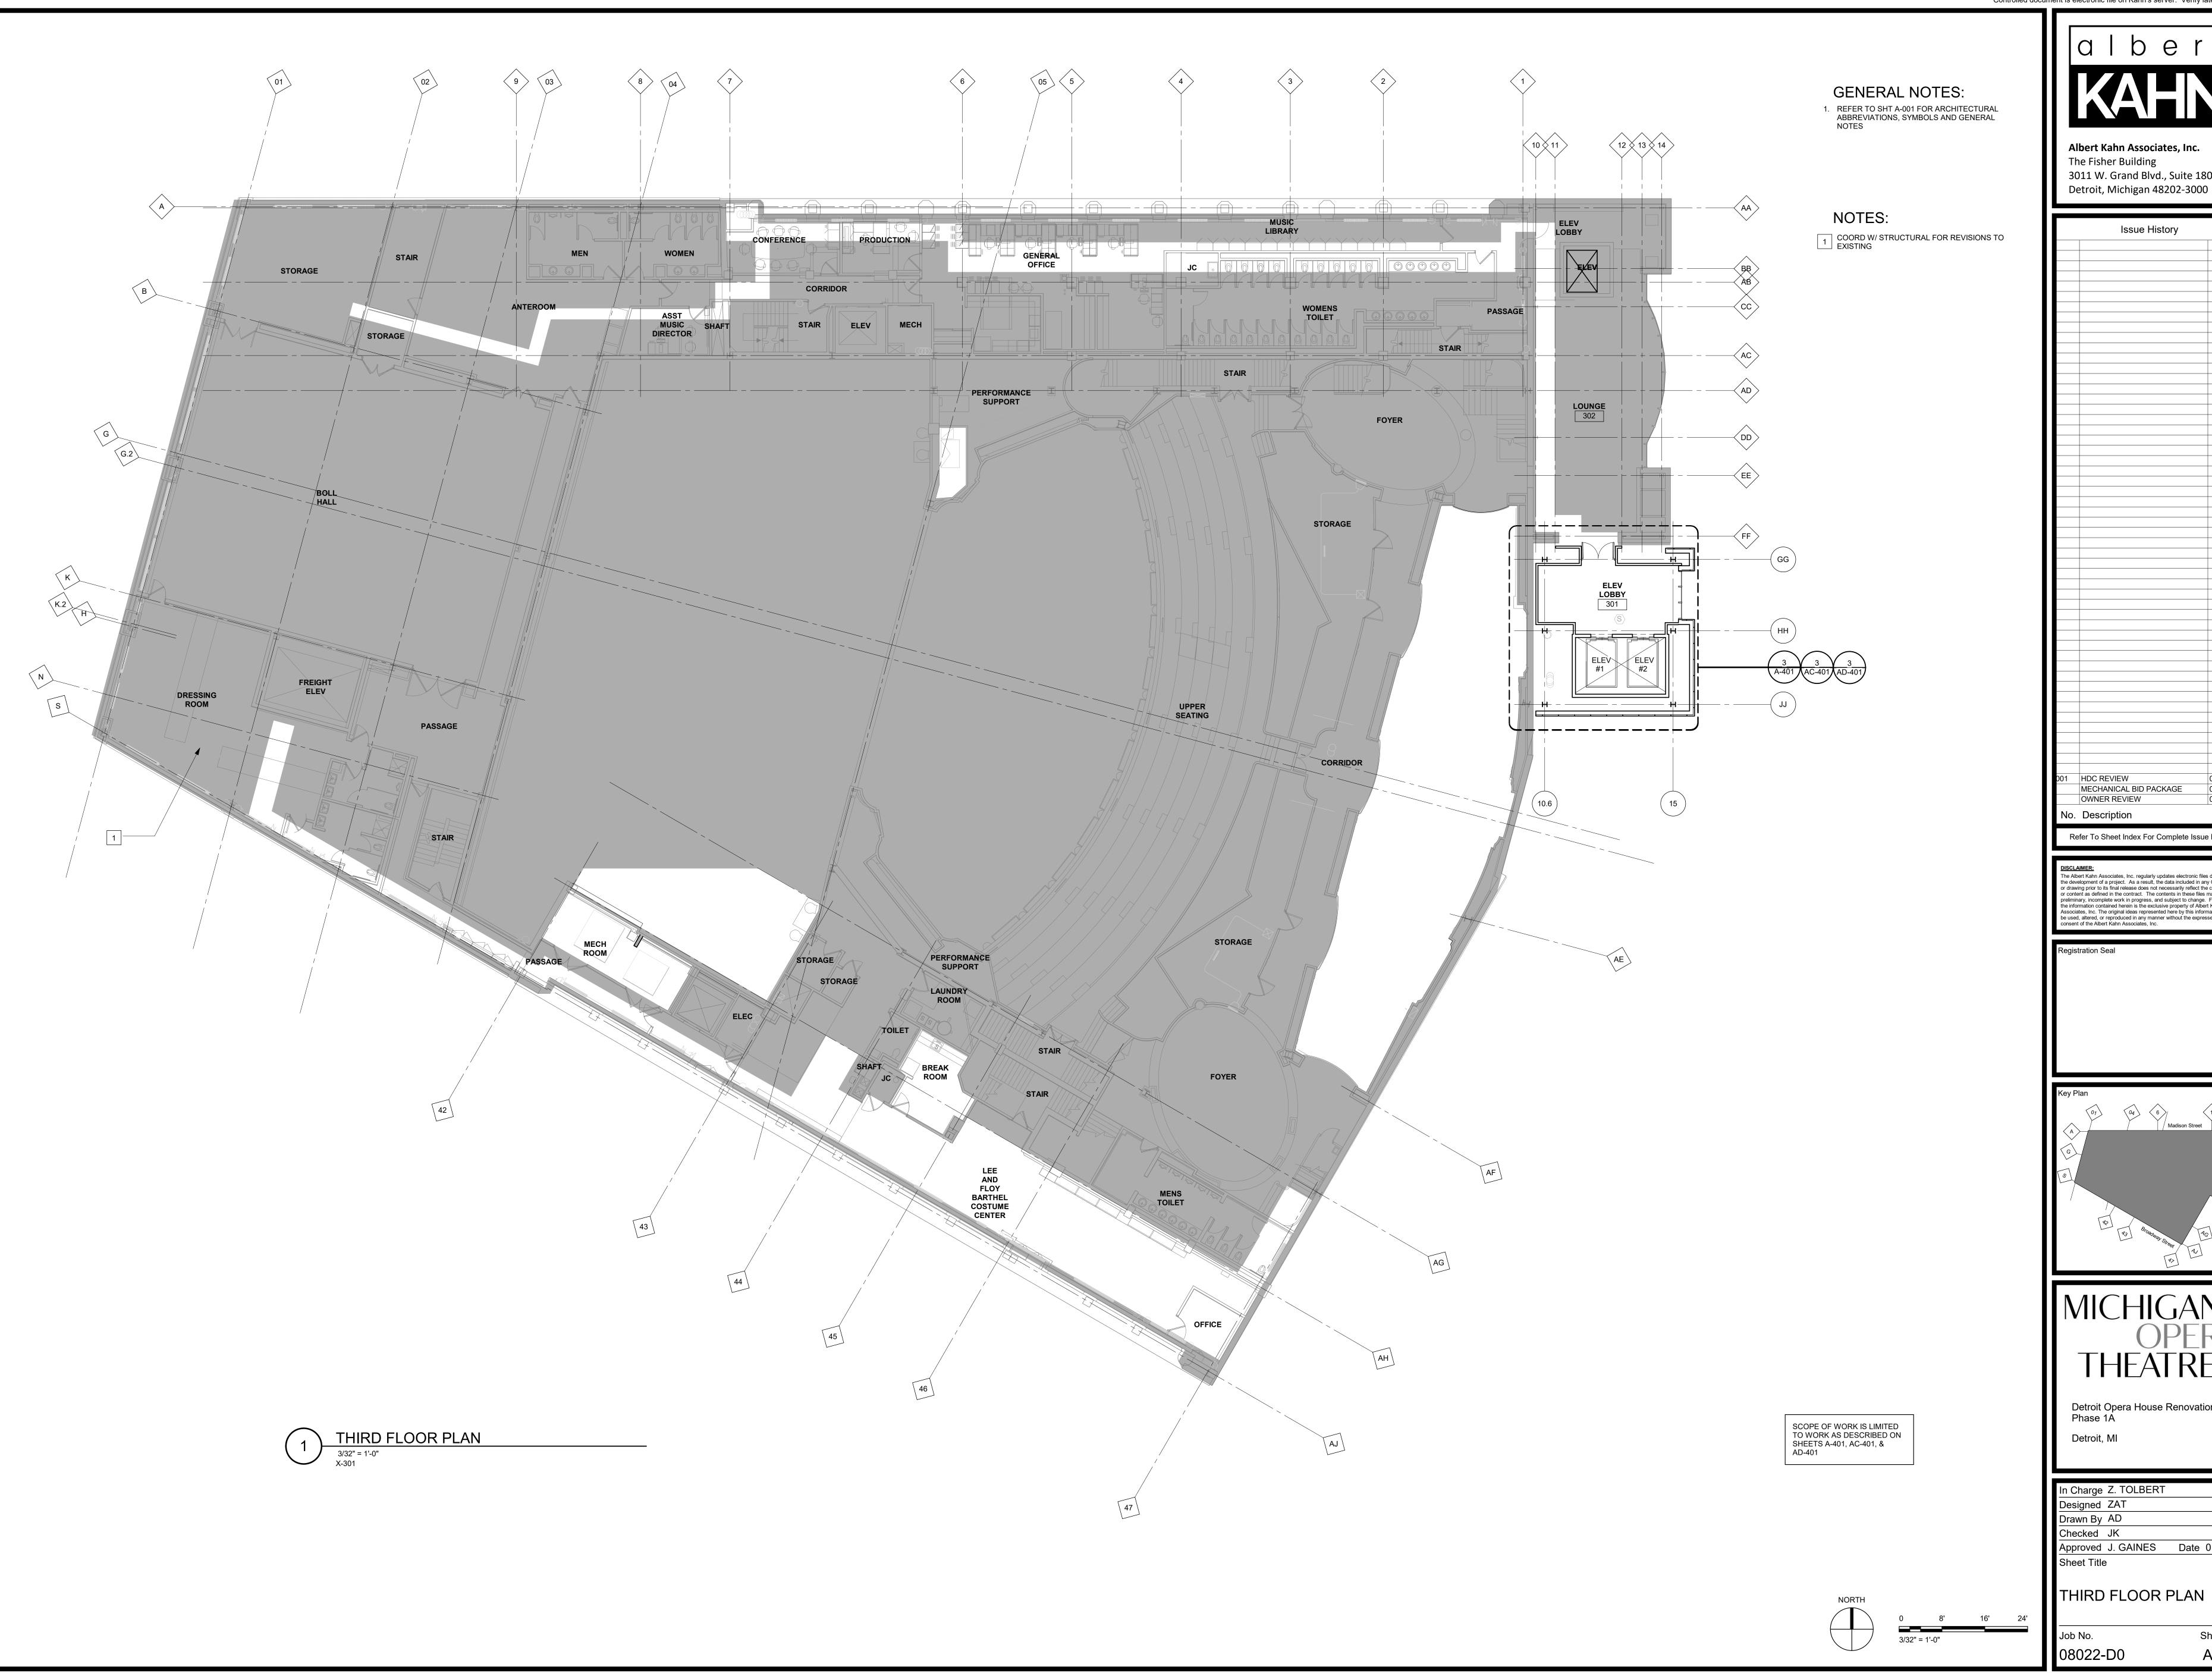




Issue History HDC REVIEW MECHANICAL BID PACKAGE OWNER REVIEW No. Description Refer To Sheet Index For Complete Issue History

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THEATRE


Detroit Opera House Renovation -Phase 1A

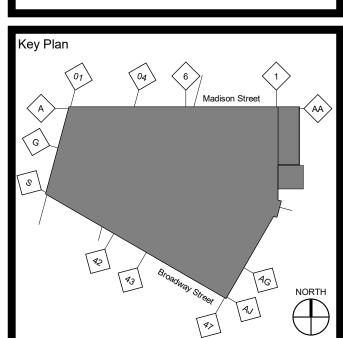Designed ZAT
Drawn By AD Checked JK

Approved J. GAINES Date 01/20/2

Sheet No.

A-103

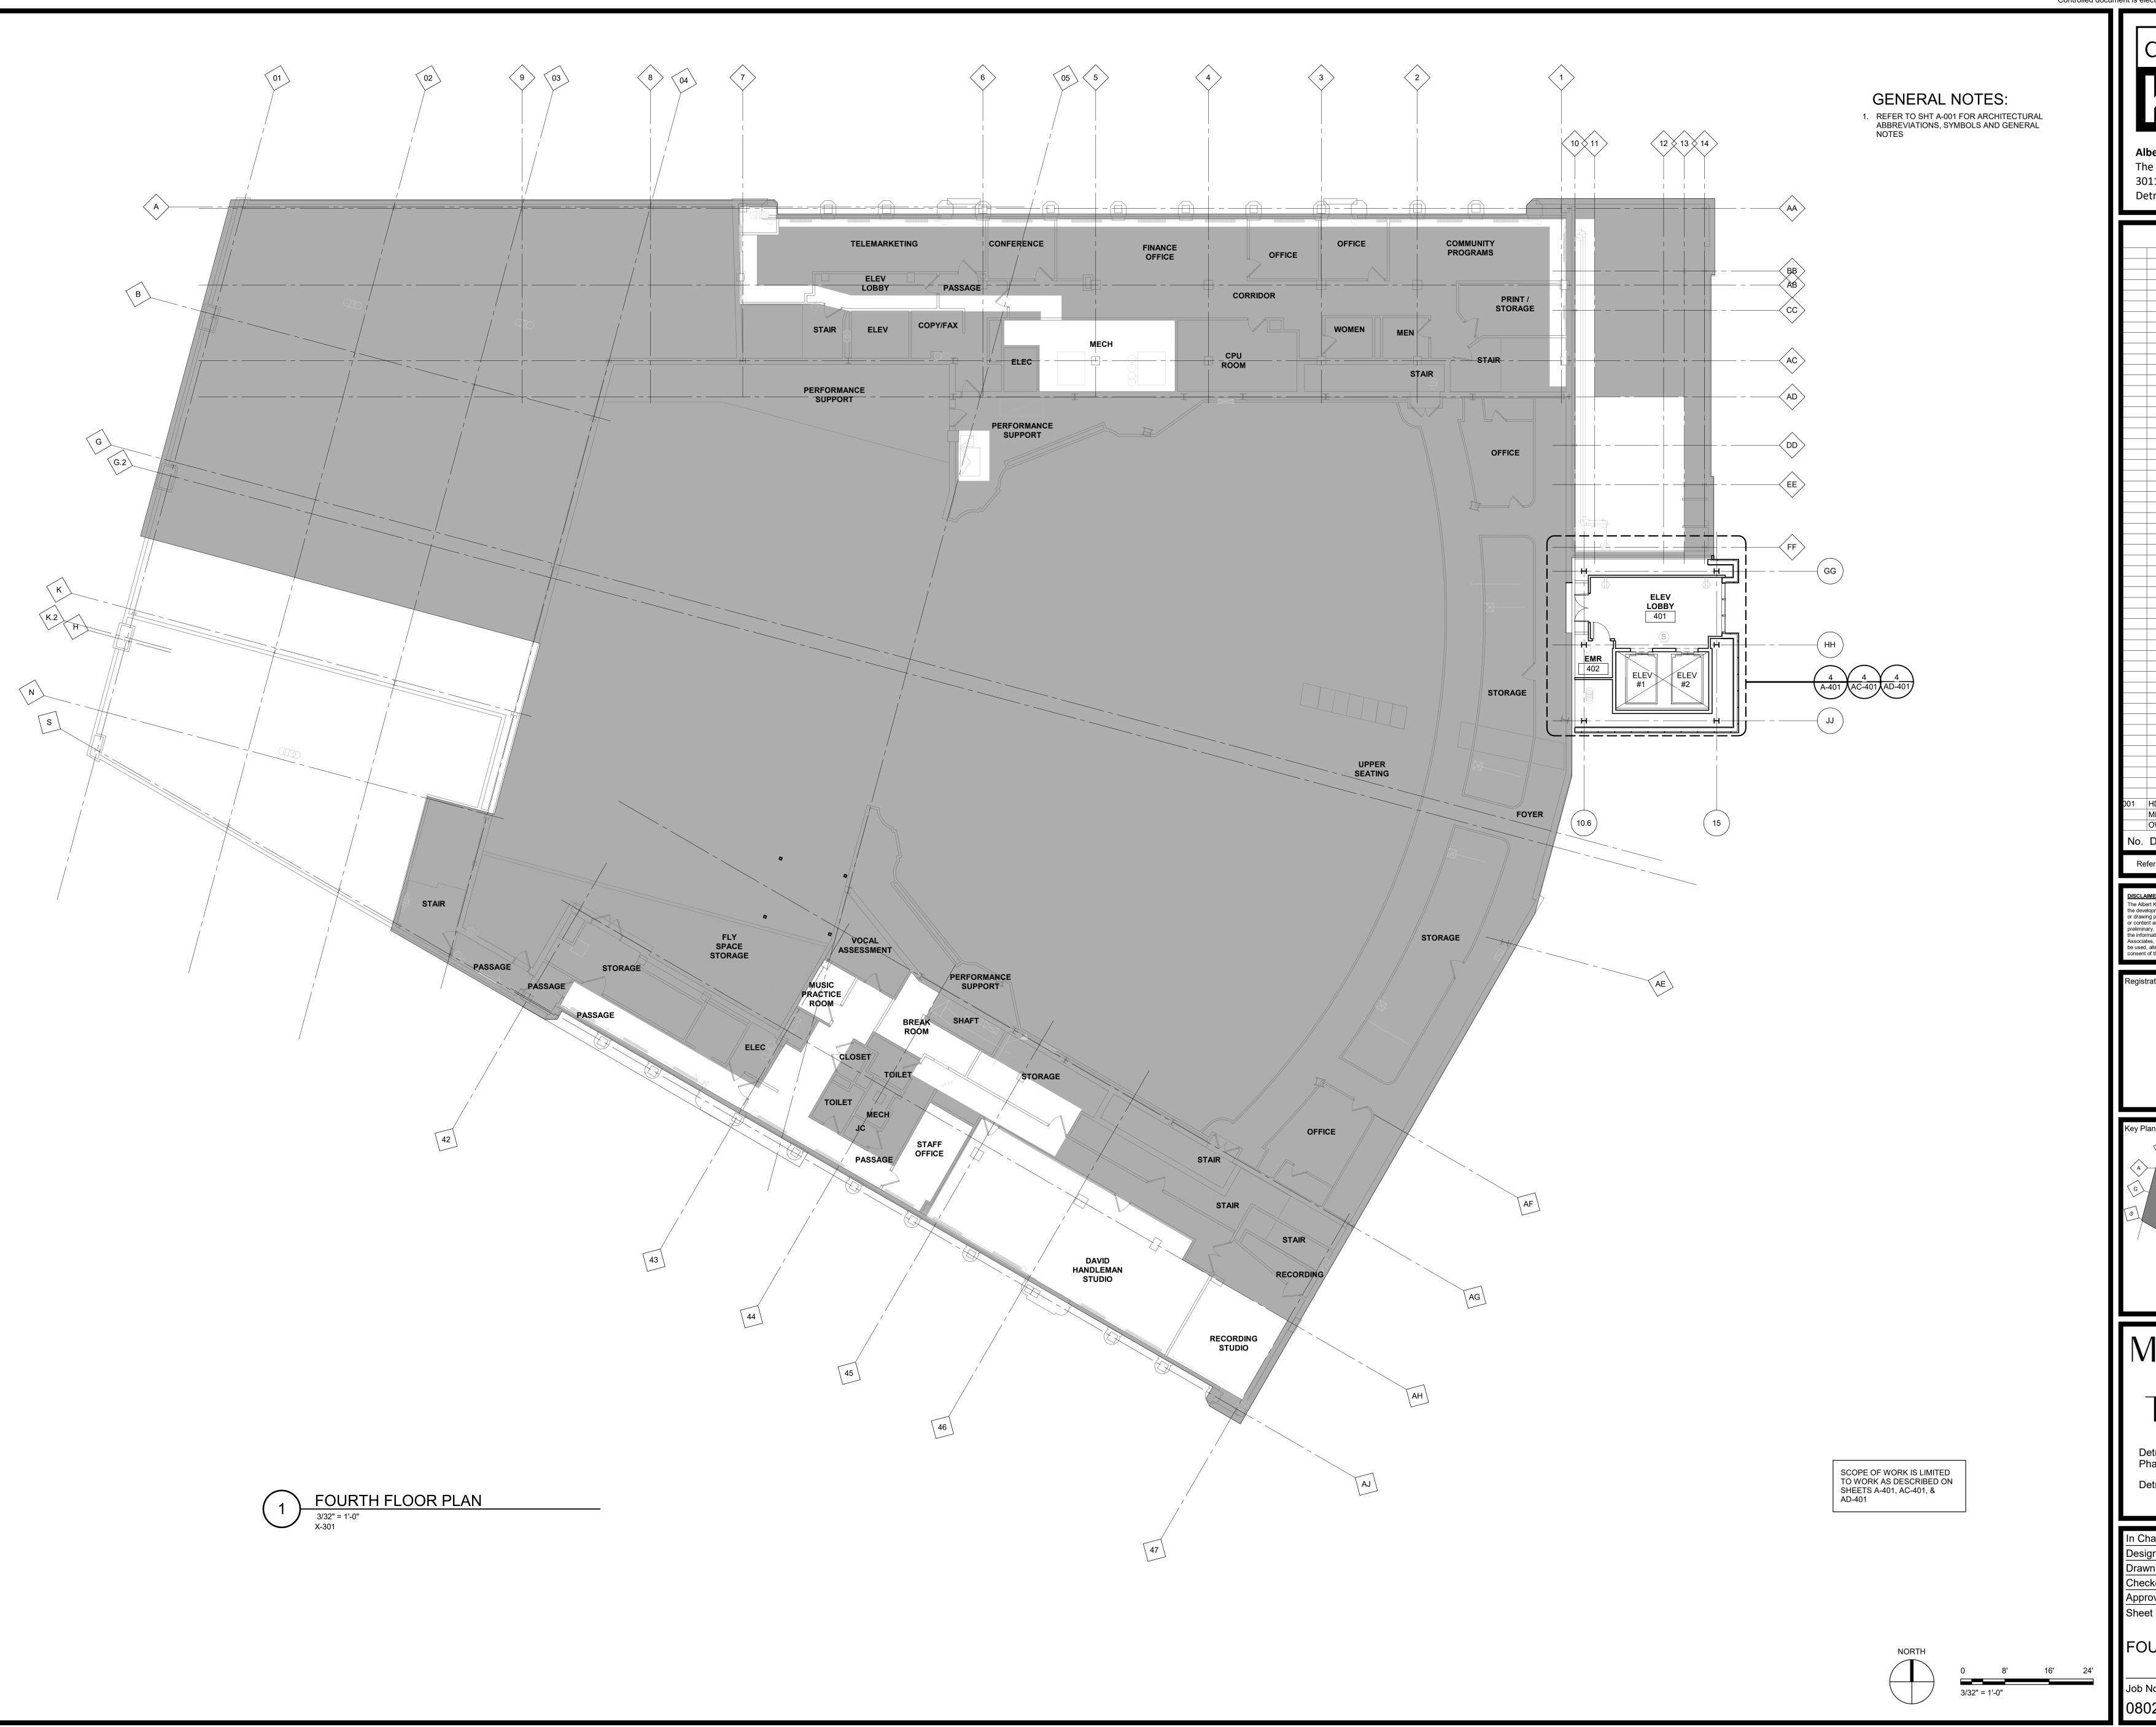




Issue History HDC REVIEW MECHANICAL BID PACKAGE OWNER REVIEW No. Description Refer To Sheet Index For Complete Issue History

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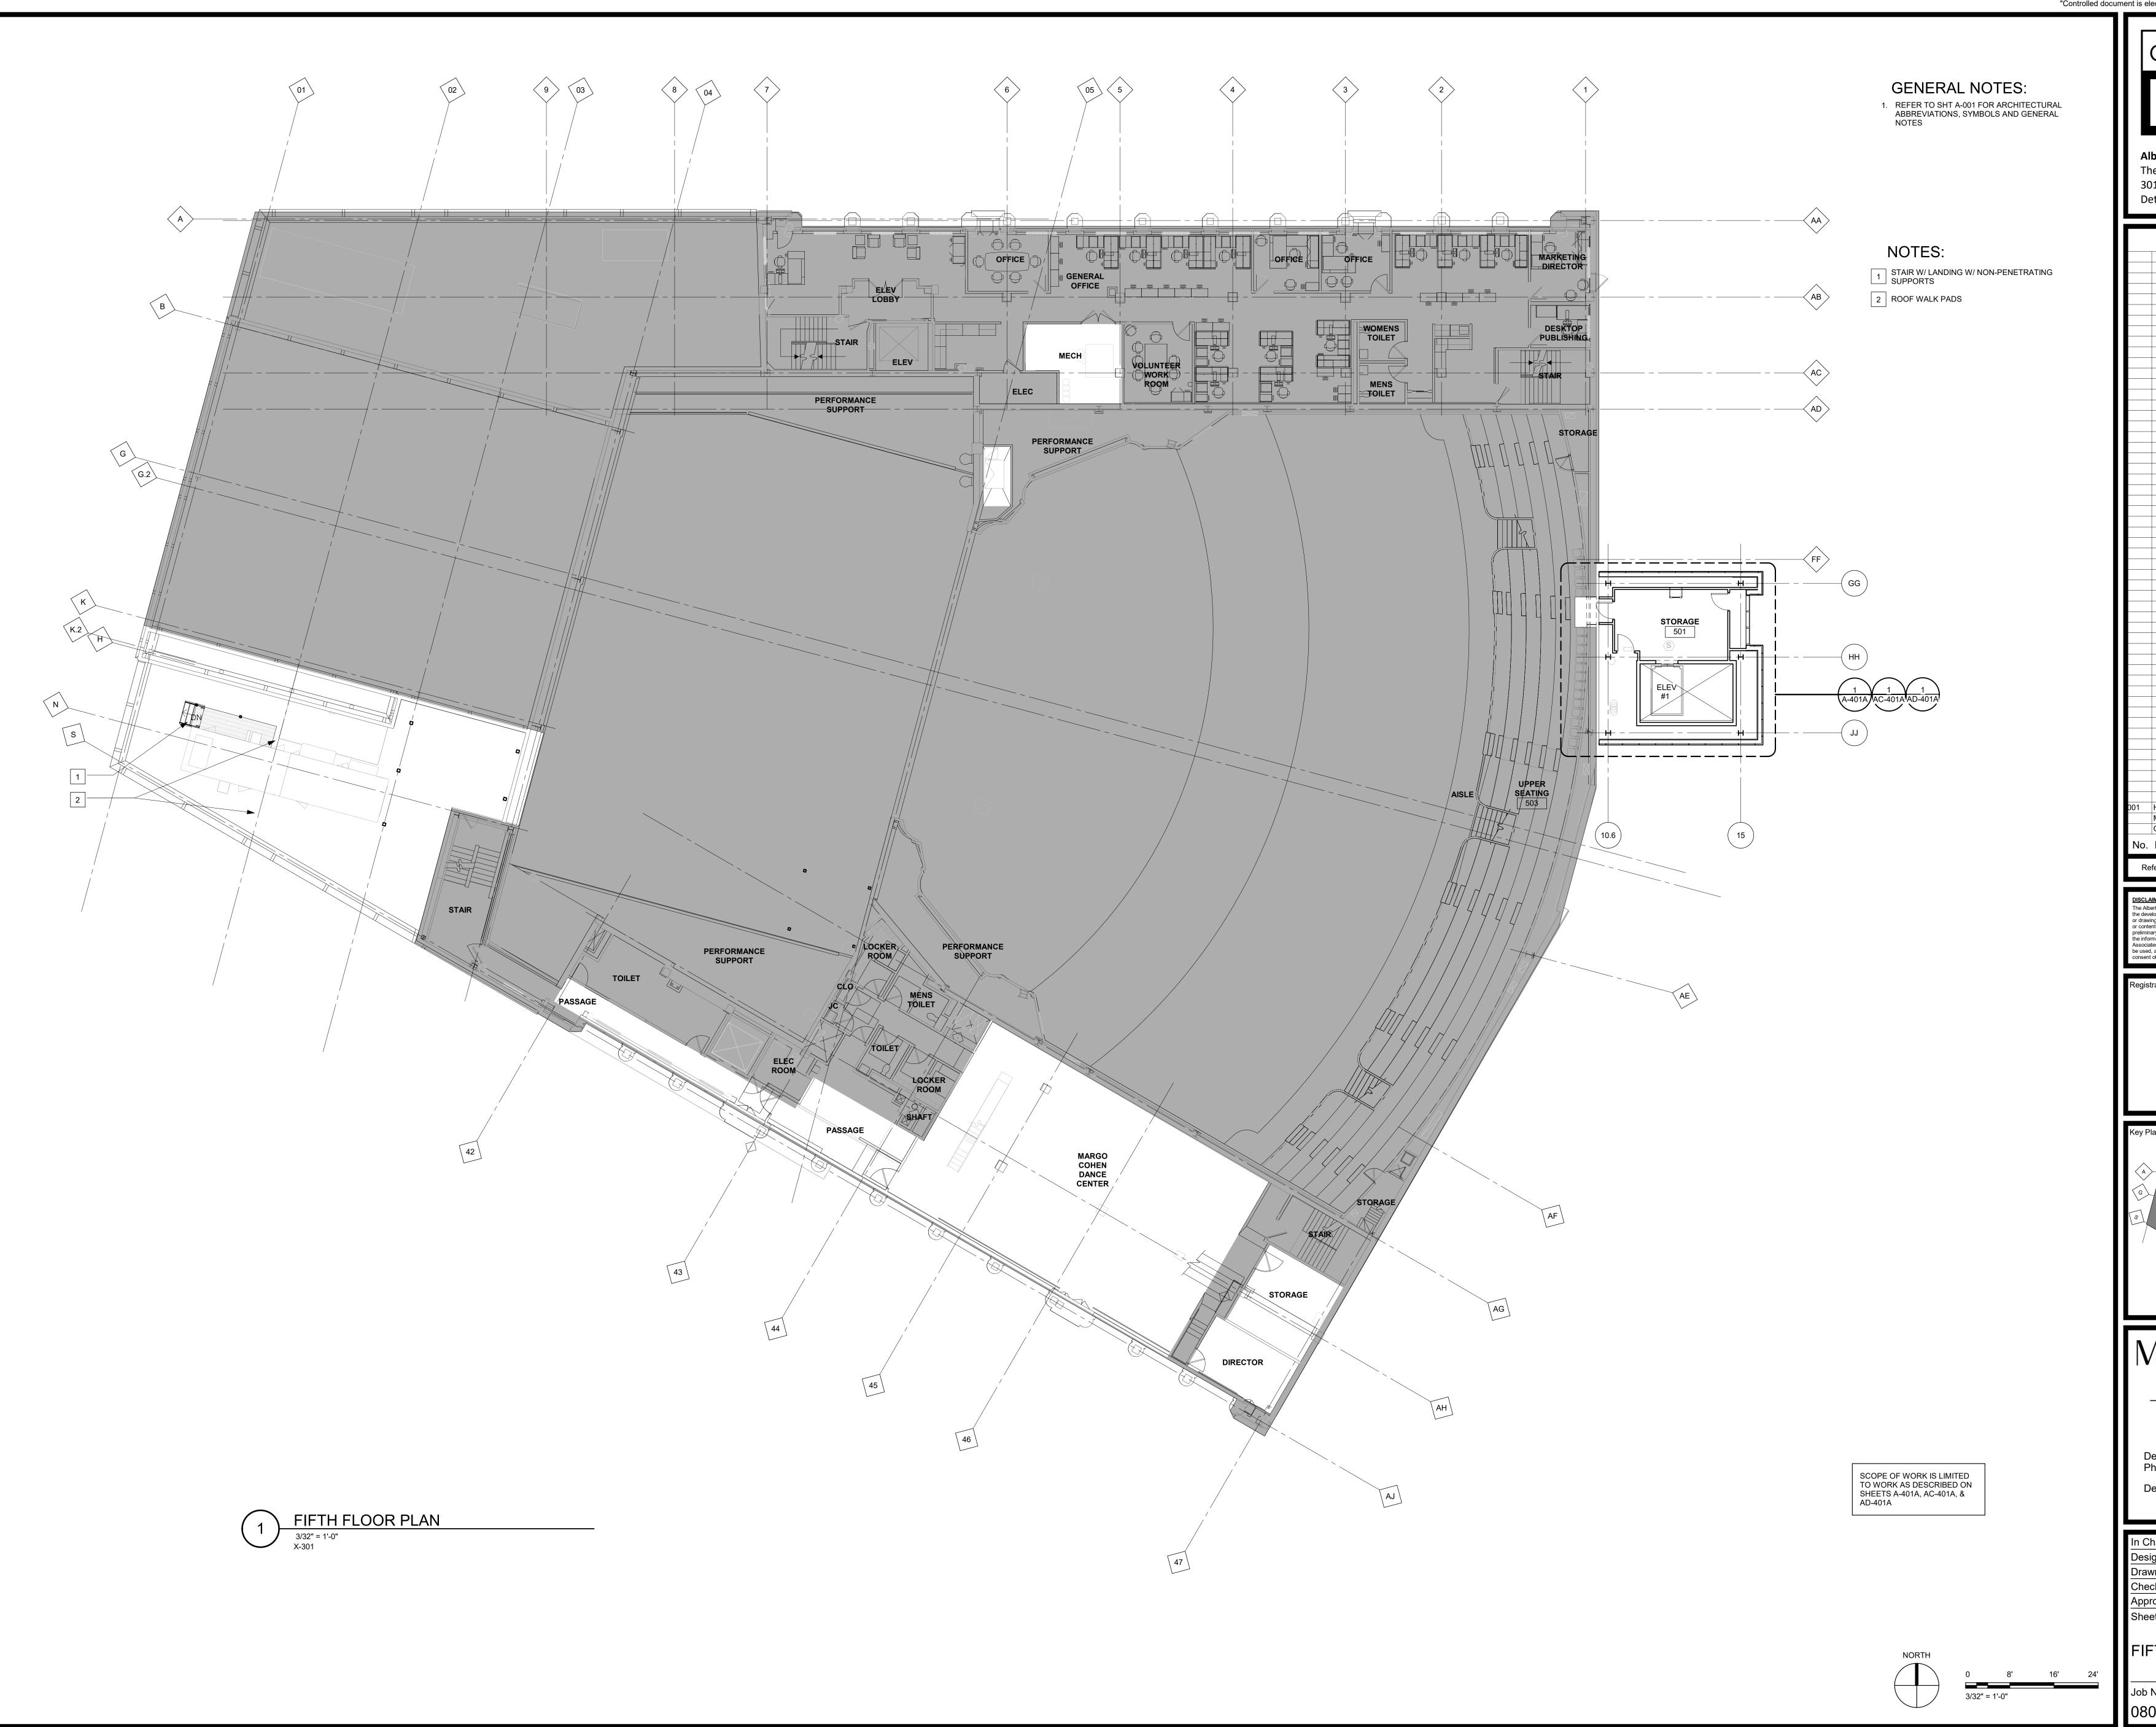


Detroit Opera House Renovation -Phase 1A

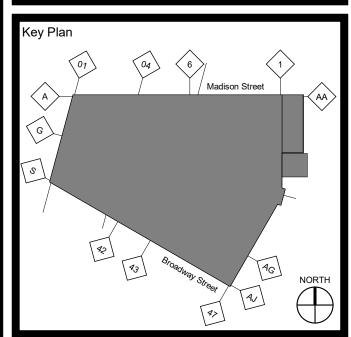In Charge Z. TOLBERT Designed ZAT
Drawn By AD Checked JK

Approved J. GAINES Date 01/20/2

FOURTH FLOOR PLAN






	Issue History	
001	HDC REVIEW	04/00/6
001	MECHANICAL BID PACKAGE	01/20/2 08/27/2
	OWNER REVIEW	03/06/2
Nο	Description	Date

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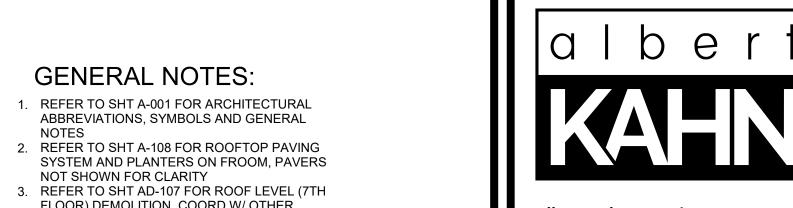
THEATRE

Detroit Opera House Renovation -Phase 1A

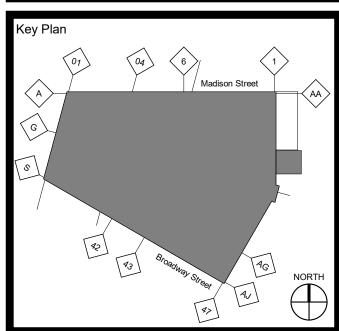In Charge Z. TOLBERT

Designed ZAT
Drawn By AD Checked JK Approved J. GAINES Date 01/20/2

FIFTH FLOOR PLAN



Issue History


	MECHANICAL BID PACKAGE	08/27/20
001	HDC REVIEW	01/20/2
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OWNER REVIEW

No. Description




Detroit Opera House Renovation -Phase 1Å


In Charge Z. TOLBER1 Designed ZAT

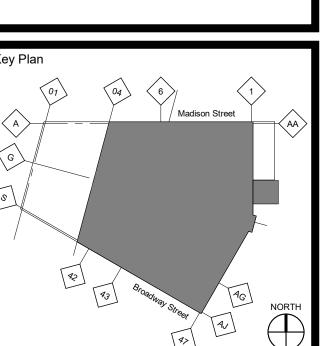Drawn By AD

Checked JK Approved J. GAINES Date 01/20/2

SEVENTH FLOOR PLAN

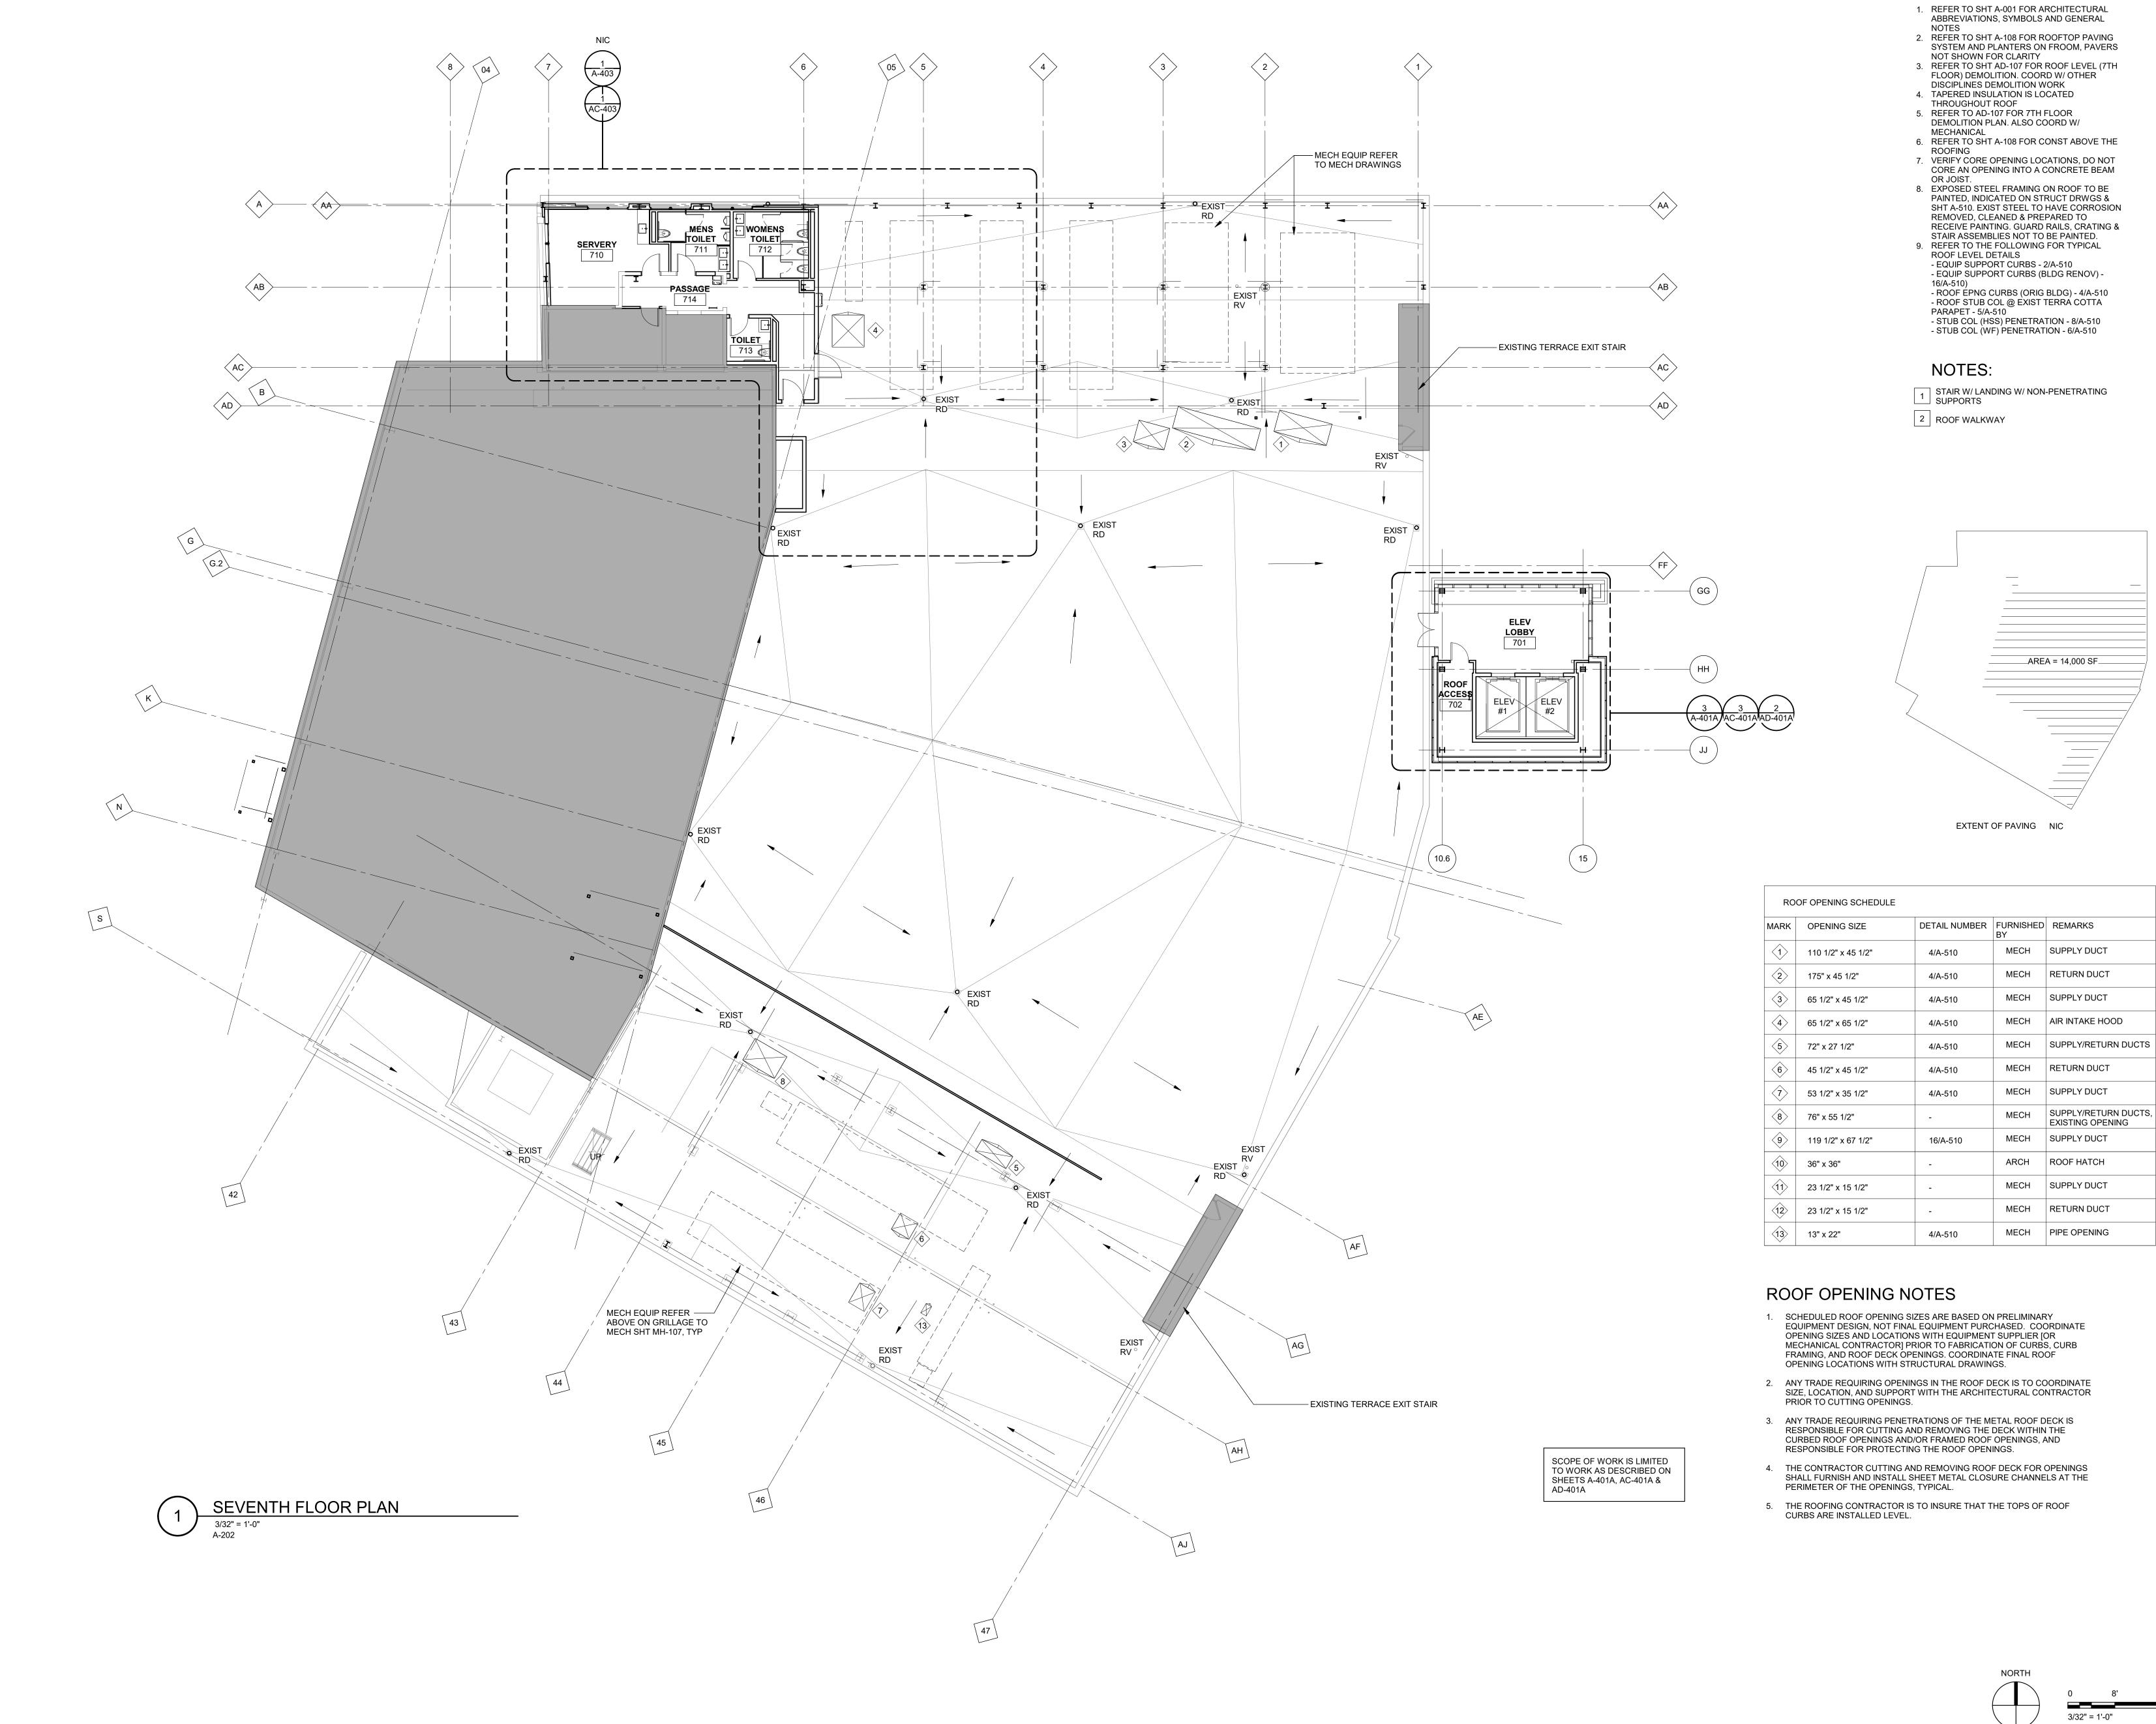

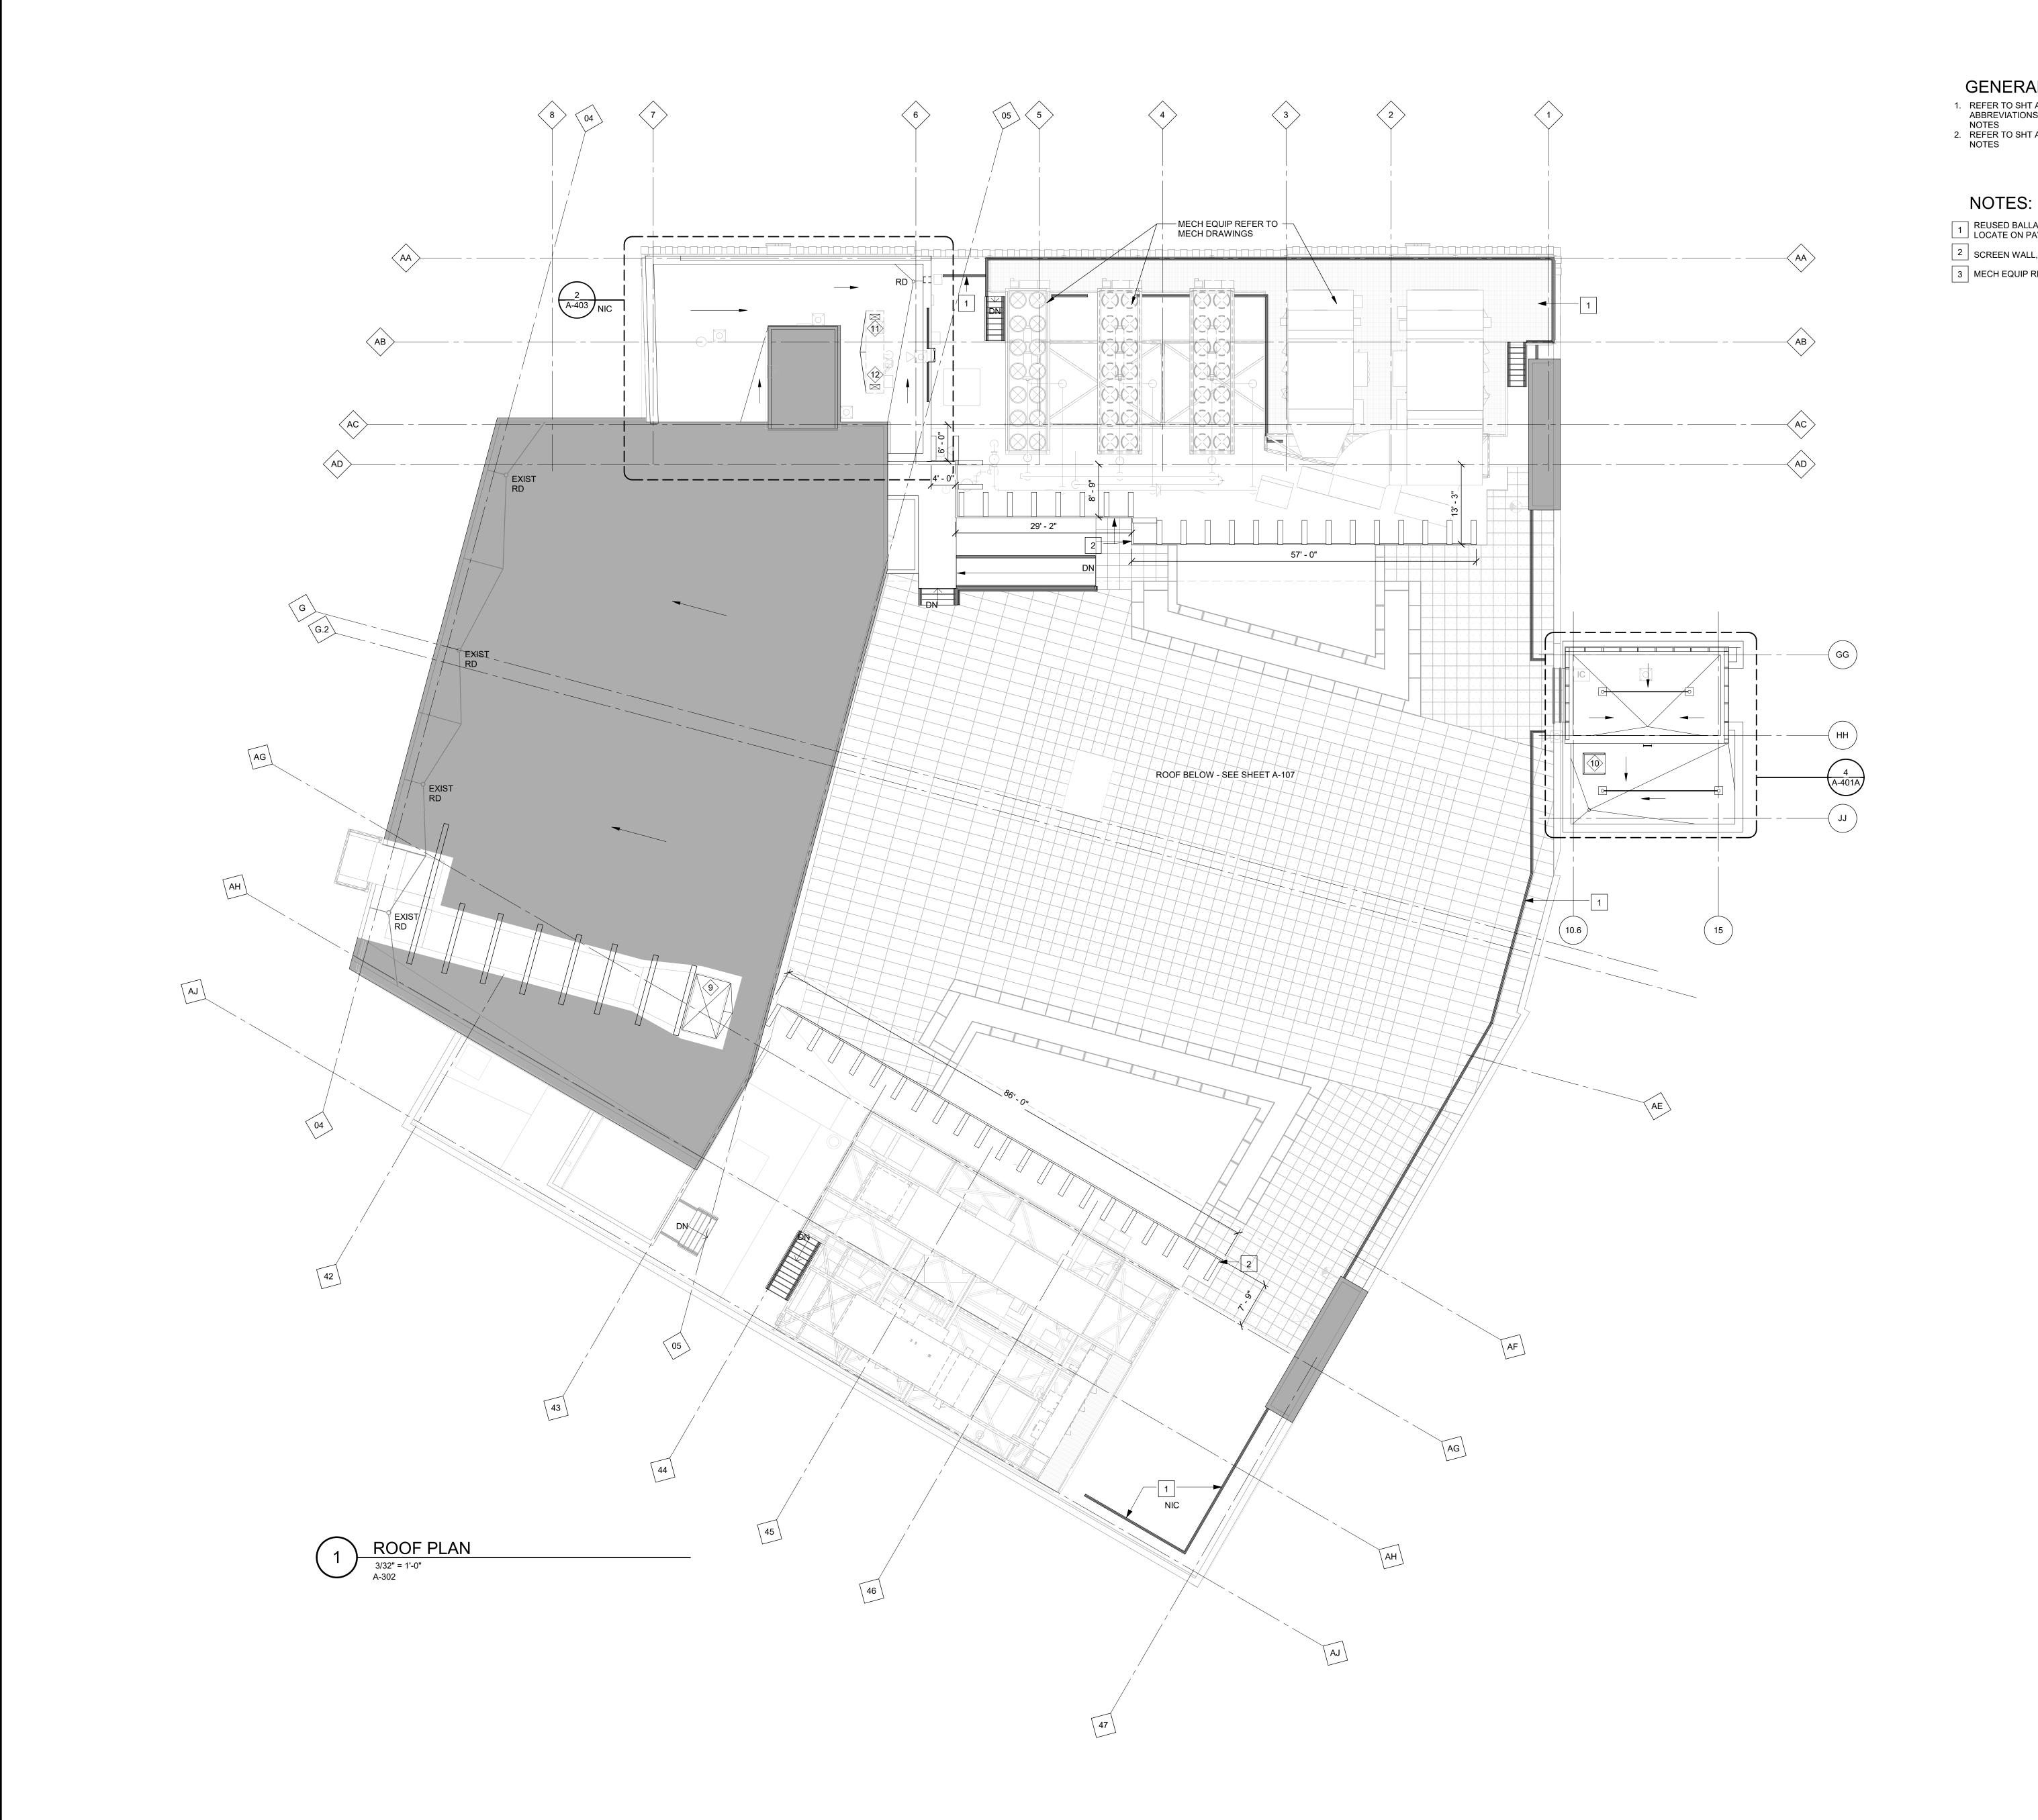

GENERAL NOTES:

- REFER TO SHT A-001 FOR ARCHITECTURAL ABBREVIATIONS, SYMBOLS AND GENERAL NOTES
 REFER TO SHT A-107 FOR ROOF OPENING NOTES


- 1 REUSED BALLASTED GUARD RAIL TYP, LOCATE ON PAVERS.
- 2 SCREEN WALL, TYP REFER TO DETAIL
- 3 MECH EQUIP REFER TO MECH SHT MH-107

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Issue History HDC REVIEW MECHANICAL BID PACKAGE OWNER REVIEW No. Description Refer To Sheet Index For Complete Issue History

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THEATRE

Detroit Opera House Renovation -Phase 1A


Designed ZAT
Drawn By AD

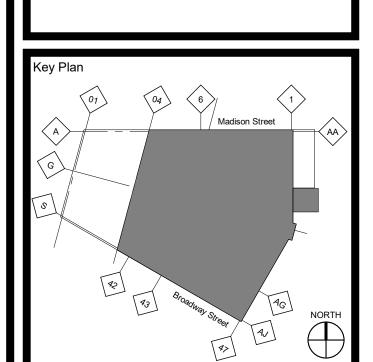SCOPE OF WORK IS LIMITED TO WORK AS DESCRIBED ON SHEETS A-401A

Checked JK Approved J. GAINES Date 01/20/2

SEVENTH FLOOR ROOF PLAN

Sheet No.

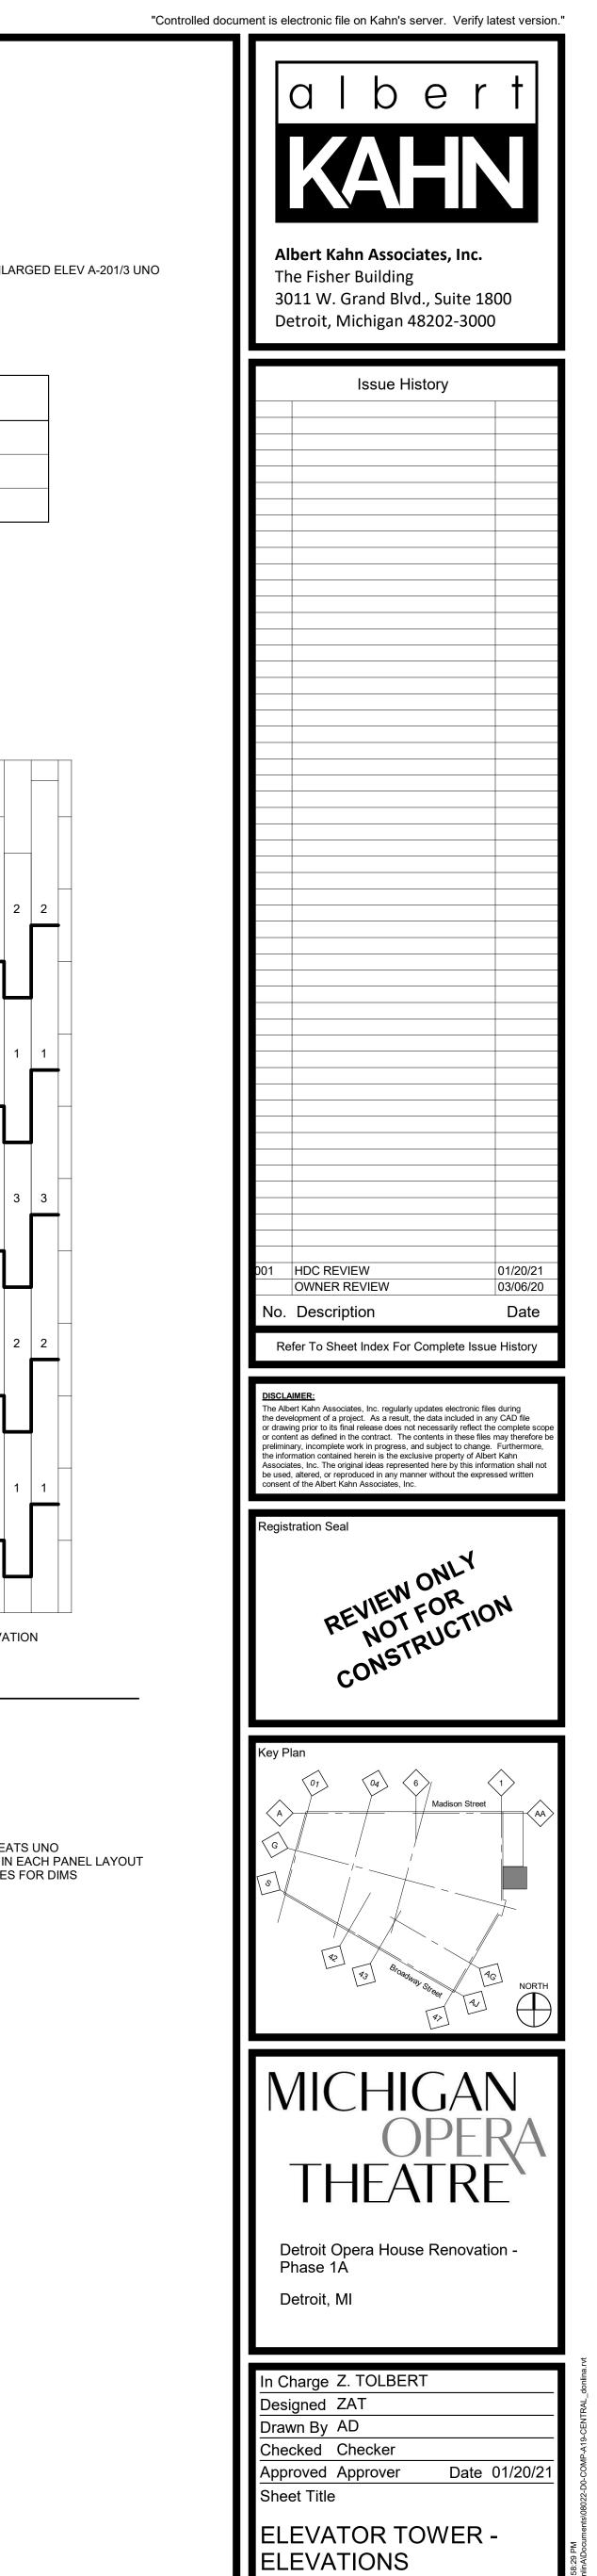

Sheet No.

A-201

08022-D0

TYPICAL PANEL LAYOUT





ELEV TOWER - EAST ELEVATION

1/4" = 1'-0"
A-401

METAL PANEL TYPES

08022-D0 A-201A

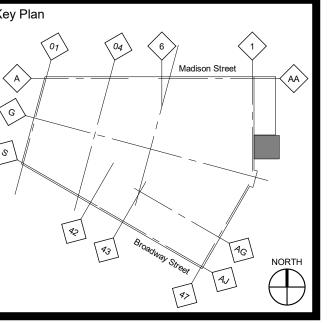

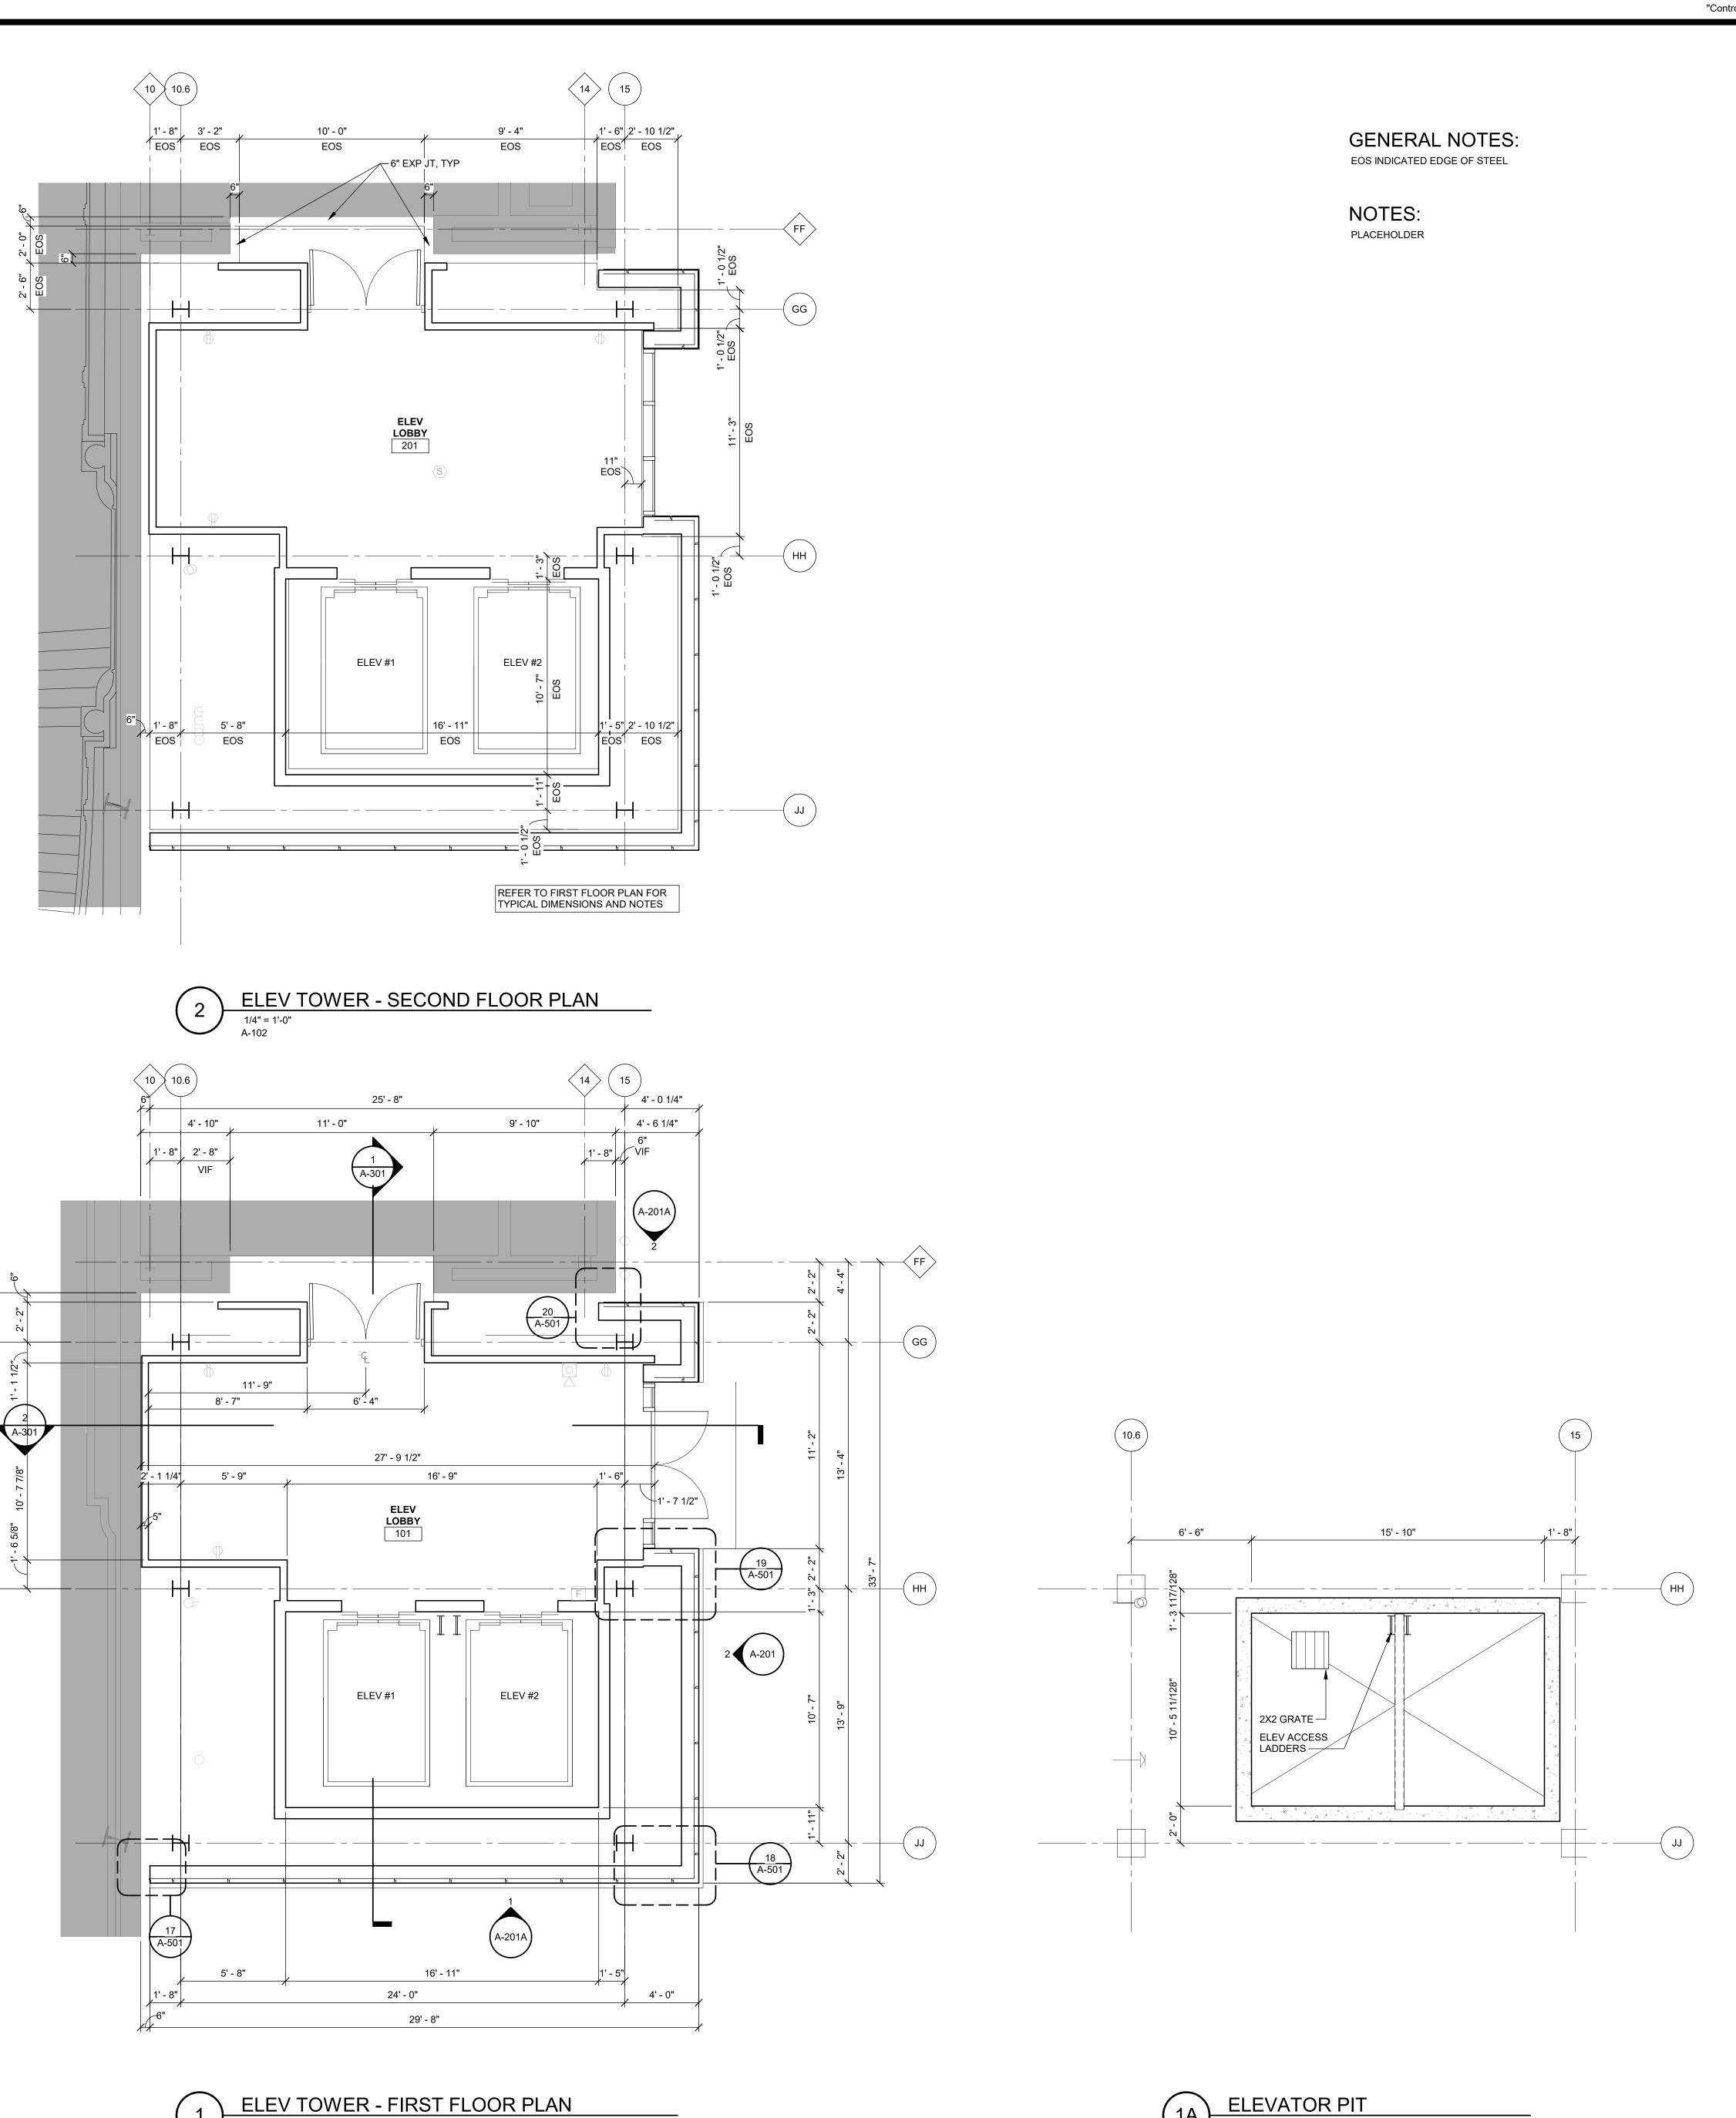

10 10.6

ELEV LOBBY 401

ELEV #2

REFER TO FIRST AND SECOND FLOOR PLANS FOR TYPICAL DIMENSIONS AND

ELEV #1

ELEV TOWER - FOURTH FLOOR PLAN

1/4" = 1'-0"
A-104

ELEV #2

REFER TO FIRST AND SECOND FLOOR PLANS FOR TYPICAL DIMENSIONS AND

ELEV #1

ELEV TOWER - THIRD FLOOR PLAN

1/4" = 1'-0"
A-103

GG

HH

HH


ELEV TOWER - FIRST FLOOR PLAN

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Issue History HDC REVIEW OWNER REVIEW No. Description Refer To Sheet Index For Complete Issue History

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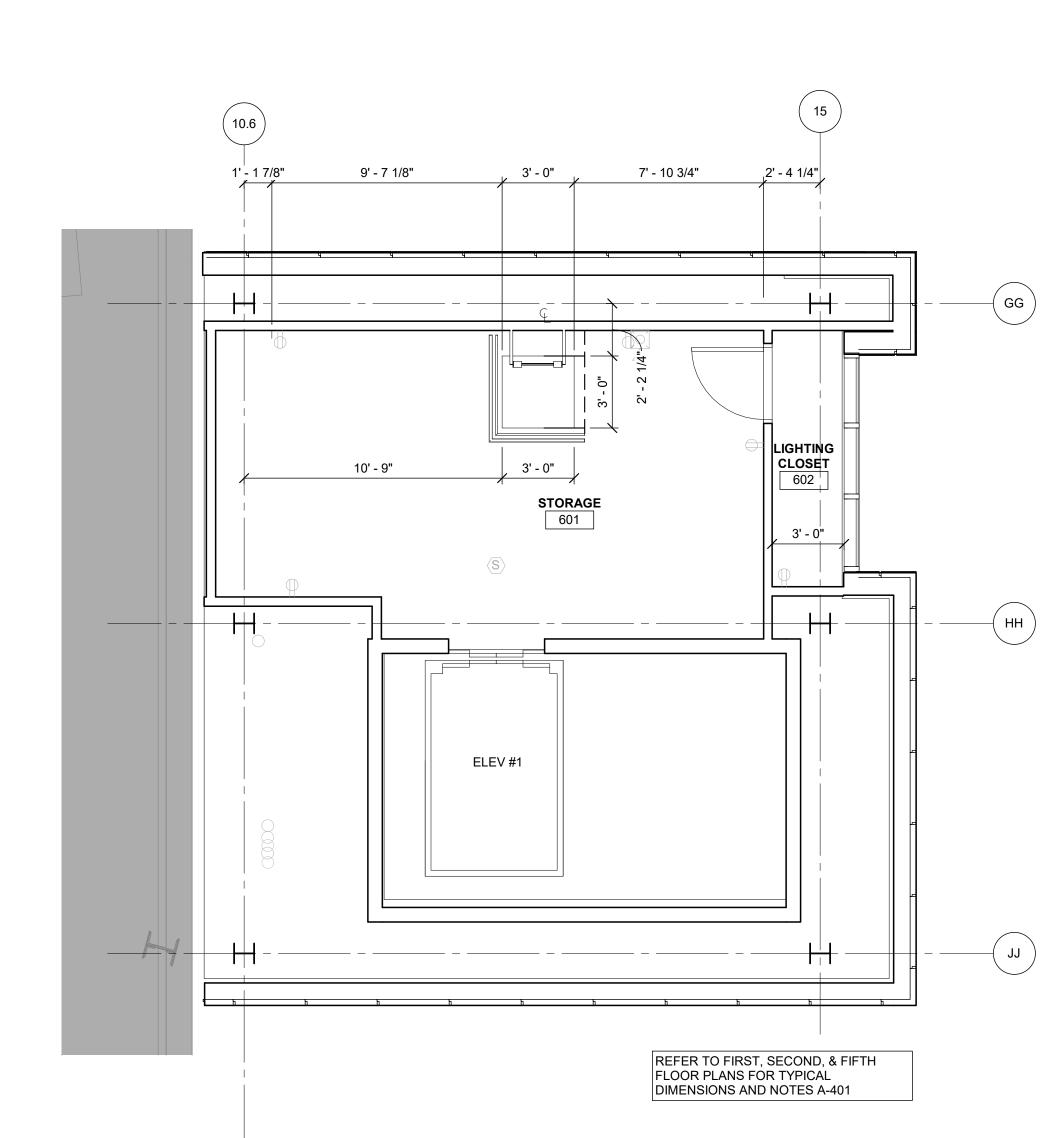
THEATRE

Detroit Opera House Renovation -Phase 1Å


In Charge Z. TOLBER1 Designed ZAT
Drawn By AD Checked Checker Approved Approver Date 01/20/2 Sheet Title

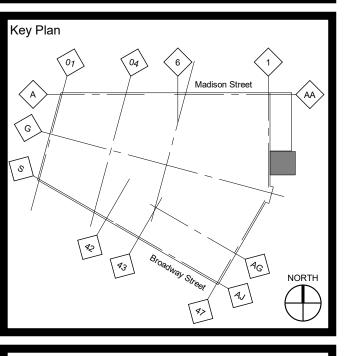ELEVATOR TOWER PLANS

08022-D0



ELEV TOWER - SIXTH FLOOR PLAN

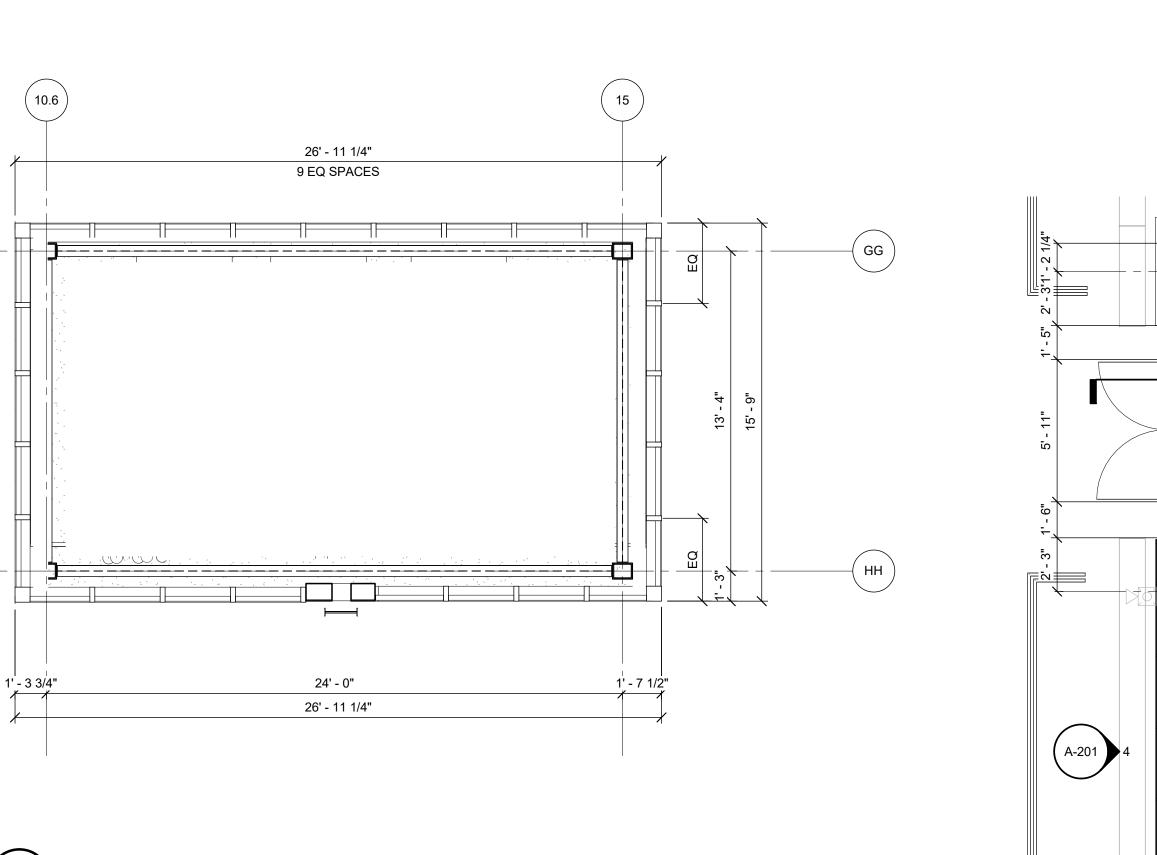

REFER TO FIRST FLOOR PLAN AND FLOOR BELOW FOR TYPICAL DIMENSIONS AND NOTES A-401

COORDINATE ANCHORS WITH STEEL FRAMING LOCATIONS


— FALL PROTECTION, TYP

ELEV TOWER - CLERESTORY PLAN
1/4" = 1'-0"

SCUPPER, TYP


ELEV TOWER - ROOF PLAN

1/4" = 1'-0"
A-108

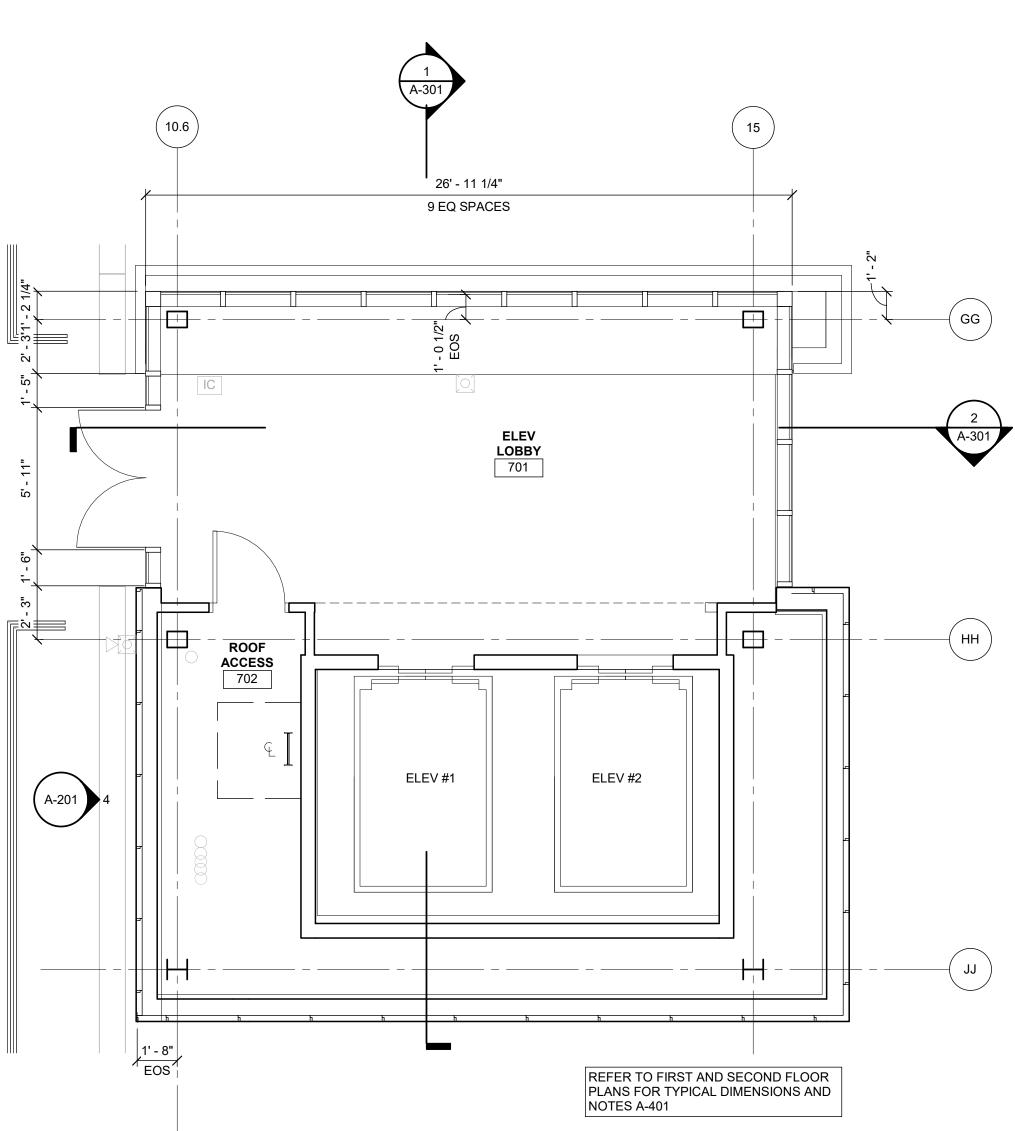

ELEV TOWER - SEVENTH FLOOR PLAN

1/4" = 1'-0"
A-107

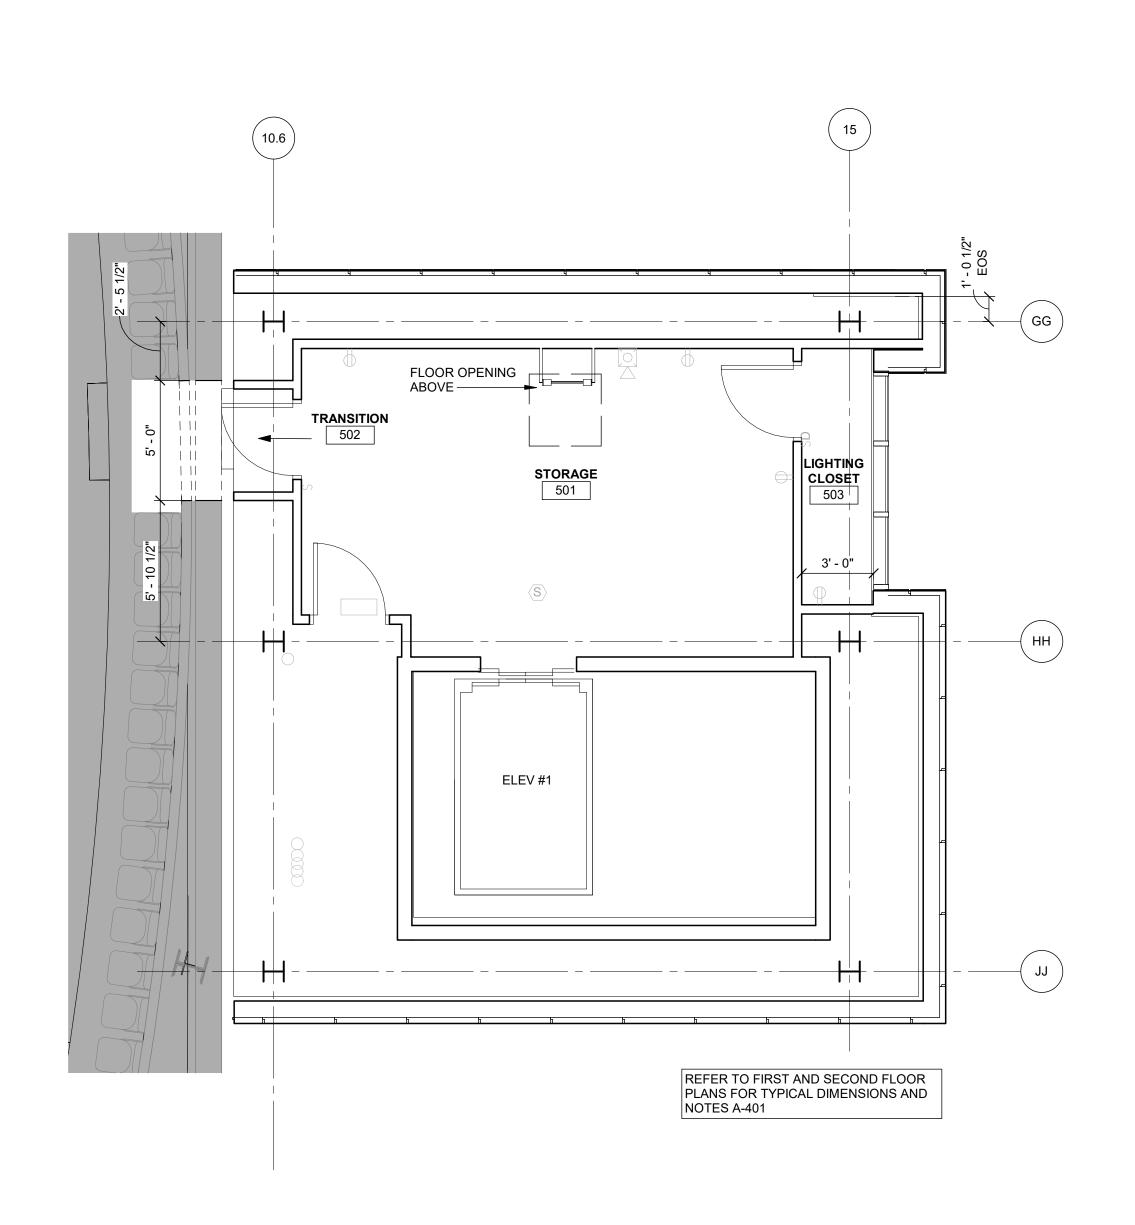

GENERAL NOTES:

PLACEHOLDER

NOTES:

PLACEHOLDER






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	Issue History	
001	HDC REVIEW	04/20/
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THEATRE Detroit Opera House Renovation -


Phase 1A

In Charge Z. TOLBERT Designed ZAT
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ELEVATOR TOWER

PLANS

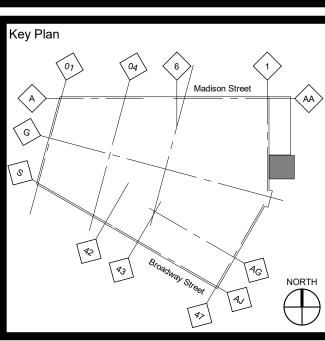A-401A

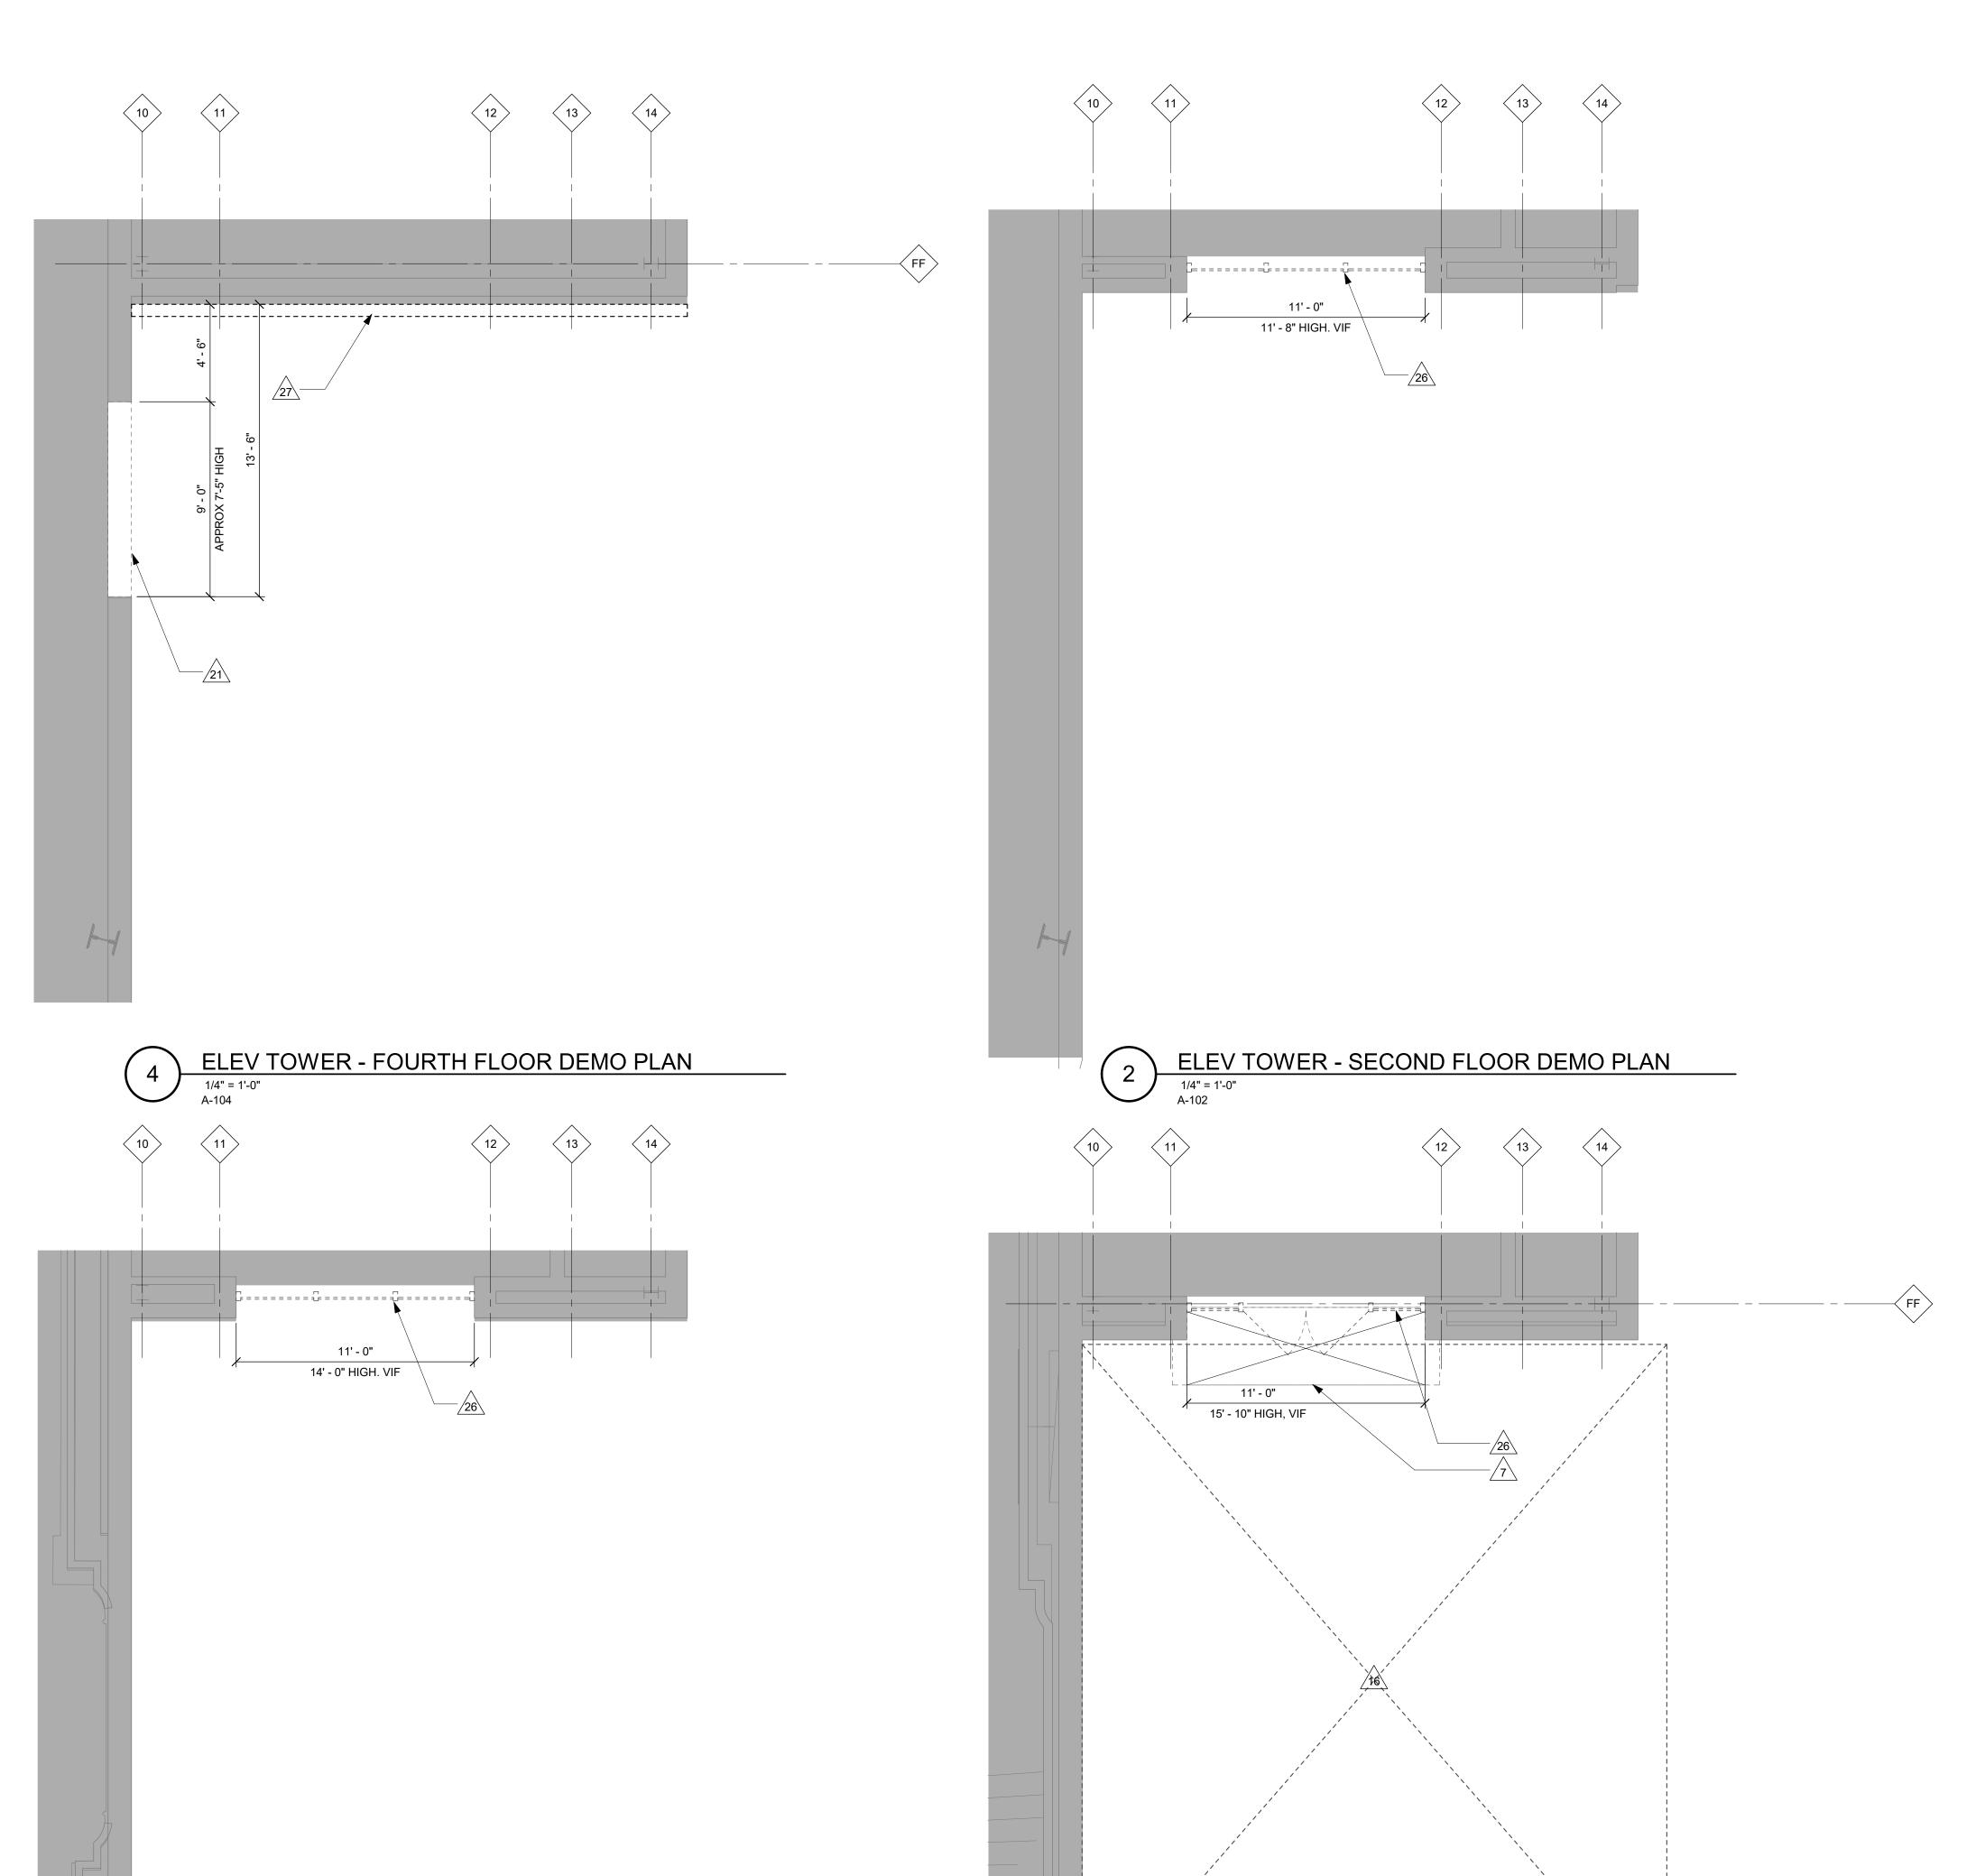

3 ELEV TOWER - THIRD FLOOR DEMO PLAN

1/4" = 1'-0"
A-103

ELEV TOWER - FIRST FLOOR DEMO PLAN

1/4" = 1'-0"
A-101

GENERAL DEMOLITION NOTES

FLOOR AND AREA TO BE DEMOLISHED.

- 1. REMOVE WALL CONSTRUCTION AND FLOOR CONSTRUCTION AS INDICATED BY DASHED LINES. ALSO REFER TO SHEET A-001 2. PROVIDE TEMPORARY BRACING AND/OR SUPPORT REQ'D TO PREVENT DAMAGE TO OR FAILURE OF EXIST STRUCTURE. 3. FIELD VERIFY EXACT LOCATION, SIZE, AND TYPE OF EXISTING UNDERGROUND UTILITIES SERVING EXISTING BUILDING. PROTECT EXISTING UTILITIES FROM DAMAGE DURING
 - CONSTRUCTION. 4. REMOVE THRESHOLDS. AT DEPRESSED THRESHOLDS AND
- FLOOR TRANSITIONS. 5. FURNISH AND INSTALL FULL HT SMOKE TIGHT/SOUND CONTROL TEMPORARY PARTITIONS TO SEPARATE CONSTRUCTION FROM OCCUPIED AREAS. SEE PARTITION TYPE T1 ON AD-101. CONTRACTOR TO BUILD TYPE T1 PRTN WITH SHAFT WALL
- CONSTRUCTION WHEN ACCESS TO DEMO SIDE OF PLAN IS LIMITED. CONTRACTOR TO PROVIDE DOOR IN TEMP PRTN FOR 6. NOT ALL CONDITIONS DESCRIBED IN THE FOLLOWING DEMOLITION NOTES OCCUR IN EACH AREA OF THE DEMOLTION.

FIELD VERIFY EXISTING CONDITIONS AND MATERIALS OF EACH

- 7. DEMOLITION PLANS REPRESENT APPROXIMATE LOCATION OF EXISTING WALLS TO BE DEMOLISHED. FIELD VERIFY TYPE OF CONSTRUCTION AND HEIGHT OF WALLS. PLANS DO NOT NECESSARILY INDICATE ALL DEMO WALLS, COUNTERS, CLOSETS, SINKS ETC. PRIOR TO DEMOLITION, FIELD VERIFY THAT WALLS TO BE REMOVED DO NOT PROVIDE SUPPORT FOR EXISTING BUILDING ELEMENTS AND EXISTING CONSTRUCTION TO REMAIN. NOTIFY A/E IF DEMOLITION WALLS SUPPORT EXITING BUILDING ELEMENTS.
- 8. REMOVE ALL WALL COVERINGS ON EXISTING WALLS TO REMAIN THAT FACE ARES OF DEMOLITION. REMOVAL SHALL INCLUDE ANY RESIDUAL MATERIAL AFTER DEMOTION, I.E. PIECES OF WALL COVERING OR BACKING. REMOVAL OF WALL COVERINGS IS TO BE DONE W/O DAMAGING THE EXISTING WALL SURFACE TO
- 9. FIELD VERIFY THE PRESENCE OF MECHANICAL AND ELECTRICAL, PIPES, CONDUIT, ETC. IN ALL WALLS TO BE DEMOLISHED.
- 10. VERIFY WITH CONSTRUCTION MANAGER TECHNICAL REPRESENTATIVE TO ACCESS THE DEMOLITION AREA, INGRESS AND EGRESS ROUTES FOR MATERIAL AND EQUIPMENT. 11. PROTECT EXISTING ELEVATOR CABS FROM DAMAGE TO FLOOR,
- WALLS AND CEILINGS 12. PROTECT EXISTING FLOORS, WALLS AND CORNERS TO REMAIN ALONG WORK ACCESS ROUTES 13. CONTAIN DUST AND DEBRIS WITHIN THE DEMOLITION AREA 14. DEMOLISH AND REMOVE CARPET, PAD, TACK STRIP, AND VINYL
- TILE. REMOVE ALL FLOOR MATERIALS INCLUSIVE OF SETTING BEDS, SUBFLOOR MATERIAL ETC. REMOVE MASTIC TO PROVIDE A CLEAN FLOOR THAT IS ACCEPTABLE TO THE SUBCONTRACTOR INSTALLING NEW FINISH MATERIAL. 15. DEMOLISH AND REMOVE DOORS, VINYL BASE, CONDUIT, WIRING, CONVECTOR COVERS WITH SUPPORT FRAMING, DUPLEXES,

TELEPHONE OUTLETS, CABLES, SHELVING, METAL STUD AND GYPSUM BOARD WALLS, CLOSETS, CABINETS, FILES, COUNTERS,

- WOOD MOLDING, SHELVES AND ENCLOSURES WHERE APPLICABLE. 16. DEMOLISH AND REMOVE SUSPENDED ACOUSTIC LAY-IN OR SPLINE CEILING INCLUSIVE OF HANGERS AND CARRYING CHANNELS, WIRES, CABLES, CONDUIT, ADHERED CEILING TILES, FLEX CONDUIT, ELECTRICAL BOXES, SMOKE DETECTORS, LIGHT
- FIXTURES AND WIRING, DUCT WORK, PIPING AND SUPPORT HANGERS. CUT HANGERS FLUSH. 17. CONTRACTOR SHALL ASSIST IN COORDINATING THE IDENTIFICATION OF UTILITES TO REMAIN. 18. DEMOLITION FOR THE FLOOR AREAS SHALL ENCOMPASS THE
- SPACE FROM THE TOP OF THE CONCRETE FLOOR TO THE UNDERSIDE OF THE EXISTING INTERSTITIAL STRUCTURE ABOVE UNLESS NOTED OTHERWISE. 19. ALL DEMOLITION MATERIALS AND DEBRIS SHALL BE DISPOSED OF ACCORDING TO FEDERAL, STATE AND LOCAL REGULATIONS 20. CONTRACTOR SHALL PERFORM WORK IN A MANNER THAT DOES
- COMPRISE THE STRUCTURAL INTEGRITY OF ANY WALLS, FLOORS, VEILINGS, SUPPORTS, STRUCTURE, ETC TO REMAIN. 21. AT LOCATIONS WHERE EXISTING WALLS ARE TO BE REMOVED NEAR EXISTING WALLS TO REAMIN, PERFORM DEMOLTION WITHOUT DISTURBING EXISTING ELEMENTS TO REMAIN. WALLS TO REMAIN SHALL BE INTACT AND HAVE A NEAT SURFACE WITH

NOT DAMAGE THE EXITNG STRUCTURE. DEMOLITION SHALL NOT

NO PROJECTIONS GREATER THAT 1/2" FROM THE FACE OF WALL

DEMOLITION KEYNOTES

22. REMOVE EXISTING ROOF CURB REFER TO MECH DWGS

- 1 REMOVE BOTTOM PORTION OF WALL
- REMOVE EXISTING PIPE
- REMOVE EXISTING LOUVER
- REMOVE EXIST STRUCTURAL SUPPORT AND ASSOCIATED CATWALK
- REMOVE EXIST PAVERS, GRAVEL, ROOFING, INSULATION, AND CINDER FILL TO STRUCTURAL SLAB
- REMOVE EXIST PARAPET
- REMOVE EXIST SLAB AND FOUNDATION
- REMOVE EXIST DOOR
- REMOVE EXTERIOR DOOR HANDLE, AND REWORK DOOR
- REMOVE SCREEN WALL
- REMOVE STORAGE ENCLOSURE
- REMOVE BLEACHERS
- REMOVE PORTION OF CEILING AS REQUIRED TO COMPLETE NEW WORK
- REMOVE EXISTING GUARD RAIL, SALVAGE FOR REUSE
- 15 "NOT USED"
- REMOVE EXIST PAVEMENT
- REMOVE PORTABLE RESTROOMS AND ASSOCIATED PIPING, REFER TO MECH
- "NOT USED"
- REMOVE EXISTING ROOF CURB REFER TO MECH DWGS
- "NOT USED"
- MAS WALL AND SILL AT DOOR TO BE REMOVED TO 21 CONC SLAB BELOW
- DISASSEMBLE EXISTING FENCE, SALVAGE FOR REUSE
- REMOVE EXISTING RAMP, PLATFORM, AND/OR STAIR
- REMOVE EXIST SEATING
- REMOVE EXISTING LADDER, SALVAGE FOR REUSE
- REMOVE EXIST GLAZED CUTAIN WALL
- REMOVE TOP PORTION OF EXISTING MAS WALL PARAPET


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Detroit Opera House Renovation -Phase 1Å


In Charge Z. TOLBER1 Designed ZAT


Drawn By AD Checked Checker Approved Approver Date 01/20/2

Sheet Title **ELEVATOR TOWER**

08022-D0

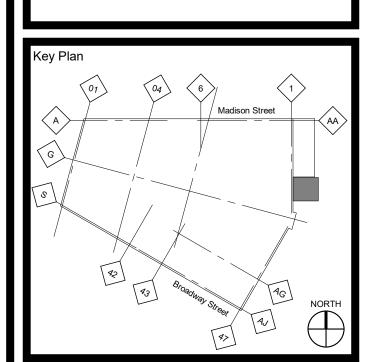
DEMO PLAN

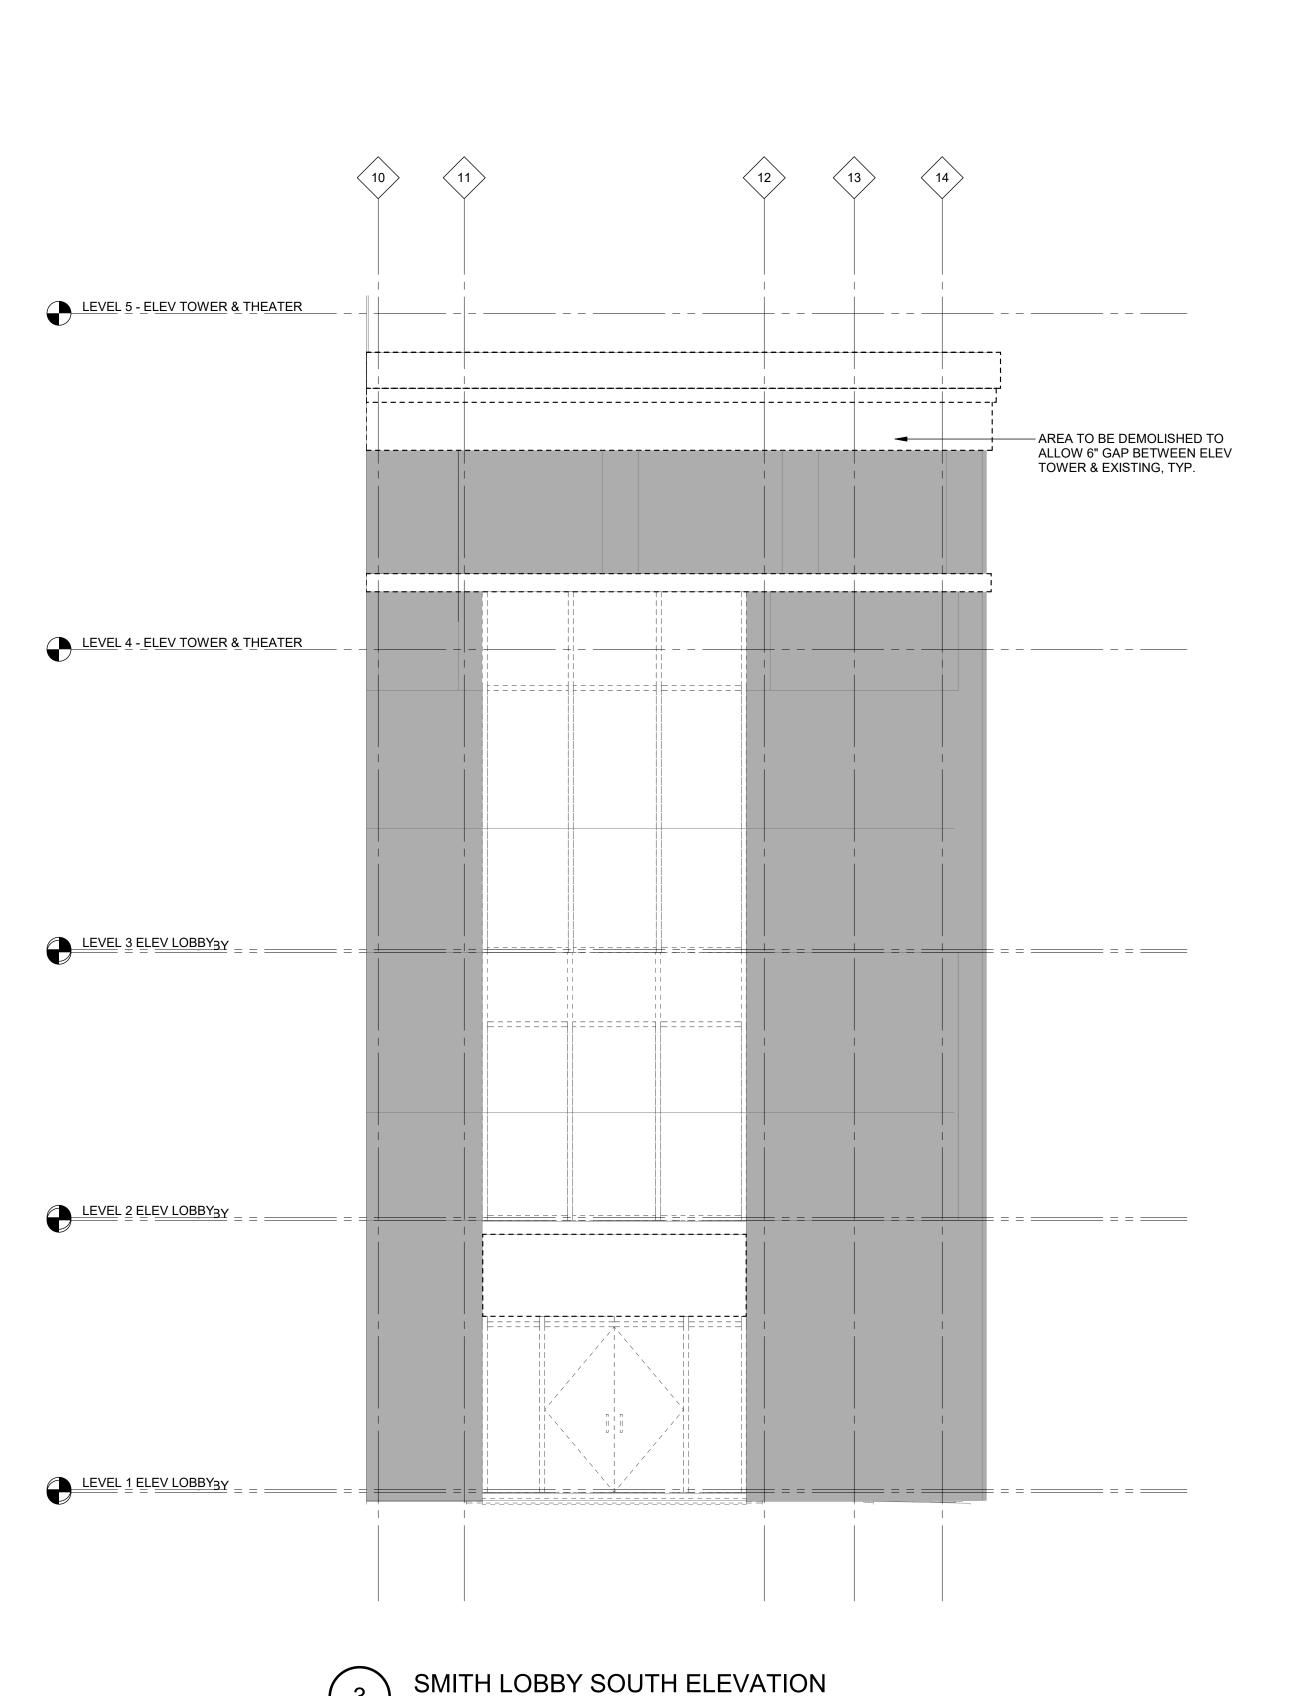

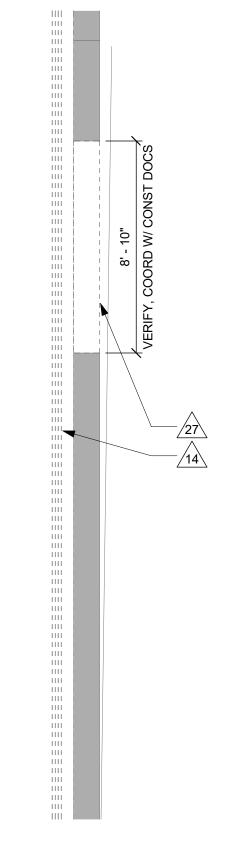

2 ELEV TOWER - SEVENTH FLOOR DEMO PLAN

1/4" = 1'-0"

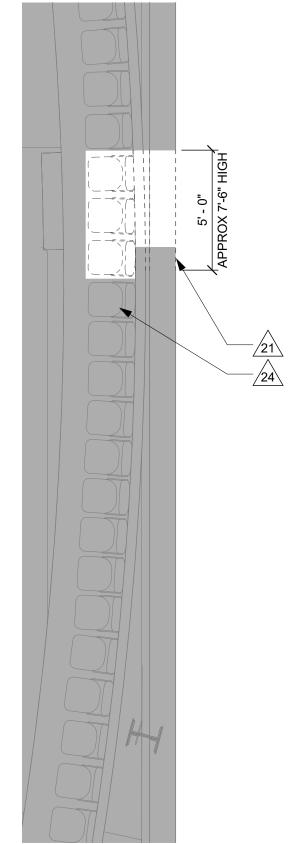

1) ELEV TOWER - FIFTH FLOOR DEMO PLAN

1/4" = 1'-0"

GENERAL DEMOLITION NOTES

- REMOVE WALL CONSTRUCTION AND FLOOR CONSTRUCTION AS INDICATED BY DASHED LINES. ALSO REFER TO SHEET A-001
 PROVIDE TEMPORARY BRACING AND/OR SUPPORT REQ'D TO PREVENT DAMAGE TO OR FAILURE OF EXIST STRUCTURE.
 FIELD VERIFY EXACT LOCATION, SIZE, AND TYPE OF EXISTING UNDERGROUND UTILITIES SERVING EXISTING BUILDING. PROTECT EXISTING UTILITIES FROM DAMAGE DURING
- CONSTRUCTION.
 4. REMOVE THRESHOLDS. AT DEPRESSED THRESHOLDS AND FLOOR TRANSITIONS.
 5. FURNISH AND INSTALL FULL HT SMOKE TIGHT/SOUND CONTROL TEMPORARY PARTITIONS TO SEPARATE CONSTRUCTION FROM OCCUPIED AREAS. SEE PARTITION TYPE T1 ON AD-101. CONTRACTOR TO BUILD TYPE T1 PRTN WITH SHAFT WALL CONSTRUCTION WHEN ACCESS TO DEMO SIDE OF PLAN IS LIMITED. CONTRACTOR TO PROVIDE DOOR IN TEMP PRTN FOR ACCESS.

6. NOT ALL CONDITIONS DESCRIBED IN THE FOLLOWING

- DEMOLITION NOTES OCCUR IN EACH AREA OF THE DEMOLTION.
 FIELD VERIFY EXISTING CONDITIONS AND MATERIALS OF EACH
 FLOOR AND AREA TO BE DEMOLISHED.

 7. DEMOLITION PLANS REPRESENT APPROXIMATE LOCATION OF
 EXISTING WALLS TO BE DEMOLISHED. FIELD VERIFY TYPE OF
 CONSTRUCTION AND HEIGHT OF WALLS. PLANS DO NOT
 NECESSARILY INDICATE ALL DEMO WALLS, COUNTERS,
 CLOSETS, SINKS ETC. PRIOR TO DEMOLITION, FIELD VERIFY THAT
 WALLS TO BE REMOVED DO NOT PROVIDE SUPPORT FOR
 EXISTING BUILDING ELEMENTS AND EXISTING CONSTRUCTION TO
 REMAIN. NOTIFY A/E IF DEMOLITION WALLS SUPPORT EXITING
 BUILDING ELEMENTS.

 8. REMOVE ALL WALL COVERINGS ON EXISTING WALLS TO REMAIN
- REMOVE ALL WALL COVERINGS ON EXISTING WALLS TO REMAIN THAT FACE ARES OF DEMOLITION. REMOVAL SHALL INCLUDE ANY RESIDUAL MATERIAL AFTER DEMOTION, I.E. PIECES OF WALL COVERING OR BACKING. REMOVAL OF WALL COVERINGS IS TO BE DONE W/O DAMAGING THE EXISTING WALL SURFACE TO REMAIN.
 FIELD VERIFY THE PRESENCE OF MECHANICAL AND ELECTRICAL,
- PIPES, CONDUIT, ETC. IN ALL WALLS TO BE DEMOLISHED.

 10. VERIFY WITH CONSTRUCTION MANAGER TECHNICAL
 REPRESENTATIVE TO ACCESS THE DEMOLITION AREA, INGRESS
 AND EGRESS ROUTES FOR MATERIAL AND EQUIPMENT.

 11. PROTECT EXISTING ELEVATOR CABS FROM DAMAGE TO FLOOR,
 WALLS AND CEILINGS

 12. PROTECT EXISTING FLOORS, WALLS AND CORNERS TO REMAIN
 ALONG WORK ACCESS ROUTES
- 13. CONTAIN DUST AND DEBRIS WITHIN THE DEMOLITION AREA
 14. DEMOLISH AND REMOVE CARPET, PAD, TACK STRIP, AND VINYL
 TILE. REMOVE ALL FLOOR MATERIALS INCLUSIVE OF SETTING
 BEDS, SUBFLOOR MATERIAL ETC. REMOVE MASTIC TO PROVIDE
 A CLEAN FLOOR THAT IS ACCEPTABLE TO THE SUBCONTRACTOR
 INSTALLING NEW FINISH MATERIAL.
- 15. DEMOLISH AND REMOVE DOORS, VINYL BASE, CONDUIT, WIRING, CONVECTOR COVERS WITH SUPPORT FRAMING, DUPLEXES, TELEPHONE OUTLETS, CABLES, SHELVING, METAL STUD AND GYPSUM BOARD WALLS, CLOSETS, CABINETS, FILES, COUNTERS, WOOD MOLDING, SHELVES AND ENCLOSURES WHERE APPLICABLE.

 16. DEMOLISH AND REMOVE SUSPENDED ACOUSTIC LAY-IN OR
- SPLINE CEILING INCLUSIVE OF HANGERS AND CARRYING CHANNELS, WIRES, CABLES, CONDUIT, ADHERED CEILING TILES, FLEX CONDUIT, ELECTRICAL BOXES, SMOKE DETECTORS, LIGHT FIXTURES AND WIRING, DUCT WORK, PIPING AND SUPPORT HANGERS. CUT HANGERS FLUSH.

 17. CONTRACTOR SHALL ASSIST IN COORDINATING THE IDENTIFICATION OF UTILITES TO REMAIN.
- 18. DEMOLITION FOR THE FLOOR AREAS SHALL ENCOMPASS THE SPACE FROM THE TOP OF THE CONCRETE FLOOR TO THE UNDERSIDE OF THE EXISTING INTERSTITIAL STRUCTURE ABOVE UNLESS NOTED OTHERWISE.
 19. ALL DEMOLITION MATERIALS AND DEBRIS SHALL BE DISPOSED OF ACCORDING TO FEDERAL, STATE AND LOCAL REGULATIONS
 20. CONTRACTOR SHALL PERFORM WORK IN A MANNER THAT DOES NOT DAMAGE THE EXITNG STRUCTURE. DEMOLITION SHALL NOT
- COMPRISE THE STRUCTURAL INTEGRITY OF ANY WALLS, FLOORS, VEILINGS, SUPPORTS, STRUCTURE, ETC TO REMAIN.

 21. AT LOCATIONS WHERE EXISTING WALLS ARE TO BE REMOVED NEAR EXISTING WALLS TO REAMIN, PERFORM DEMOLTION WITHOUT DISTURBING EXISTING ELEMENTS TO REMAIN. WALLS TO REMAIN SHALL BE INTACT AND HAVE A NEAT SURFACE WITH NO PROJECTIONS GREATER THAT 1/2" FROM THE FACE OF WALL 22. REMOVE EXISTING ROOF CURB REFER TO MECH DWGS

DEMOLITION KEYNOTES

- 1 REMOVE BOTTOM PORTION OF WALL
- 2 REMOVE EXISTING PIPE
- REMOVE EXISTING LOUVER
- REMOVE EXIST STRUCTURAL SUPPORT AND ASSOCIATED CATWALK
- REMOVE EXIST PAVERS, GRAVEL, ROOFING, INSULATION, AND CINDER FILL TO STRUCTURAL SLAB
- REMOVE EXIST PARAPET
- 7 REMOVE EXIST SLAB AND FOUNDATION
- REMOVE EXIST DOOR
- REMOVE EXTERIOR DOOR HANDLE, AND REWORK DOOR
- 10 REMOVE SCREEN WALL
- 11 REMOVE STORAGE ENCLOSURE
- REMOVE BLEACHERS
- REMOVE PORTION OF CEILING AS REQUIRED TO COMPLETE NEW WORK
- REMOVE EXISTING GUARD RAIL, SALVAGE FOR REUSE
- 15 "NOT USED"
- REMOVE EXIST PAVEMENT
- REMOVE PORTABLE RESTROOMS AND ASSOCIATED PIPING, REFER TO MECH
- 18 "NOT USED"
- REMOVE EXISTING ROOF CURB REFER TO MECH DWGS
- 20 "NOT USED"
- MAS WALL AND SILL AT DOOR TO BE REMOVED TO CONC SLAB BELOW
- DISASSEMBLE EXISTING FENCE, SALVAGE FOR REUSE
- REMOVE EXISTING RAMP, PLATFORM, AND/OR
- 24 REMOVE EXIST SEATING
- REMOVE EXISTING LADDER, SALVAGE FOR REUSE
- 26 REMOVE EXIST GLAZED CUTAIN WALL
- REMOVE TOP PORTION OF EXISTING MAS WALL PARAPET

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Issue History

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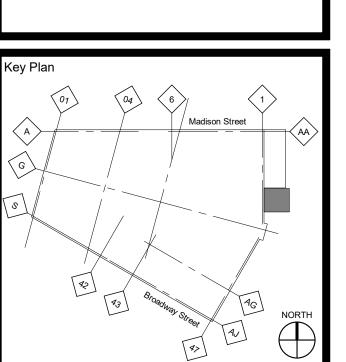
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CONSTRUCTION



MICHIGAN OPERA THEATRE

Detroit Opera House Renovation -Phase 1A Detroit, MI

In Charge Z. TOLBERT

Designed ZAT

Drawn By AD

Checked Checker

Approved Approver

Approved Approver Date 01/20/2
Sheet Title

ELEVATOR TOWER

Job No. 08022-D0

DEMO PLAN

Sheet No.
AD-401A