



LOCATION PLAN

ISSUED FOR:

PERMIT REVIEW

11.18.2020

1531 8TH STREET


Detroit, MI, 48216

GENERAL NOTES	GENERAL NOTES	PROJECT INFORMATION	ISSUANCE	DRAWING LIST
<p>1. ALL WORK IS TO BE DONE IN ACCORDANCE WITH THE RULES AND REGULATIONS OF THE LOCAL JURISDICTION, UNLESS OTHERWISE AGREED UPON. THE GENERAL CONTRACTOR IS RESPONSIBLE FOR SECURING ALL BUILDING PERMITS AS REQUIRED FOR WORK TO BE PERFORMED AND WILL RETAIN AND PAY FOR ALL REQUIRED INSPECTIONS DURING THE COURSE OF THE WORK.</p> <p>2. PROVIDE SAFE AND SECURE JOBSITE PRIOR TO, DURING, AND AFTER WORK. PROVIDE ALL NECESSARY SAFETY DEVICES, LIGHTING, AND BARRIERS AS NECESSARY - ESPECIALLY AROUND ALL STAIR, ELEVATOR, AND ROOF PENETRATIONS IN ACCORDANCE WITH LOCAL CODES AND REGULATIONS, AND ANY APPLICABLE OSHA GUIDELINES.</p> <p>3. THE GENERAL CONTRACTOR SHALL VISIT THE SITE BEFORE PROVIDING A PRICE AND BE AWARE OF EXISTING CONDITIONS TO THE EXTENT AND INFLUENCE OF THE WORK.</p> <p>4. DO NOT SCALE DRAWINGS FOR DIMENSIONS AND / OR SIZES. THE GENERAL CONTRACTOR SHALL BE RESPONSIBLE FOR FIELD MEASURING EXISTING CONDITIONS PRIOR TO THE BEGINNING OF WORK, AND PERIODICALLY DURING PROGRESS OF WORK TO VERIFY ALL CRITICAL DIMENSIONS. ANY DEVIATIONS FROM DIMENSIONS INDICATED ON DRAWINGS ARE TO BE APPROVED BY ARCHITECT, PRIOR TO CONSTRUCTION.</p> <p>5. ANY DISCREPANCIES FOUND IN THE DRAWINGS, DIMENSIONS, EXISTING CONDITIONS, OR ANY APPARENT ERROR IN CLASSIFYING OR SPECIFYING A PRODUCT OR ITS USE IS TO BE POINTED OUT TO THE ARCHITECT PRIOR TO COMMENCEMENT OF WORK. ADDENDA WILL BE ISSUED AS NECESSARY AND WILL BECOME PART OF THE CONTRACT DOCUMENTS. FOR THOSE DISCREPANCIES NOT BROUGHT TO THE ATTENTION OF THE ARCHITECT, IT WILL BE ASSUMED THAT THE CONTRACTOR HAS BID THE MORE EXPENSIVE METHOD OF CONSTRUCTION.</p> <p>6. THE GENERAL CONTRACTOR / SUB-CONTRACTORS ARE TO VERIFY ALL CONDITIONS PRIOR TO THE BEGINNING OF CONSTRUCTION OF ANY TRADE. NOTIFY ARCHITECT OF ANY DISCREPANCIES WITHIN THE PLANS, DRAWINGS, OR OBVIOUS FIELD CONDITIONS WHICH PROHIBIT THE WORK FROM BEING BUILT, AS SHOWN.</p> <p>7. THE GENERAL CONTRACTOR IS RESPONSIBLE FOR THE MEANS, METHODS, SEQUENCES, AND PROCEDURES OF CONSTRUCTION.</p> <p>8. THE GENERAL CONTRACTOR IS TO COORDINATE ALL CIVIL, ARCHITECTURAL, MECHANICAL, PLUMBING, ELECTRICAL, AND STRUCTURAL TRADES.</p> <p>9. THE GENERAL CONTRACTOR IS TO PRESERVE, TAKE CARE OF, AND COORDINATE WITH THE UTILITY COMPANIES AND SUB-CONTRACTORS.</p> <p>10. SHOP DRAWINGS / SUBMITTALS / SAMPLES ARE TO BE SUBMITTED TO THE ARCHITECT FOR APPROVAL BEFORE PROCEEDING WITH ALL ITEMS WHICH REQUIRE FABRICATION.</p> <p>11. CHANGES IN THE WORK SHALL BE INITIATED THROUGH CONSTRUCTION DIRECTIVES. CONTRACTOR SHALL NOT PROCEED WITH EXECUTION OF CHANGES WITHOUT WRITTEN APPROVAL FROM OWNER OF CHANGE ORDER NOTING CHANGES TO CONTRACT PRICE AND TIME.</p> <p>12. THE STRUCTURE HAS BEEN DESIGNED TO BE SELF SUPPORTING AND STABLE AFTER THE BUILDING IS FULLY COMPLETED. IT IS THE GENERAL CONTRACTOR'S SOLE RESPONSIBILITY TO DETERMINE THE ERECTION PROCEDURES AND SEQUENCING TO ENSURE THE SAFETY OF THE BUILDING AND ITS COMPONENT PARTS DURING ERECTION. THIS INCLUDES THE ADDITION OF TEMPORARY BRACING, SHORING, SUPPORT, GUYS, OR TIE-DOWNS IF NECESSARY.</p> <p>13. ENSURE ALL FIRE AND LIFE SAFETY ITEMS THAT ARE EXISTING AND REQUIRED, REMAIN OPERATIONAL DURING CONSTRUCTION.</p> <p>14. MAINTAIN ALL REQUIRED FIRE RATINGS / SEPARATIONS IN WALLS AND CEILINGS AS REQUIRED BY THE APPLICABLE BUILDING CODE, AND RULES AND PER THE RULES AND REGULATIONS OF THE LOCAL JURISDICTION.</p> <p>15. EXECUTE FIRE WATCH AND PREVENTION PROCEDURES ON SITE DURING FIELD CUTTING AND WELDING OPERATIONS MEETING THE OWNERS REQUIREMENTS.</p> <p>16. PROVIDE NECESSARY TEMPORARY CONSTRUCTION BARRIERS BETWEEN EXISTING AND NEW CONSTRUCTION SPACES (DEMOLITION AREA). MAINTAIN LEGAL EXITS SYSTEMS AND EGRESS FOR BOTH SPACES PER LOCAL CODES. PROVIDE SIGNAGE TO DESIGNATE THE EXITS AND SEPARATION OF THE SPACES.</p> <p>17. EXISTING CONSTRUCTION NOT UNDERGOING ALTERATION IS TO REMAIN UNDISTURBED, WHERE SUCH EXISTING CONDITIONS NOT UNDERGOING ALTERATION ARE DISTURBED AS A RESULT OF THE OPERATIONS OF THIS CONTRACT, ALL ADVERSELY AFFECTED CONDITIONS MUST BE REPAIRED OR REPLACED BY THE CONTRACTOR AS REQUIRED TO THE SATISFACTION OF THE ARCHITECT.</p> <p>18. ANY DAMAGE TO NEW OR EXISTING CONSTRUCTION CAUSED BY THE CONTRACTOR'S NEGLIGENCE OR INADEQUATE PROTECTIVE OR SECURITY MEASURES DURING CONSTRUCTION ARE TO BE CORRECTED AT THE GENERAL CONTRACTOR'S EXPENSE.</p> <p>19. PROVIDE ADEQUATE SHORING AND SUPPORT OF ALL STRUCTURAL ITEMS TO BE REMOVED IN ACCORDANCE WITH STRUCTURAL ENGINEERS DOCUMENTS / SPECIFICATIONS, LOCAL CODES AND REGULATIONS, AND ANY APPLICABLE OSHA GUIDELINES.</p> <p>20. DEMOLITION OF ALL PORTIONS OF THE STRUCTURE TO BE REMOVED SHALL BE DONE WITH THE UTMOST CARE. USING TOOLS AND METHODS SUBJECT TO OWNER'S APPROVAL. ALL POSSIBLE CARE SHALL BE TAKEN TO AVOID DAMAGING, SHOCK, OR VIBRATION TO PORTIONS OF THE EXISTING STRUCTURE TO REMAIN.</p> <p>21. IF DEMOLITION OF EXISTING STRUCTURE IS REQUIRED TO ACCESS A SPACE OR COMPLETE CONSTRUCTION, AND IT IS NOT INDICATED ON THE DOCUMENTS, NOTIFY ARCHITECT TO HAVE A STRUCTURAL ENGINEER REVIEW THE SCOPE OF DEMOLITION REQUIRED AND PROVIDE EITHER AN APPROVAL OR DOCUMENTS TO INSTRUCT THE METHODS OF DEMOLITION.</p> <p>22. REMOVE AND / OR RELOCATE ALL MECHANICAL, PLUMBING, AND ELECTRICAL ITEMS INCLUDING PIPING, FITTINGS, EQUIPMENT, DUCTWORK, WIRING, DEVICES, PANELS, AND ACCESSORIES AS REQUIRED. REFER TO MECHANICAL, ELECTRICAL, AND PLUMBING DOCUMENTS FOR FURTHER DIRECTION PRIOR TO START OF DEMOLITION.</p> <p>23. THE GENERAL CONTRACTOR AND DEMOLITION CONTRACTOR, SHALL VERIFY THE EXISTENCE AND LOCATIONS, AND ELEVATIONS OF ALL EXISTING UTILITIES INCLUDING EXISTING WATER, SEWERS / STORM MAINS, DRAINS, ELECTRICAL AND GAS SERVICES, ETC., IN THE DEMOLITION AREAS BEFORE PROCEEDING WITH THE WORK. ALL DISCREPANCIES SHALL BE DOCUMENTED AND REPORTED TO THE ARCHITECT.</p>	<p>24. REMOVE ALL MATERIALS AND DEBRIS CREATED DURING THE DEMOLITION AND/OR THE CONSTRUCTION PROCESS AND DISPOSE OFF SITE IN A SAFE AND LEGAL MANNER.</p> <p>25. CAP, PATCH, AND REPAIR ALL HOLES AND SURFACES IN WALLS, FLOORS, AND CEILINGS WHERE ARCHITECTURAL, STRUCTURAL, MECHANICAL, ELECTRICAL, OR PLUMBING ITEMS ARE TO BE REMOVED.</p> <p>26. NEATLY SAW CUT AND REMOVE CONCRETE AS REQUIRED FOR PLACEMENT OF NEW INSTALLATIONS OF PLUMBING, NECESSARY CAPPING OF EXISTING, AND INSTALLATION OF NEW FOUNDATION WORK.</p> <p>27. PREPARE ALL DEMOLITION AREAS FOR NEW FINISHES.</p> <p>28. THE GENERAL CONTRACTOR IS TO COORDINATE ALL WORK WITH OWNER'S PERSONNEL TO AVOID ANY INTERFERENCE OR CONFLICT IN OPERATIONS.</p> <p>29. THE GENERAL CONTRACTOR FOR A PERIOD OF ONE YEAR FROM THE DATE OF COMPLETION AND ACCEPTANCE BY OWNER, SHALL ADJUST, REPAIR, OR REPLACE AT NO COST TO THE OWNER ANY ITEM OF EQUIPMENT, MATERIAL, OR WORKMANSHIP FOUND TO BE DEFECTIVE, INCLUDING OR AFFECTED WITHIN THE SCOPE OF THE CONTRACT.</p>	<p>PROJECT ADDRESS: 4100 THROD STREET, DETROIT, MI 48201</p> <p>PROJECT DESCRIPTION: RENOVATION OF EXISTING COMMERCIAL BUILDING INTO NEW RESTAURANT</p> <p>APPLICABLE CODES: ALL WORK SHALL CONFORM TO APPLICABLE GOVERNING CODES, INCLUDING BUT NOT LIMITED TO: 1. 2015 MICHIGAN REHABILITATION CODE FOR EXISTING BUILDINGS - ALTERATION LEVEL 2. 2015 MICHIGAN MECHANICAL CODE 3. 2017 MICHIGAN ELECTRICAL CODE 4. 2015 MICHIGAN PLUMBING CODE</p> <p>BUILDING DATA: ZONING DISTRICT: S02</p> <p>BUILDING DATA: A. TYPE OF CONSTRUCTION: 111B - LOAD BEARING BRICK MASONRY WITH CONCRETE FLOOR AND WOOD ROOF CONSTRUCTION B. STORES ABOVE GRADE: 1 C. BUILDING AREAS (GROSS): EXISTING 1. TOTAL BUILDING AREA (GROSS): 2,994 SQFT D. OCCUPANCY: 14 E. BUILDING HEIGHTS: FROM GRADE: 17'-4" 1. FIRST LEVEL: 0'-0" (A.G.) 2. ROOF: -16'-7" (A.G.) 3. ALLOWABLE: .</p>	<p>20201118</p>	<p>GENERAL SHEETS A-000 COVER</p> <p>SITE AND CIVIL ENGINEERING SHEETS C2-01 EXISTING SITE PLAN C2-00 PROPOSED SITE PLAN</p> <p>ARCHITECTURAL SHEETS - BUILDING A A1-00 ARCHITECTURE PLANS A2-00 EXTERIOR ELEVATIONS A3-00 FRONT PORCH ELEVATIONS AND SECTIONS A3-01 REAR PORCH ELEVATIONS AND SECTIONS A5-00 ARCHITECTURAL DETAILS</p>
	<p>SYMBOLS</p> <p>CONCRETE MASONRY UNIT BRICK CONCRETE INSULATION (BATT, CELLULOSE, SPRAY-FOAM) RIGID INSULATION PLYWOOD METAL FINISHED WOOD WOOD (ROUGH CONTINUOUS) WOOD (ROUGH NON-CONTINUOUS / BLOCKING) GLASS ALIGN</p> <p>COLUMN LINE IDENTIFICATION PARTITION TYPE DEMOLITION KEYNOTE FOUNDATION KEYNOTE ARCHITECTURAL KEYNOTE ROOF KEYNOTE ELECTRICAL KEYNOTE STRUCTURAL KEYNOTE ELEVATION KEYNOTE VERTICAL HEIGHT ELEVATION WINDOW TYPE/SCHEDULE NUMBER DOOR TYPE/SCHEDULE NUMBER MATERIAL SPECIFICATION NUMBER REVISION NUMBER</p> <p>PLAN DETAIL TAG DETAIL NUMBER SHEET NUMBER SECTION TAG SECTION NUMBER SHEET NUMBER ELEVATION TAG ELEVATION NUMBER SHEET NUMBER</p> <p>SHEET IDENTIFICATION NUMBER DISCIPLINE DESIGNATOR A-ARCHITECTURAL SHEET SHEET SEQUENCE NUMBER NUMBER IDENTIFYING EACH SHEET IN SET SHEET TYPE DESIGNATOR 0 - GENERAL (SYMBOLS, LEGEND NOTES) 1 - PLANS (HORIZONTAL VIEWS) 2 - ELEVATIONS (VERTICAL VIEWS) 3 - SECTIONS, DETAILS, DIAGRAMS, NOTES</p>			
		<p>SIGNATURE BLOCK</p> <p>NAME OF AUTHORIZED REPRESENTATIVE</p> <p>[Owner]</p> <p>[Architect] Christian Hurttianne Architects, LLC</p> <p>[General Contractor]</p>		

Christian Hurttianne Architects, LLC
2111 Woodward Ave., Suite #201, Detroit, MI 48201 313.825.2005x101 Chris@cha-c.com

DEVELOPER
ARCHITECT
LAND SURVEYOR
CIVIL ENGINEER
STRUCTURAL ENGINEER
MEP ENGINEER
GENERAL CONTRACTOR

CONTRACTOR NOTE
 ALL CONTRACTORS (GENERAL CONTRACTOR, SUB-CONTRACTORS, MEMBERS OR AGENTS OF EITHER OR BOTH) ARE TO VERIFY AND COORDINATE ALL CONDITIONS, DIMENSIONS, QUANTITIES AND DETAILS, STATED OR NOT, WITHIN THESE DRAWINGS AND WITHIN THE SPECIFICATIONS BEFORE COMMENCING WITH THE WORK. IF A DIMENSIONAL ERROR OR CONFLICT OCCURS BETWEEN THESE DRAWINGS, THE SPECIFICATIONS OR THE EXISTING / PROPOSED CONDITIONS, IT SHALL BE BROUGHT TO THE IMMEDIATE ATTENTION OF THE ARCHITECT, BEFORE PROCEEDING WITH THE WORK. ANY PARTY (GENERAL CONTRACTOR, SUB-CONTRACTORS, MEMBERS OR AGENTS OF EITHER OR BOTH) WHO FAILS TO DO SO, TAKE FULL RESPONSIBILITY OF ANY ERRORS, CONFLICTS, SCHEDULE AND COST IMPLICATIONS.

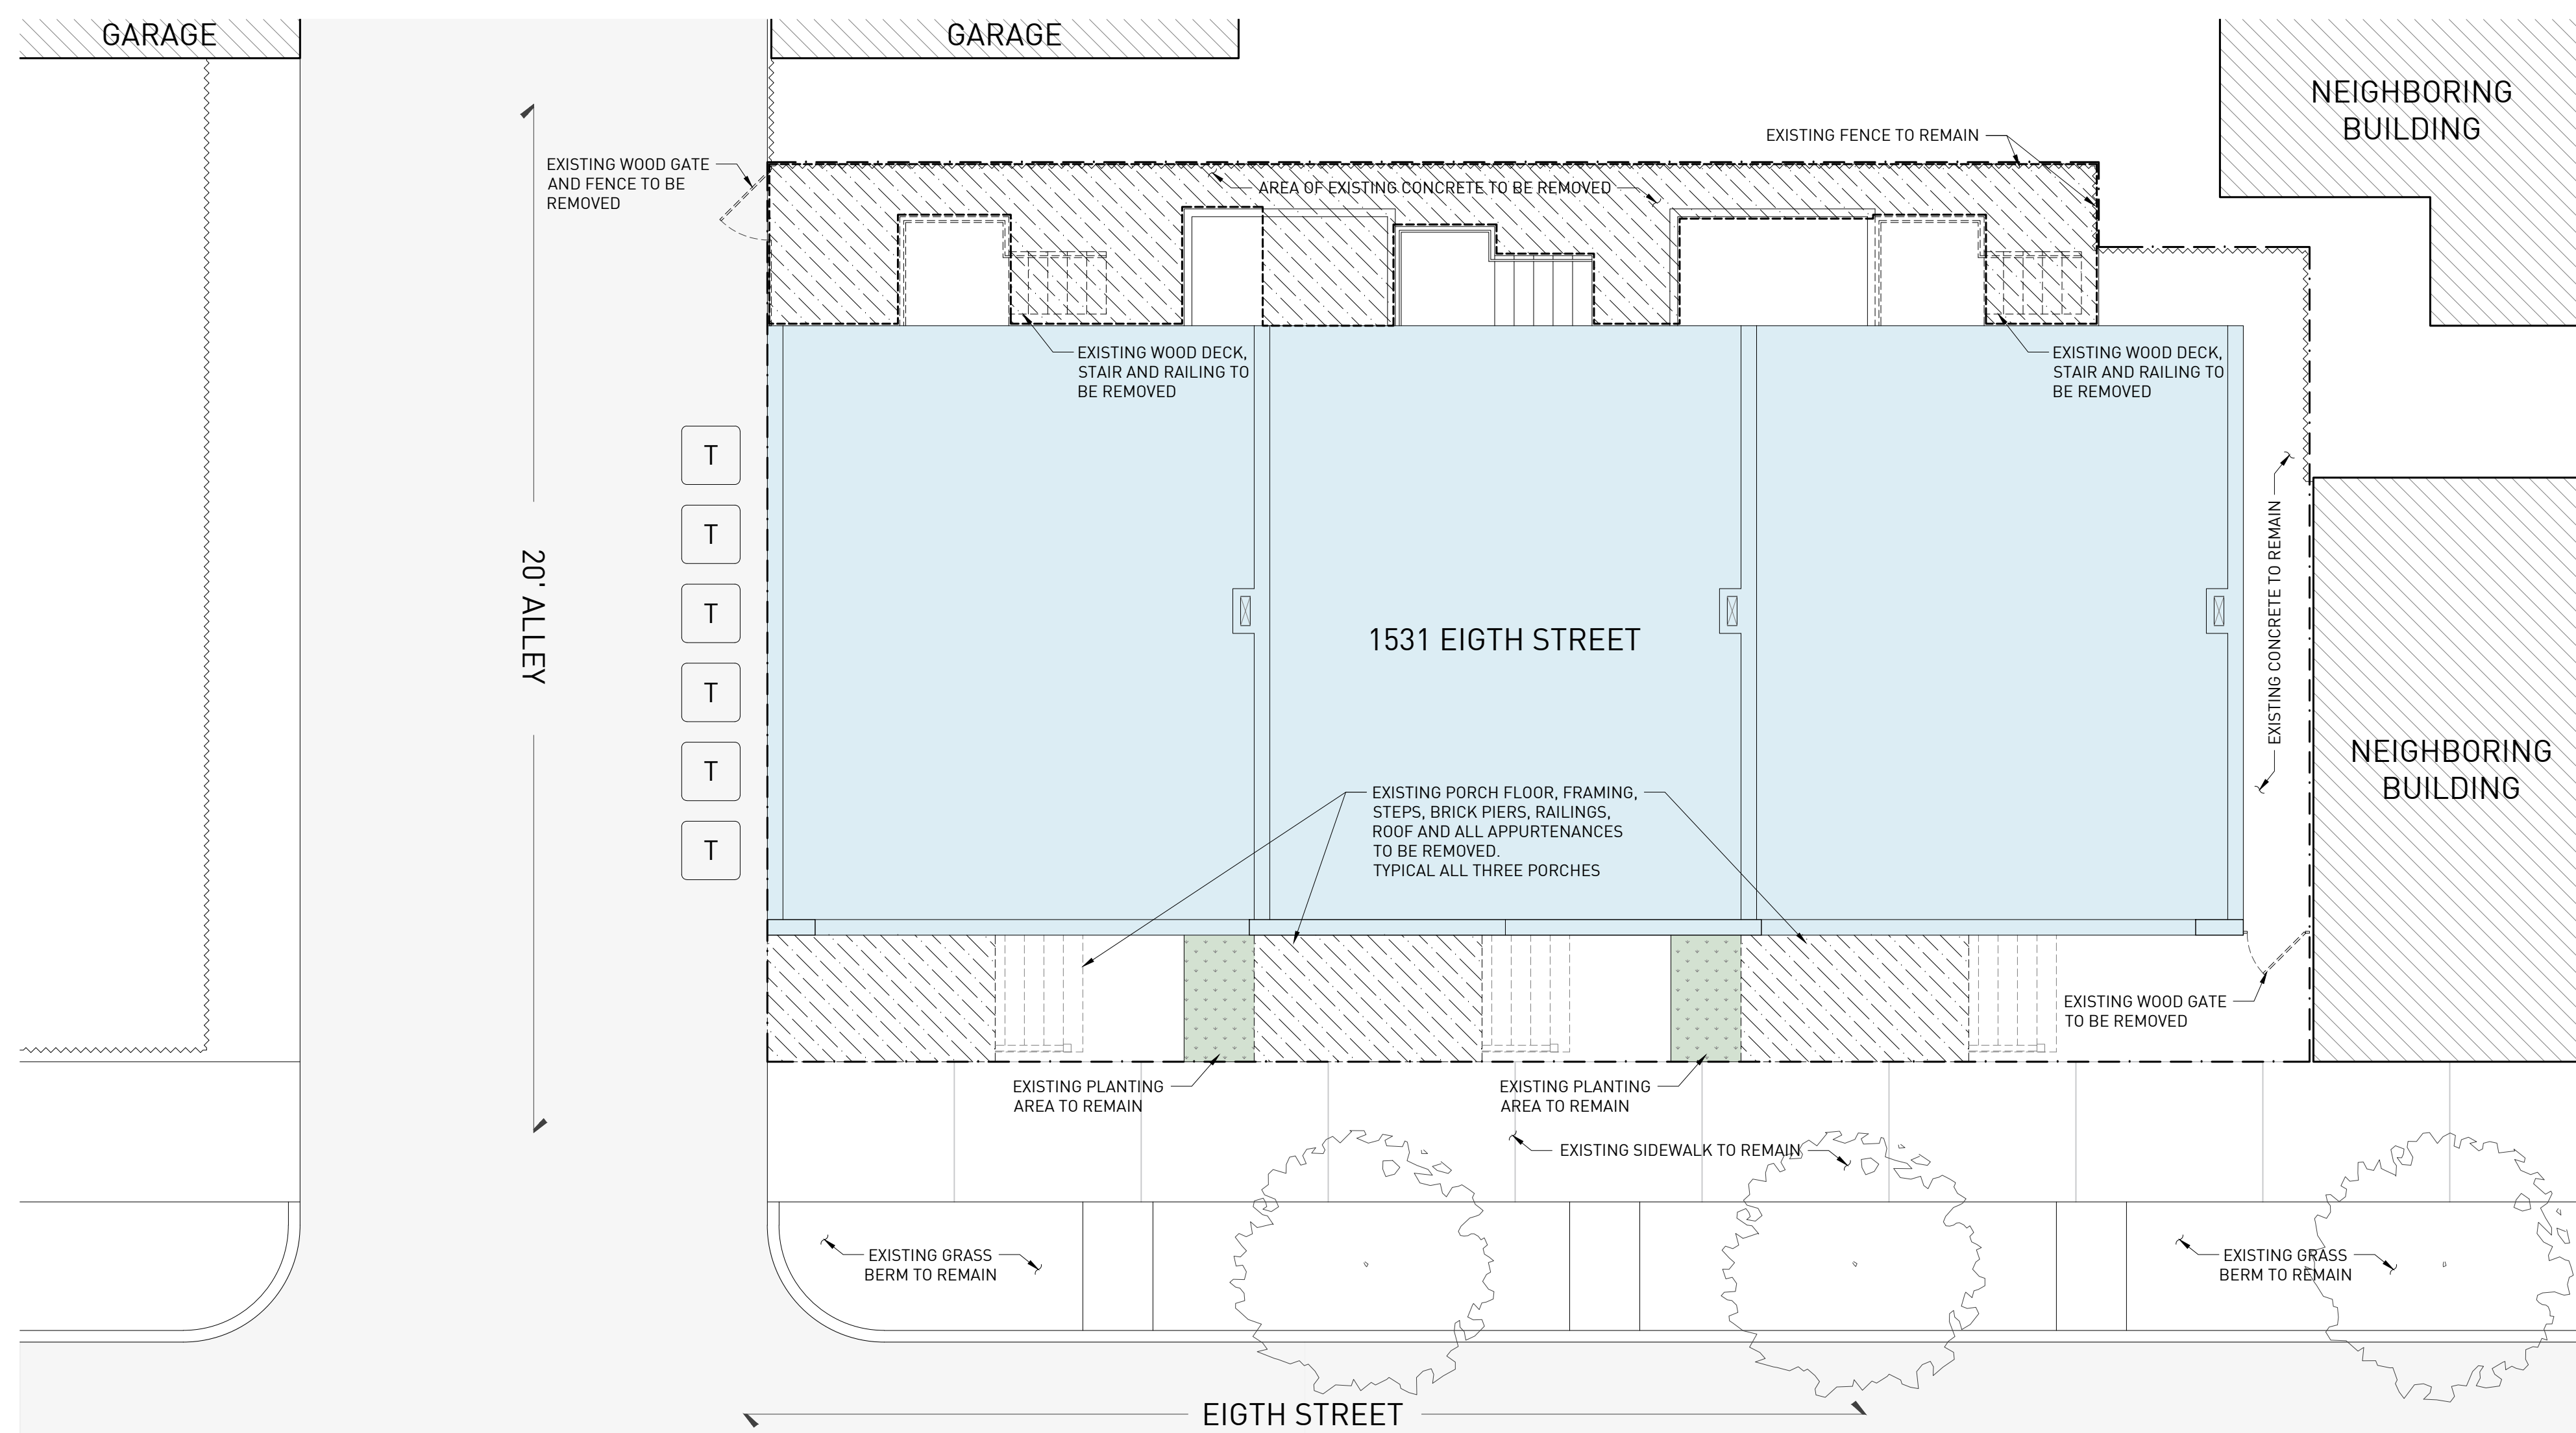

1 EXISTING SITE PLAN
 ORIGINAL IMAGE SCALE: 3/16" = 1'-0"

1531 8TH STREET
 DETROIT, MI 48216
 PERMIT REVIEW


REVISIONS	DATE	DESCRIPTION
1.	20201118	PERMIT REVIEW



EXISTING SITE PLAN

DRAWING NO. C2-00

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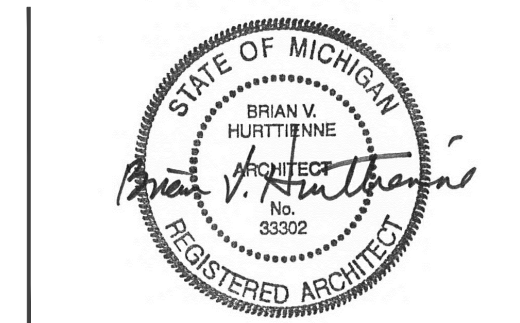


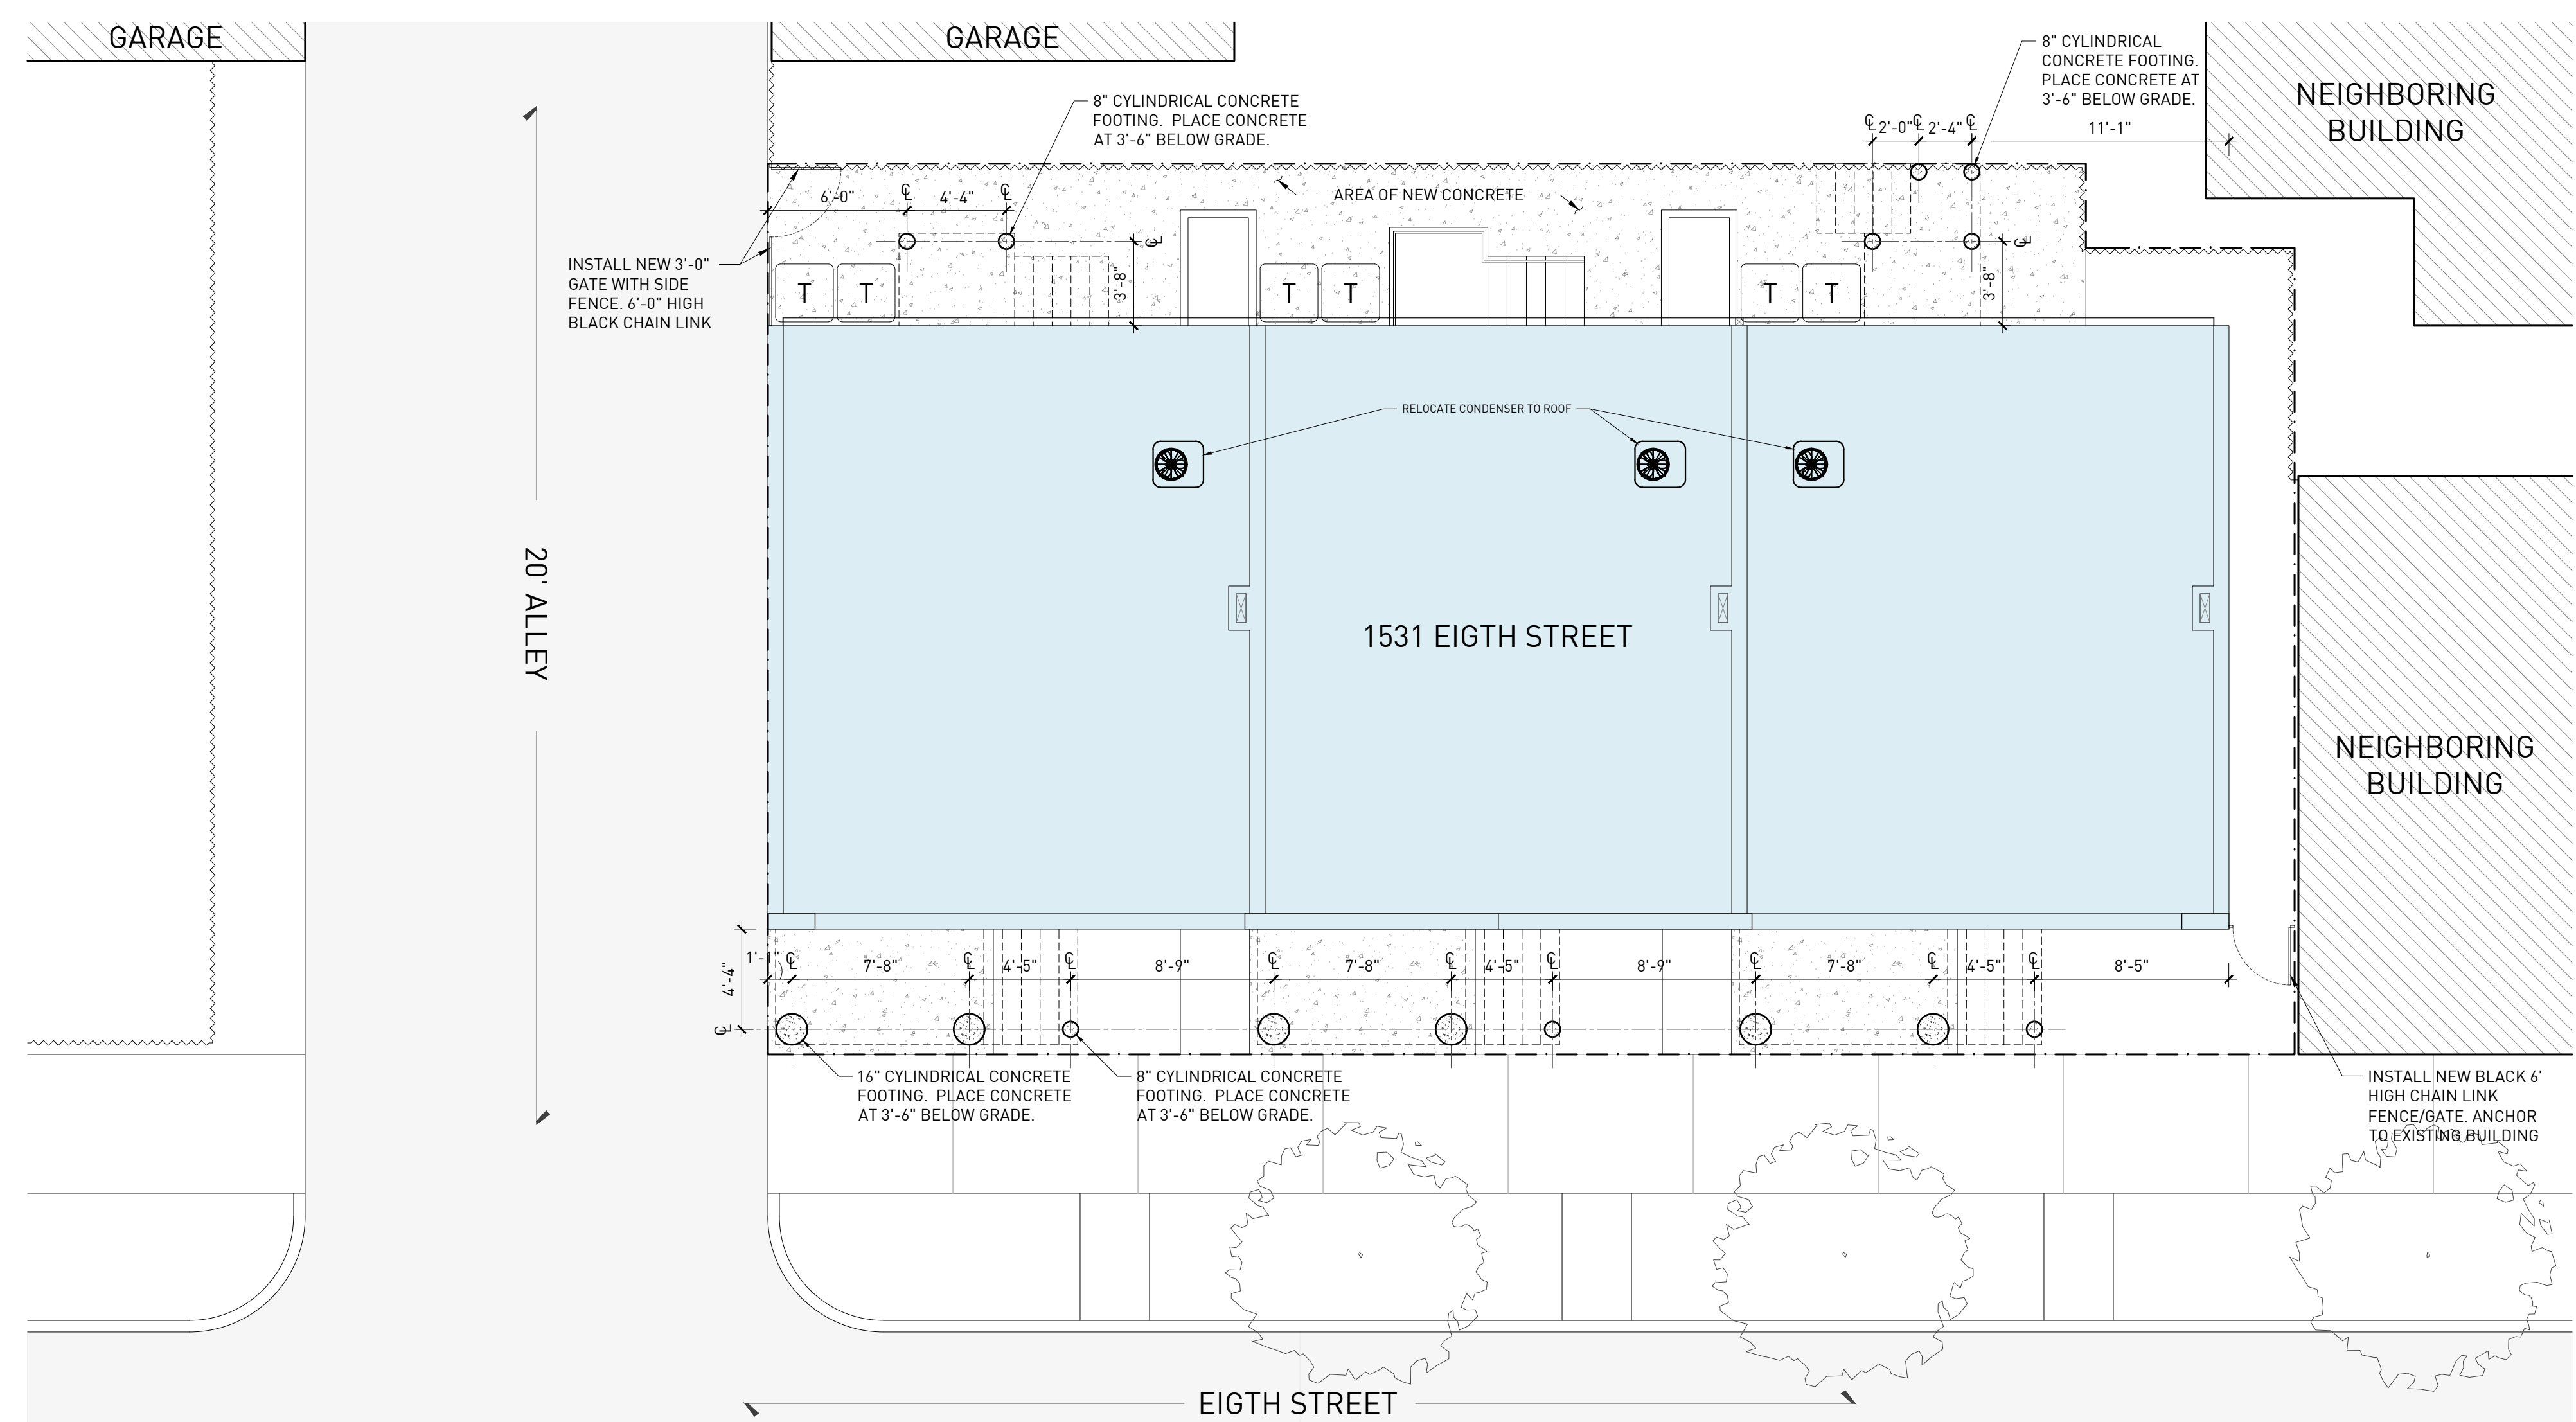1 PROPOSED SITE PLAN
 ORIGINAL IMAGE SCALE: 3/16" = 1'-0"



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PROPOSED SITE PLAN

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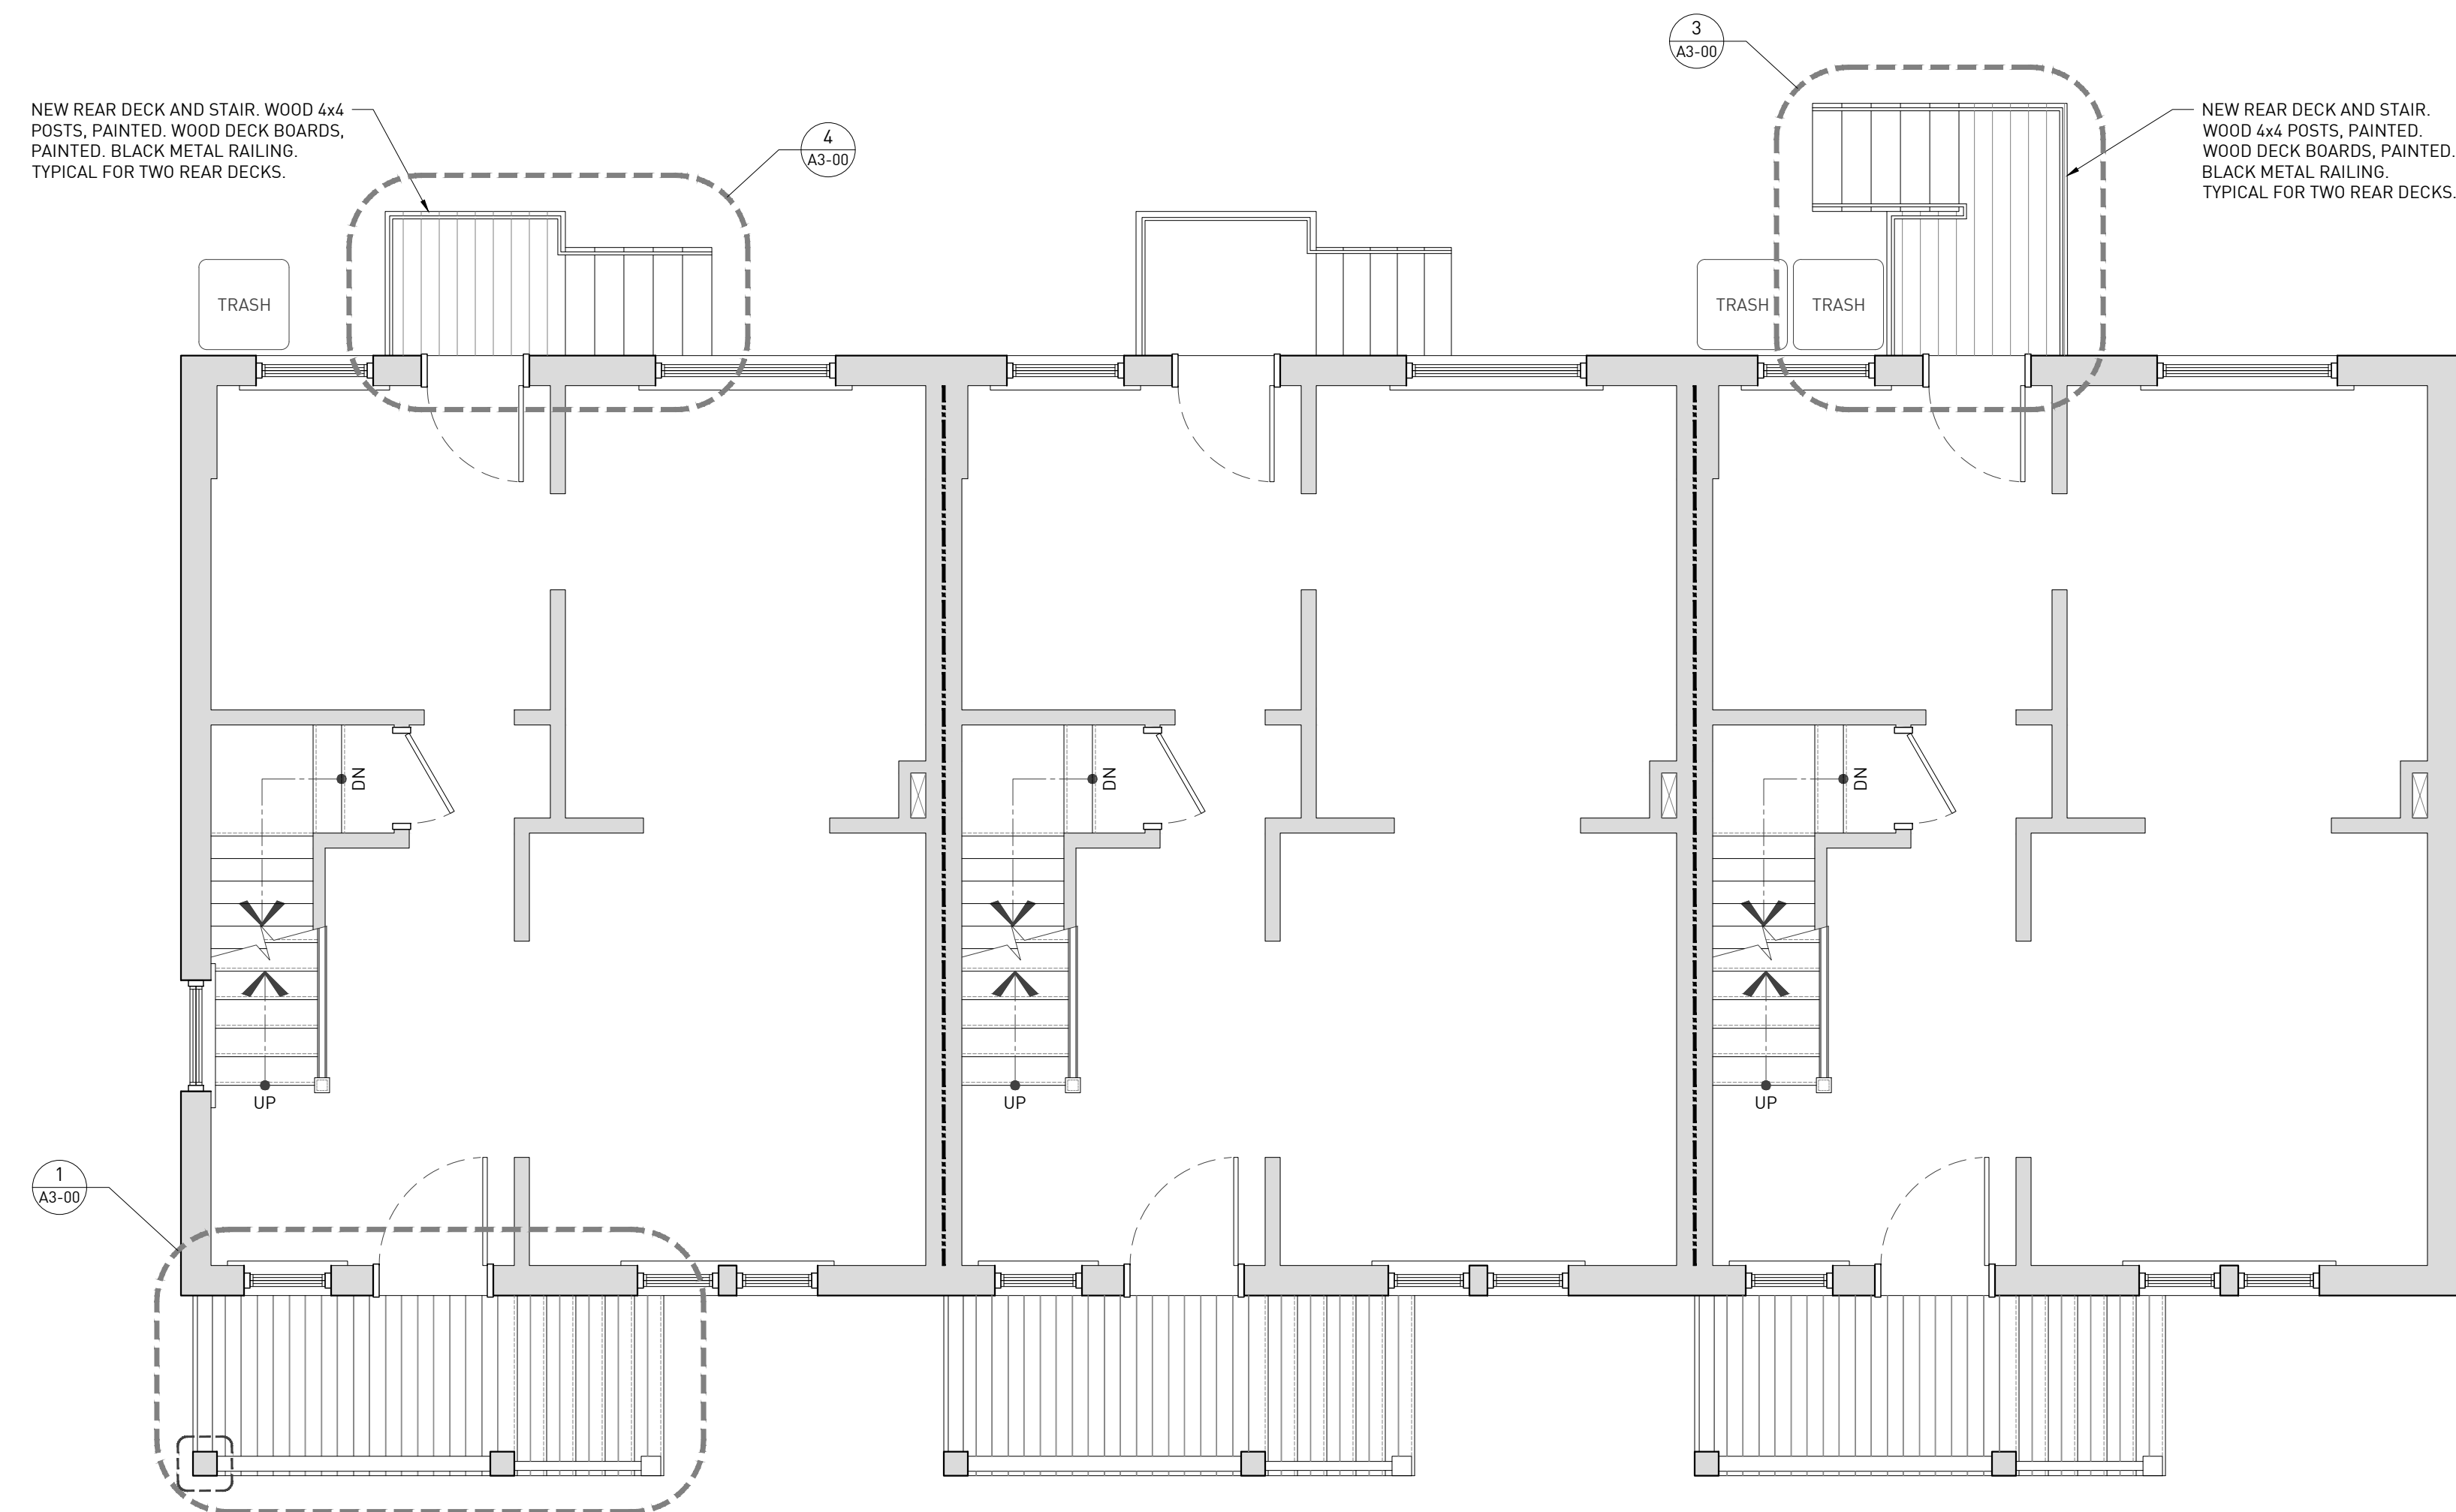
SYMBOLS

NOTE: SOME SYMBOLS MAY NOT BE APPLICABLE.

- EXISTING MASONRY WALL CONSTRUCTION.
- EXISTING WALL CONSTRUCTION.
- NEW 8" MASONRY WALL CONSTRUCTION WITH 2X6 METAL 'FURRED' CONSTRUCTION WITH BATT INSULATION AND 5/8" GYPSUM BOARD.
- NEW 4" MASONRY WALL CONSTRUCTION WITH 2X6 METAL 'FURRED' CONSTRUCTION WITH BATT INSULATION AND 5/8" GYPSUM BOARD.
- NEW METAL-FRAMED WALL CONSTRUCTION

ARCHITECTURE GENERAL NOTES


1. ALL NEW WALL AND PARTITION CONSTRUCTION IS TO BE PER WALL ASSEMBLY A2 SHEET A5-01, UNLESS OTHERWISE NOTED.
2. ALL WALL ASSEMBLIES MAY OCCUR AT EXISTING FRAMING LOCATIONS TO REMAIN. ALL ASSEMBLIES, EXISTING OR NEW, ARE TO PERFORM ACCORDING TO ASSEMBLY DETAILS, ASSOCIATED UL RATINGS AND SPECIFICATIONS.
3. WHERE A NEW ASSEMBLY IS TO COORDINATE WITH AN EXISTING ASSEMBLY, MAKE ALL NECESSARY PREPARATIONS TO ENSURE SMOOTH, CONSISTENT AND UN-NOTICABLE FINISH ACROSS ENTIRE SURFACE.
4. FIRE-SEAL / FIRE-CAULK SEALANT TO BE INSTALLED AT ALL INTERSECTIONS, CONSTRUCTION ASSEMBLIES, PENETRATIONS, OR AS REQUIRED TO COMPLETE FIRE-BLOCKING CLOSURES AS PER APPLICABLE BUILDING CODE.
5. ALL WALL ASSEMBLIES LOCATED AT OR ADJACENT TO AN EXISTING EXTERIOR WALL, OR ARE LOCATED ADJACENT TO A 'COLD-ZONE', ARE TO RECEIVE A MINIMUM OF R-21 INSULATION, WITH VAPOR BARRIER (WARM SIDE), PER CODE.
6. ALL LOCATIONS OF CEMENTITIOUS TILE BACKER BOARD ARE TO BE COORDINATED WITH THE OWNER AND SCHEDULED WALL ASSEMBLY. MAINTAIN ALL REQUIRED FIRE RATINGS ACCORDING TO WALL ASSEMBLY DETAILS, ASSOCIATED UL RATINGS AND SPECIFICATIONS.
7. GENERAL CONTRACTOR PROVIDE BLOCKING WHERE REQUIRED TO SUPPORT MILLWORK, STOREFRONT EQUIPMENT, OR OTHER FINISHES.



RECONSTRUCT NEW FRONT PORCHES

- NEW BRICK PIERS
- WOOD FRAMED
- WOOD TRIM, PAINTED
- WOOD DECKING, PAINTED
- WOOD RAILINGS, PAINTED
- WOOD COLUMNS, TRIM AND SOFFITS, PAINTED
- WOOD CEILING, PAINTED
- NEW BLACK ASPHALT ROOF
- WOOD DECORATIVE RAILING, PAINTED

1 FIRST LEVEL PLAN
ORIGINAL IMAGE SCALE: 1/4" = 1'-0"

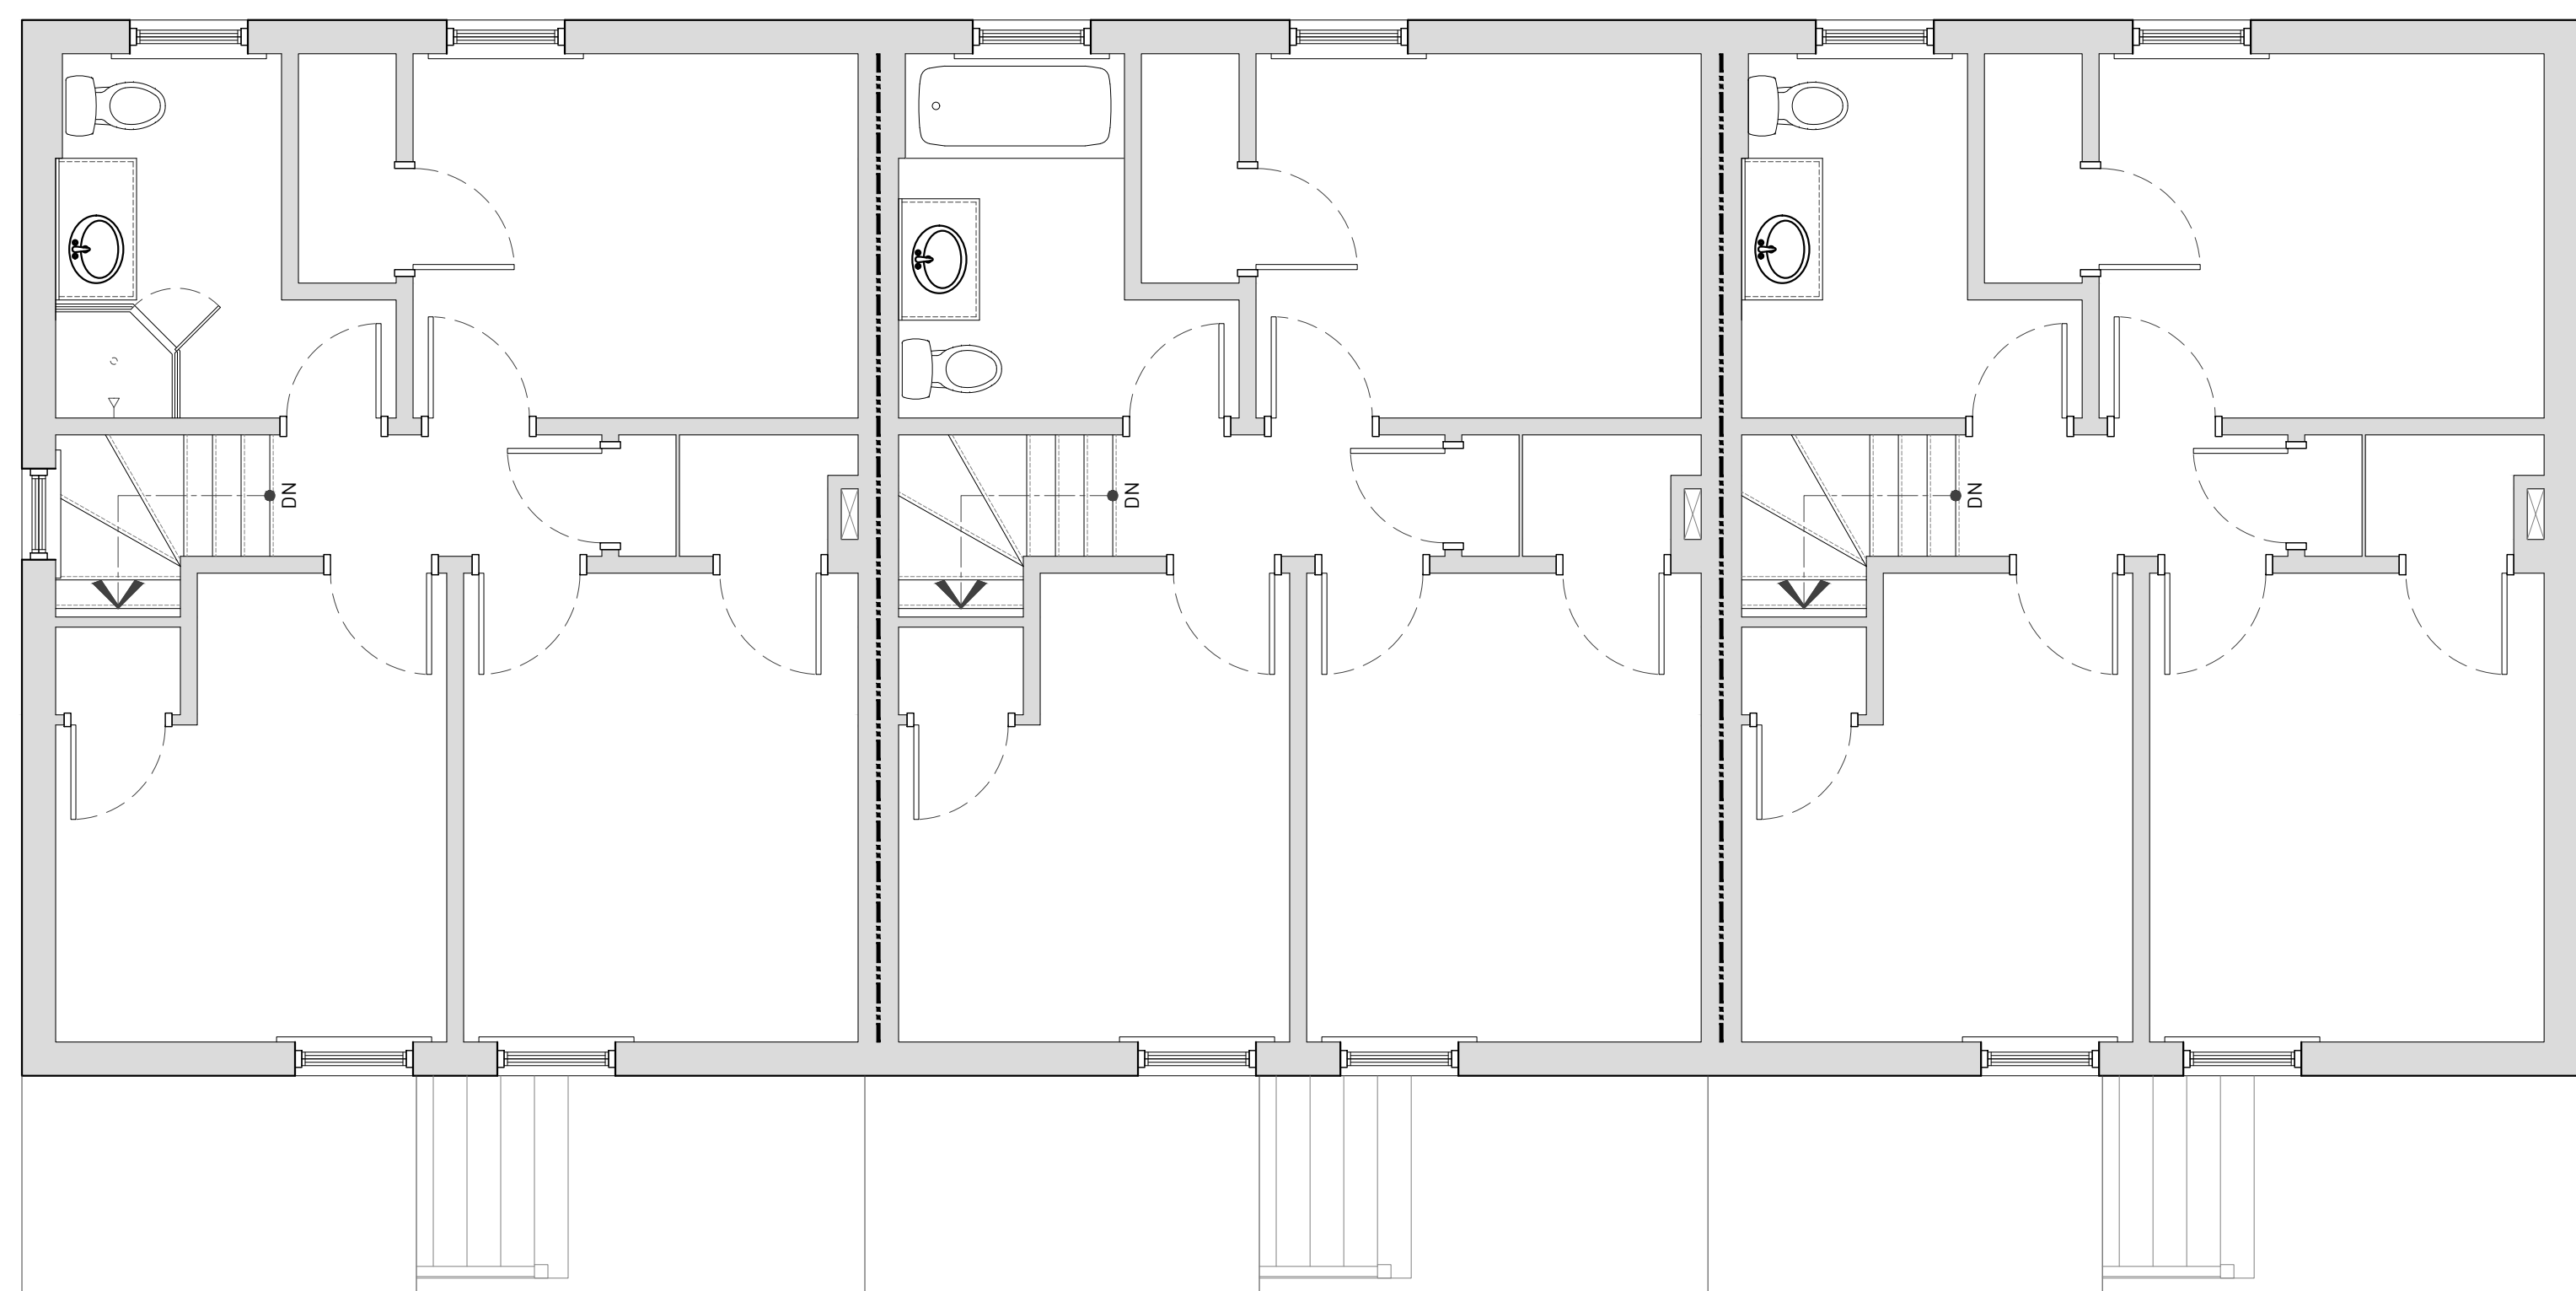


2 SECOND LEVEL PLAN
ORIGINAL IMAGE SCALE: 1/4" = 1'-0"

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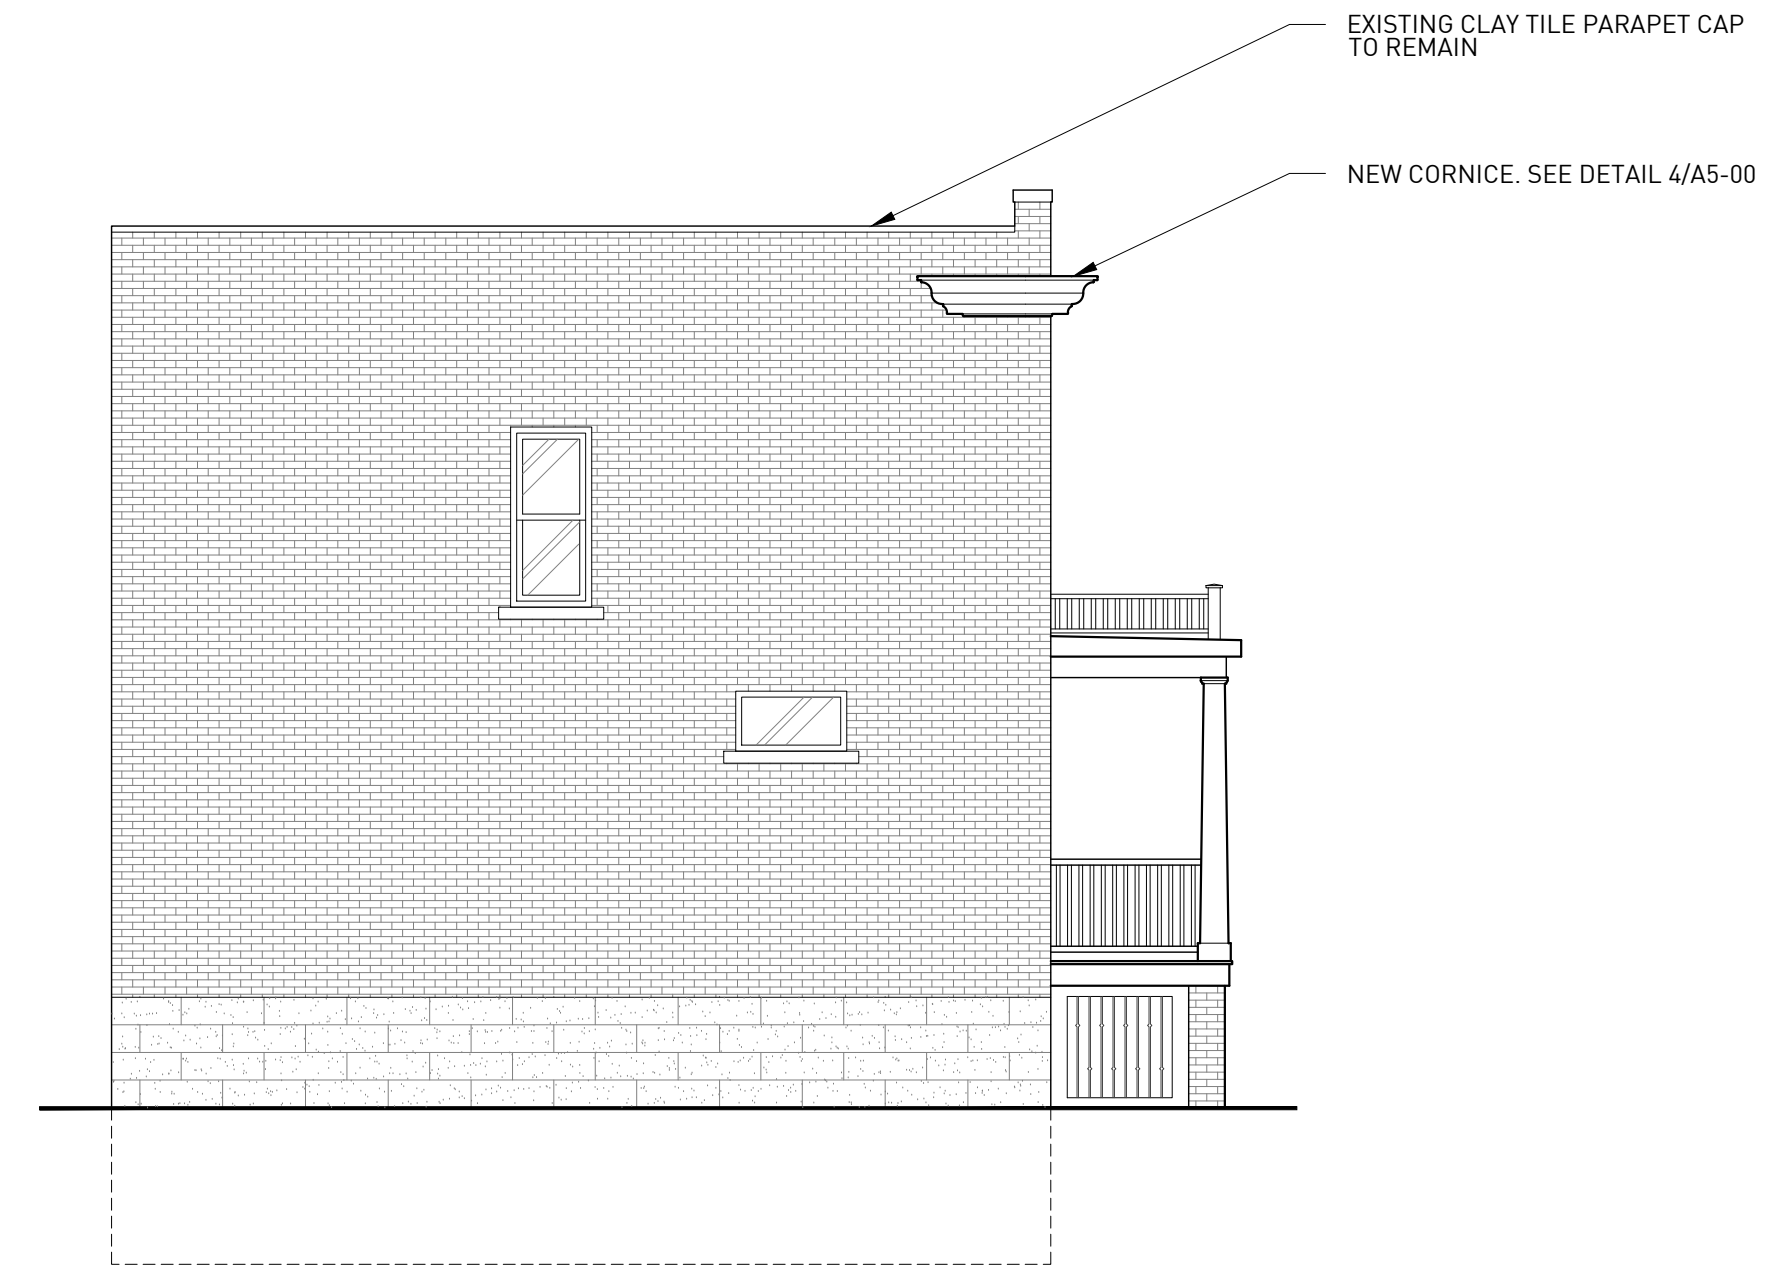


ARCHITECTURE PLANS

A1-00

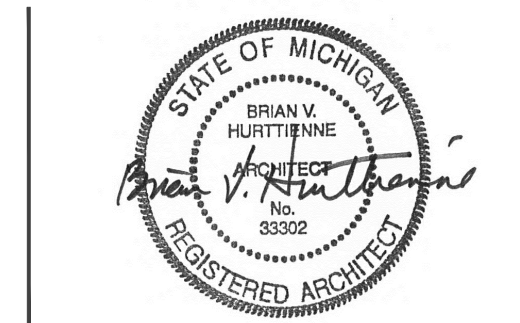


1 EAST ELEVATION
ORIGINAL IMAGE SCALE: 3/16" = 1'-0"



2 SOUTH ELEVATION
ORIGINAL IMAGE SCALE: 3/16" = 1'-0"



3 WEST ELEVATION
ORIGINAL IMAGE SCALE: 3/16" = 1'-0"

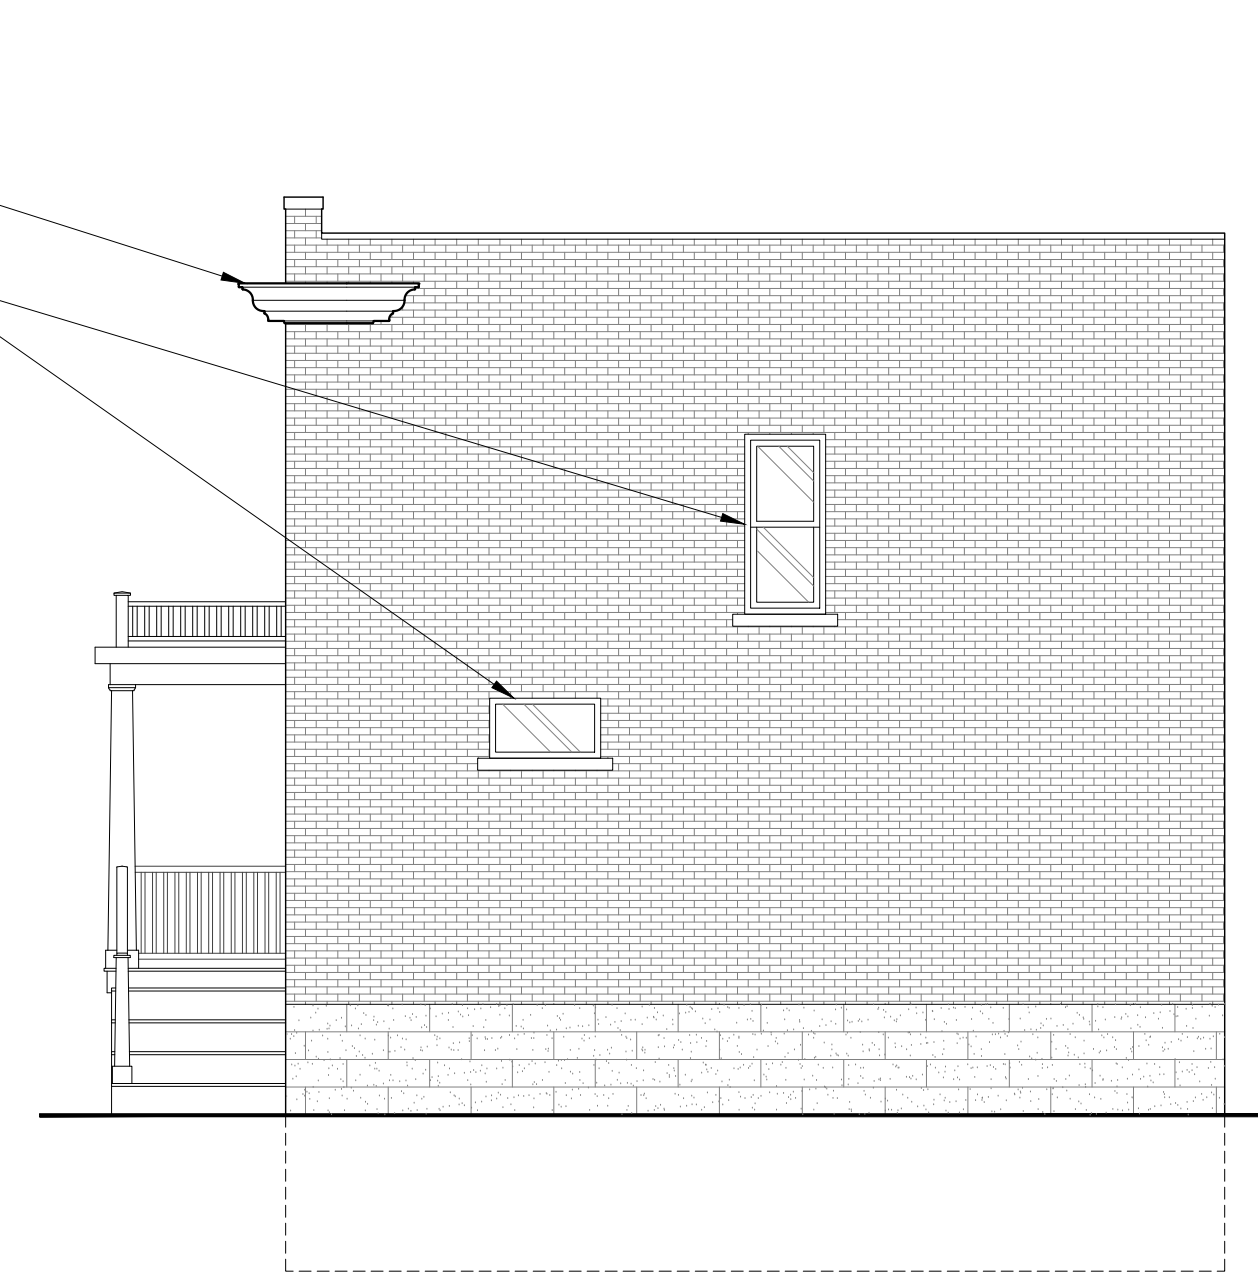

4 NORTH ELEVATION
ORIGINAL IMAGE SCALE: 3/16" = 1'-0"

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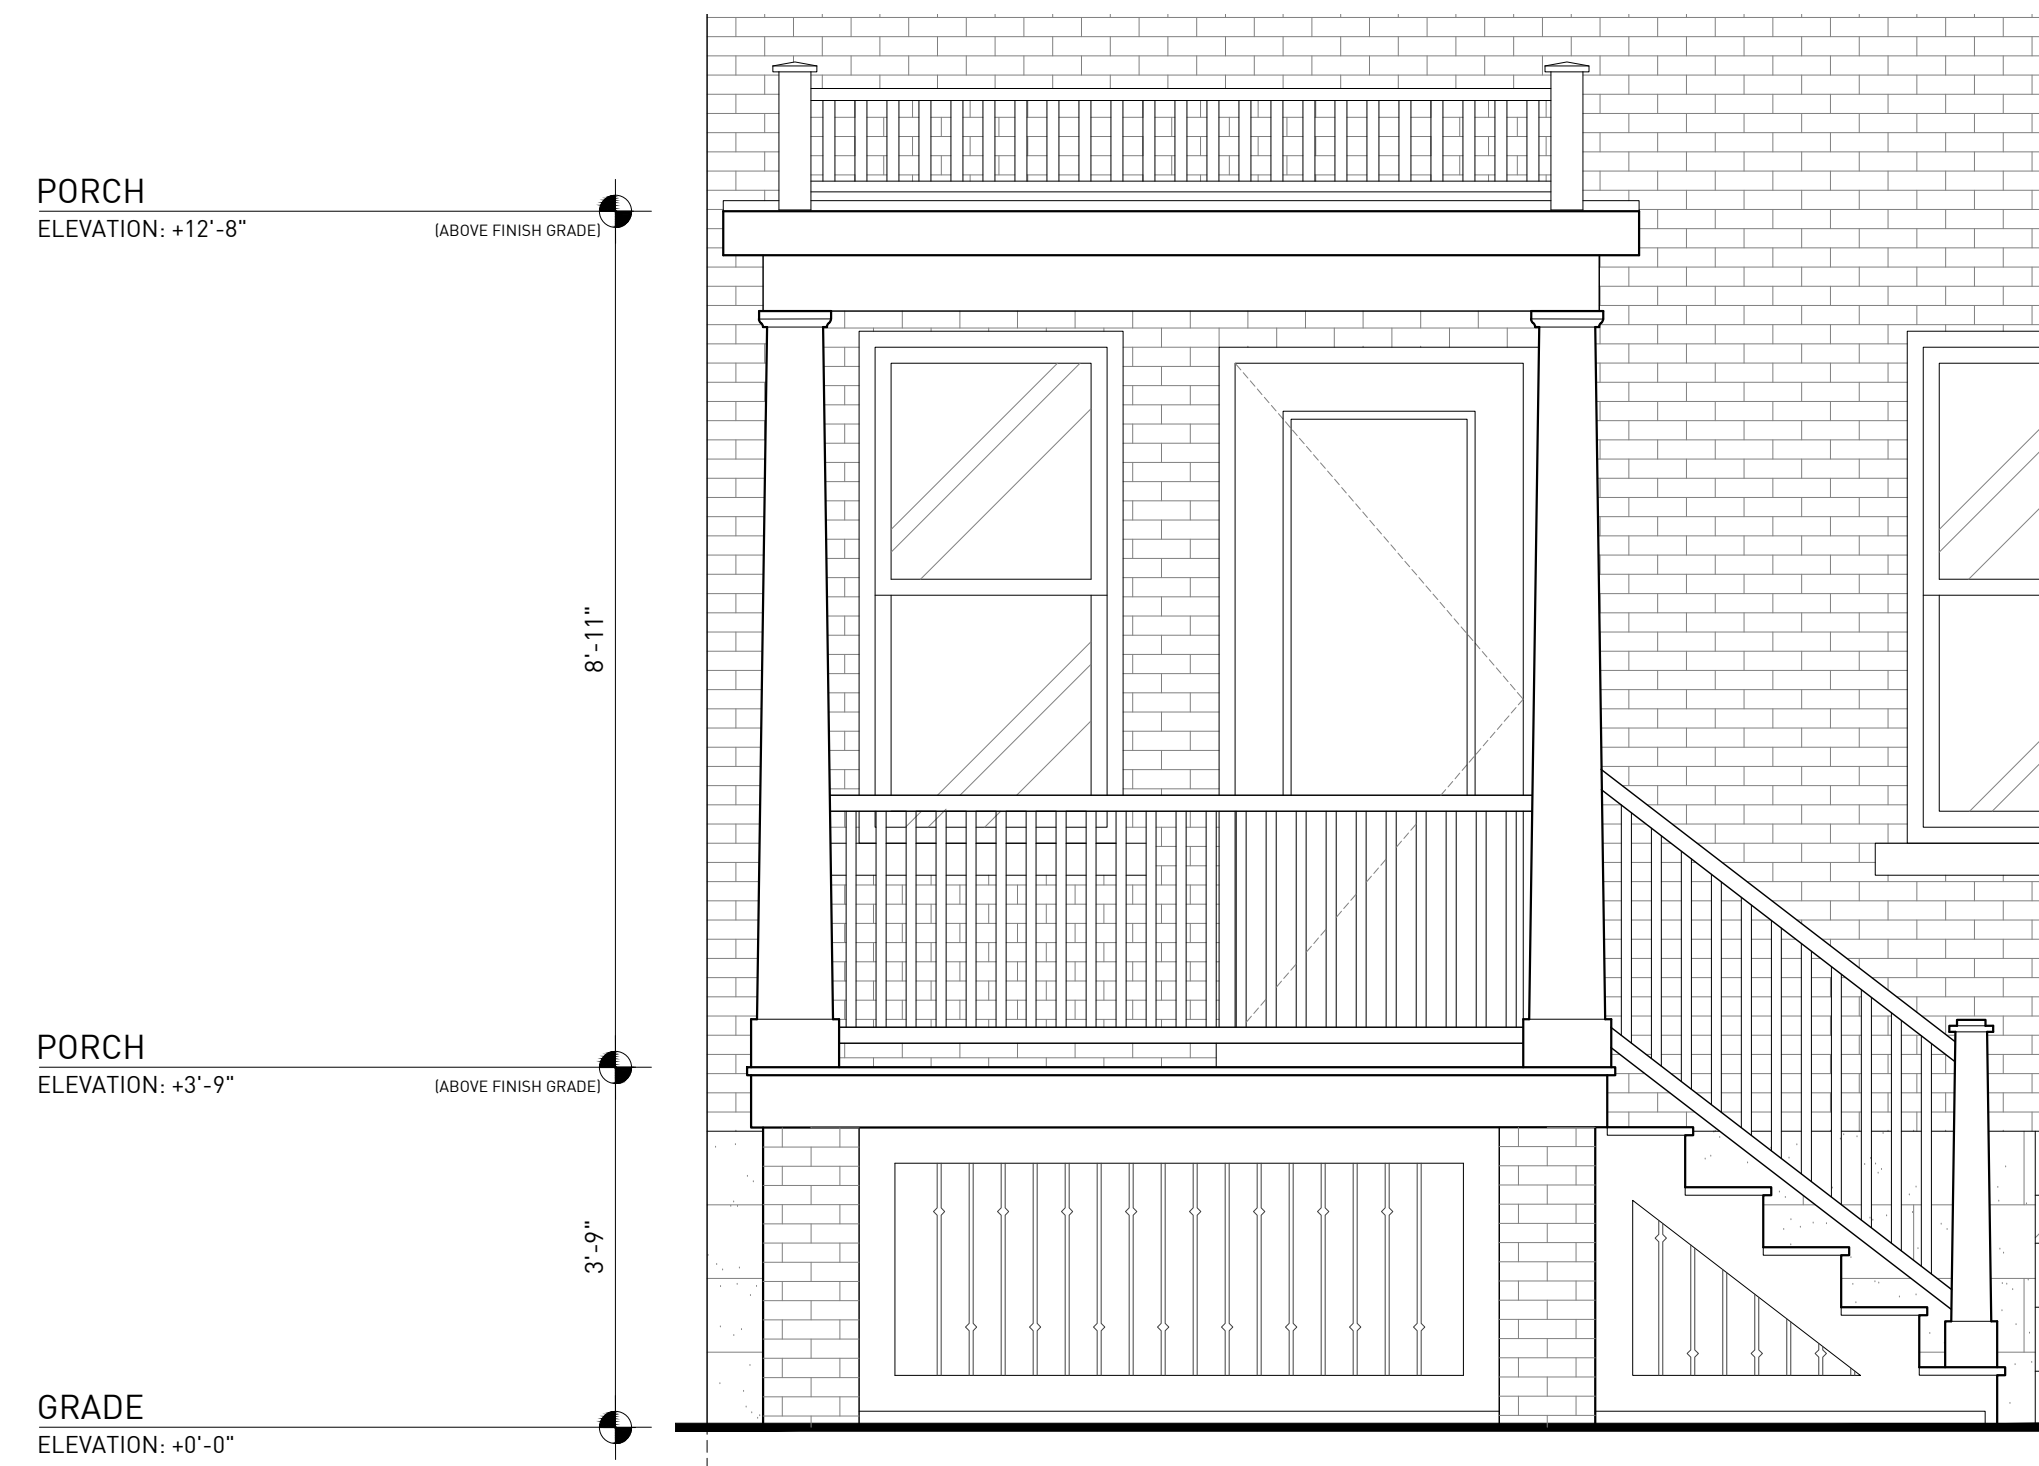
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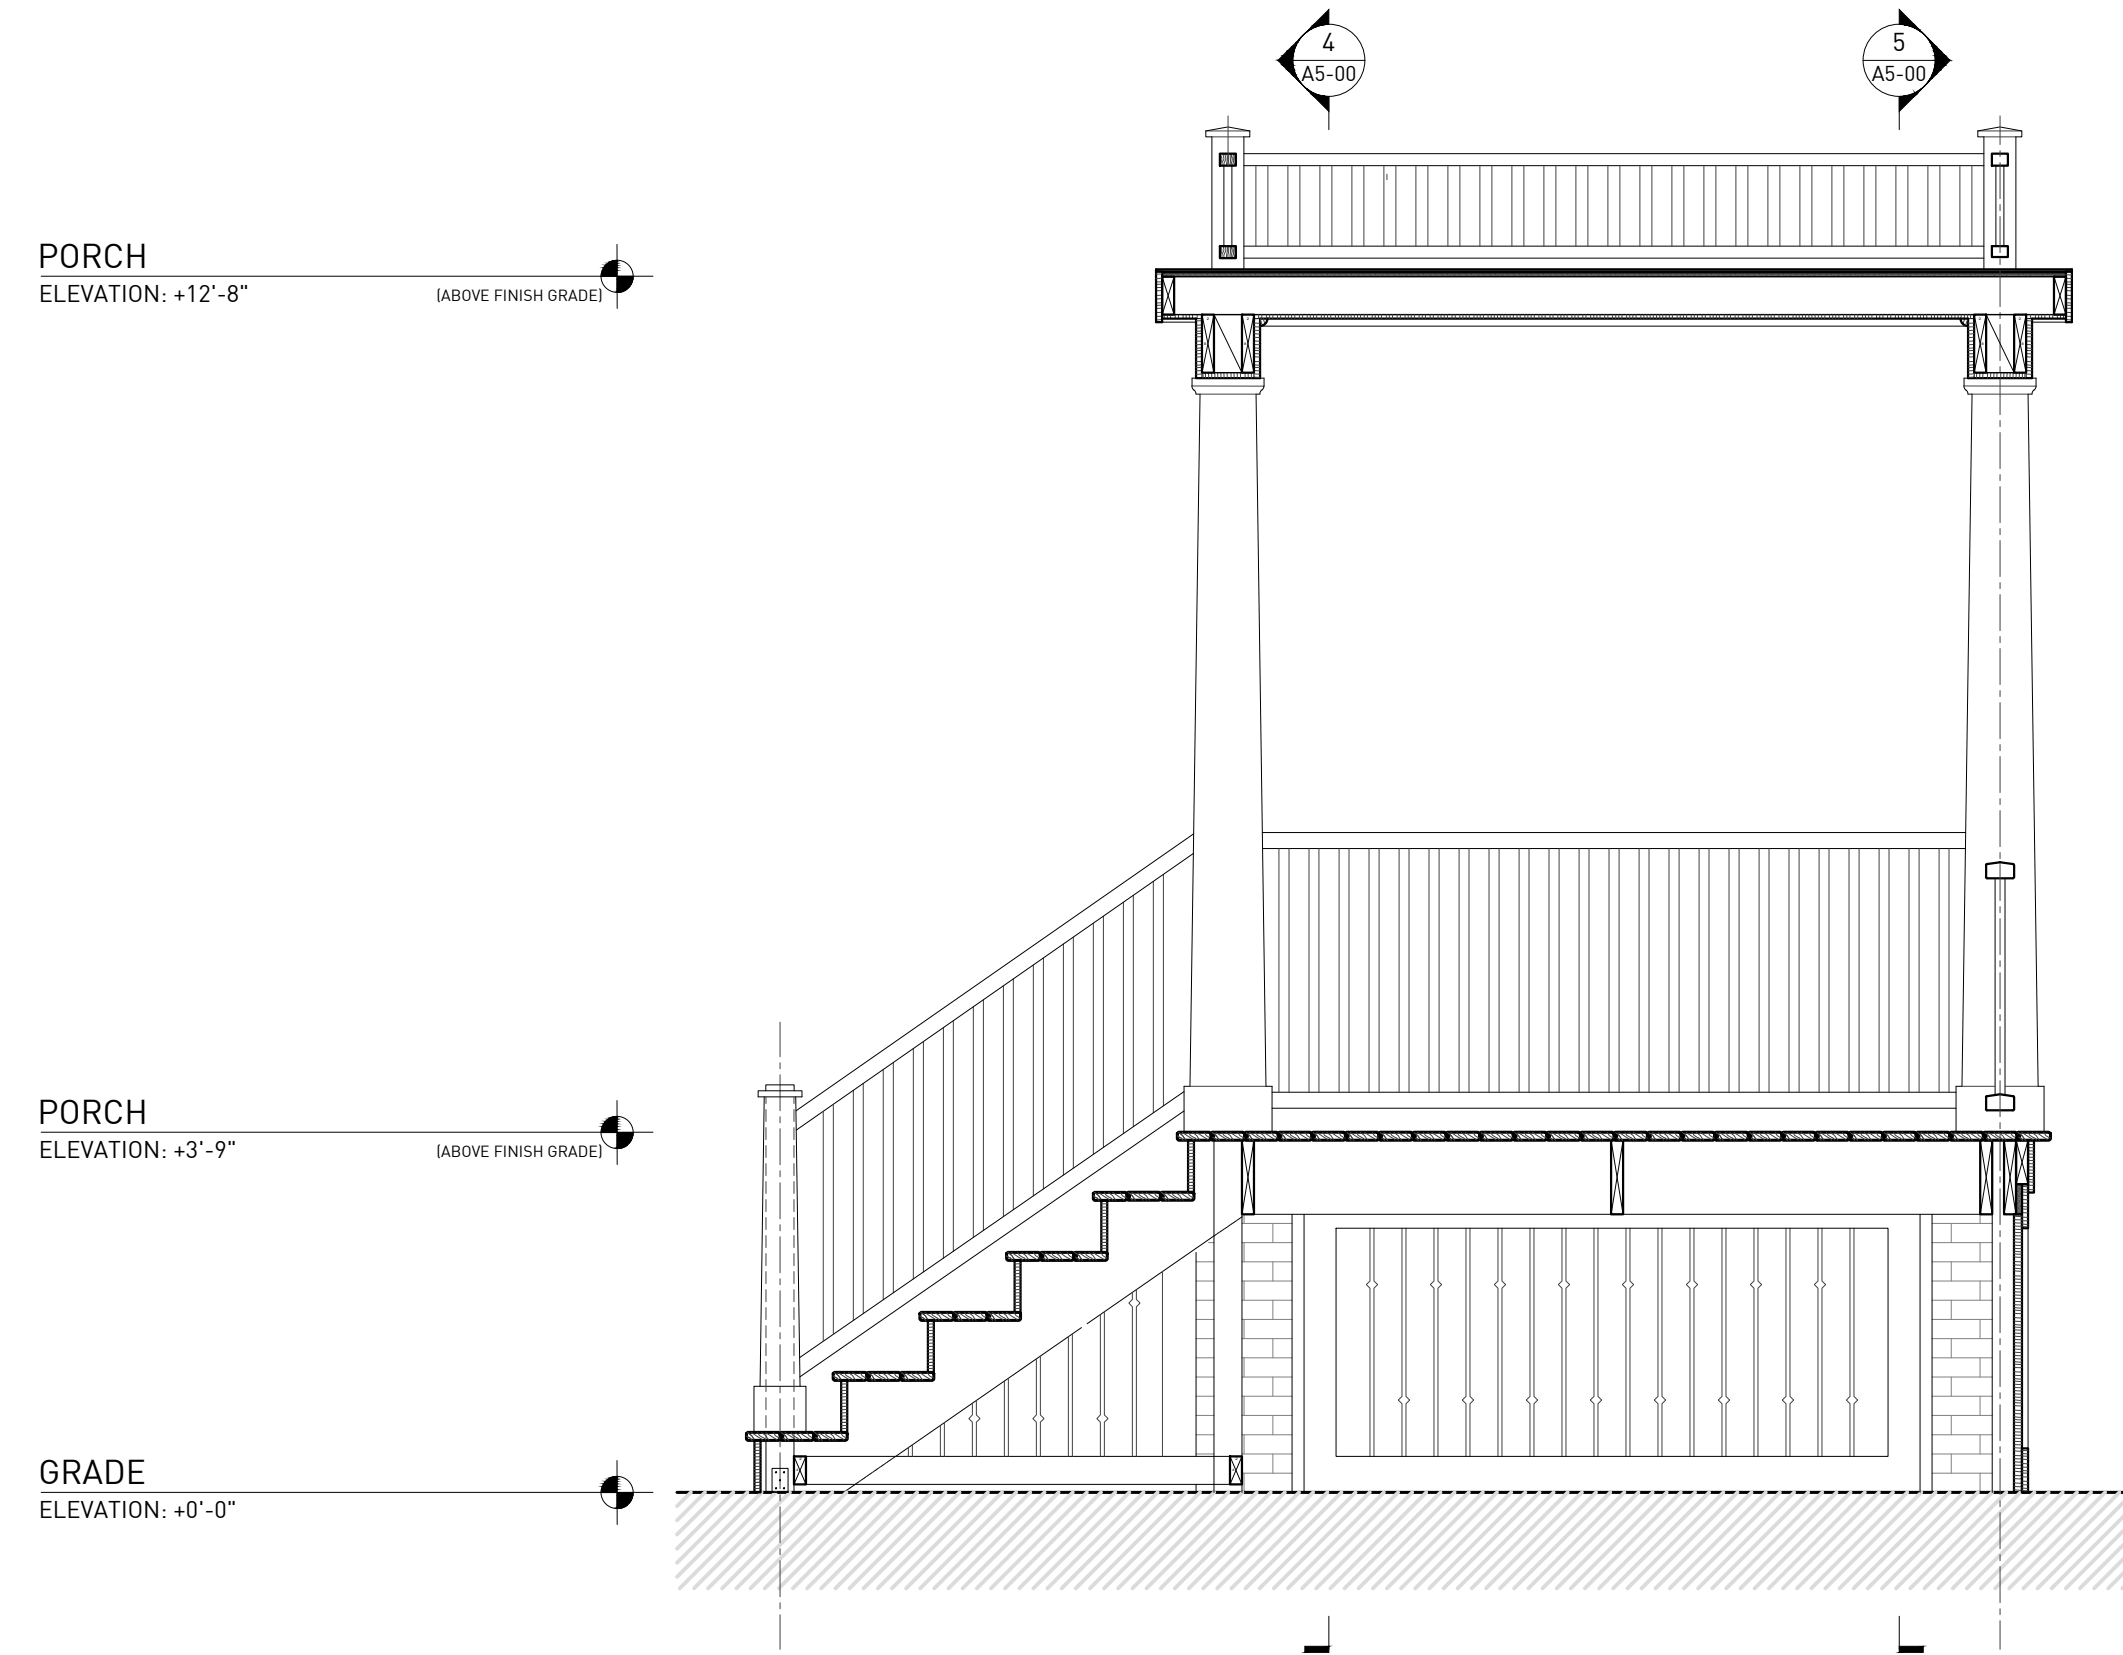


ELEVATIONS AND SECTIONS


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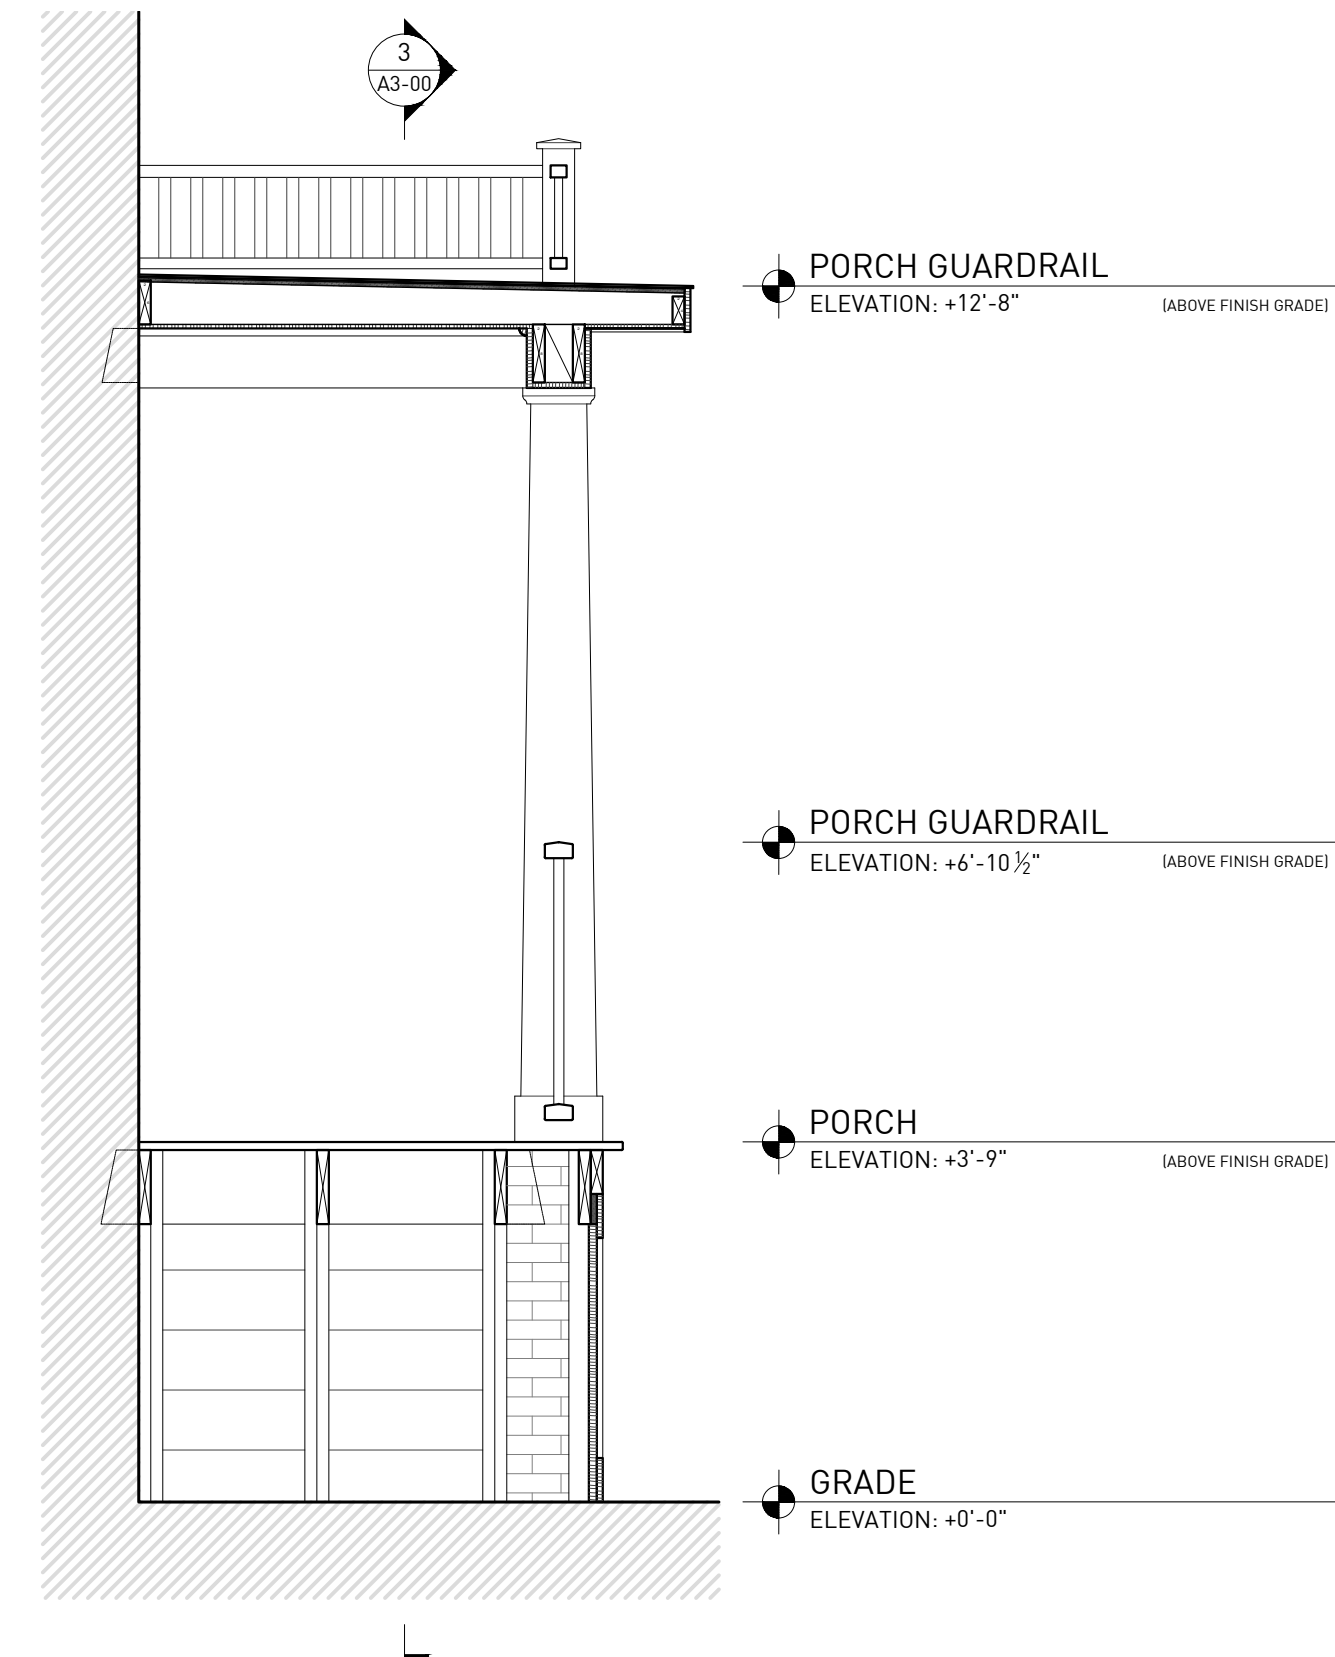
1 ENLARGED PORCH ELEVATION
ORIGINAL IMAGE SCALE: 1/2" = 1'-0"




3 PORCH SECTION
ORIGINAL IMAGE SCALE: 1/2" = 1'-0"



2 ENLARGED PORCH PLAN
ORIGINAL IMAGE SCALE: 1/2" = 1'-0"

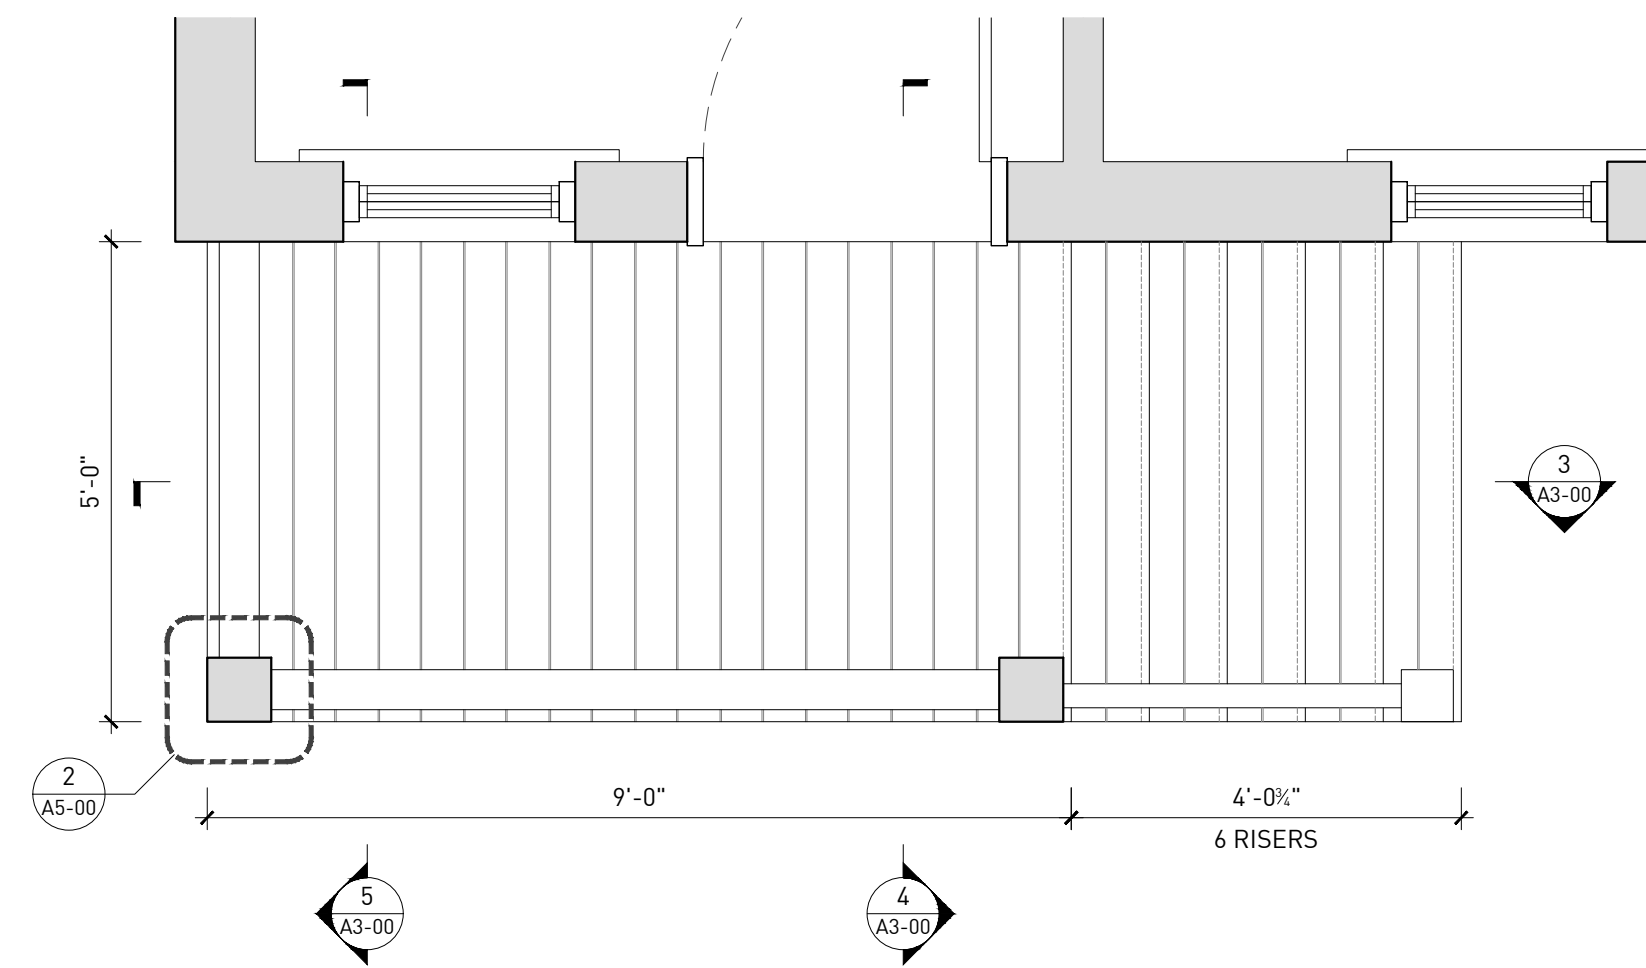

4 PORCH SECTION
ORIGINAL IMAGE SCALE: 1/2" = 1'-0"

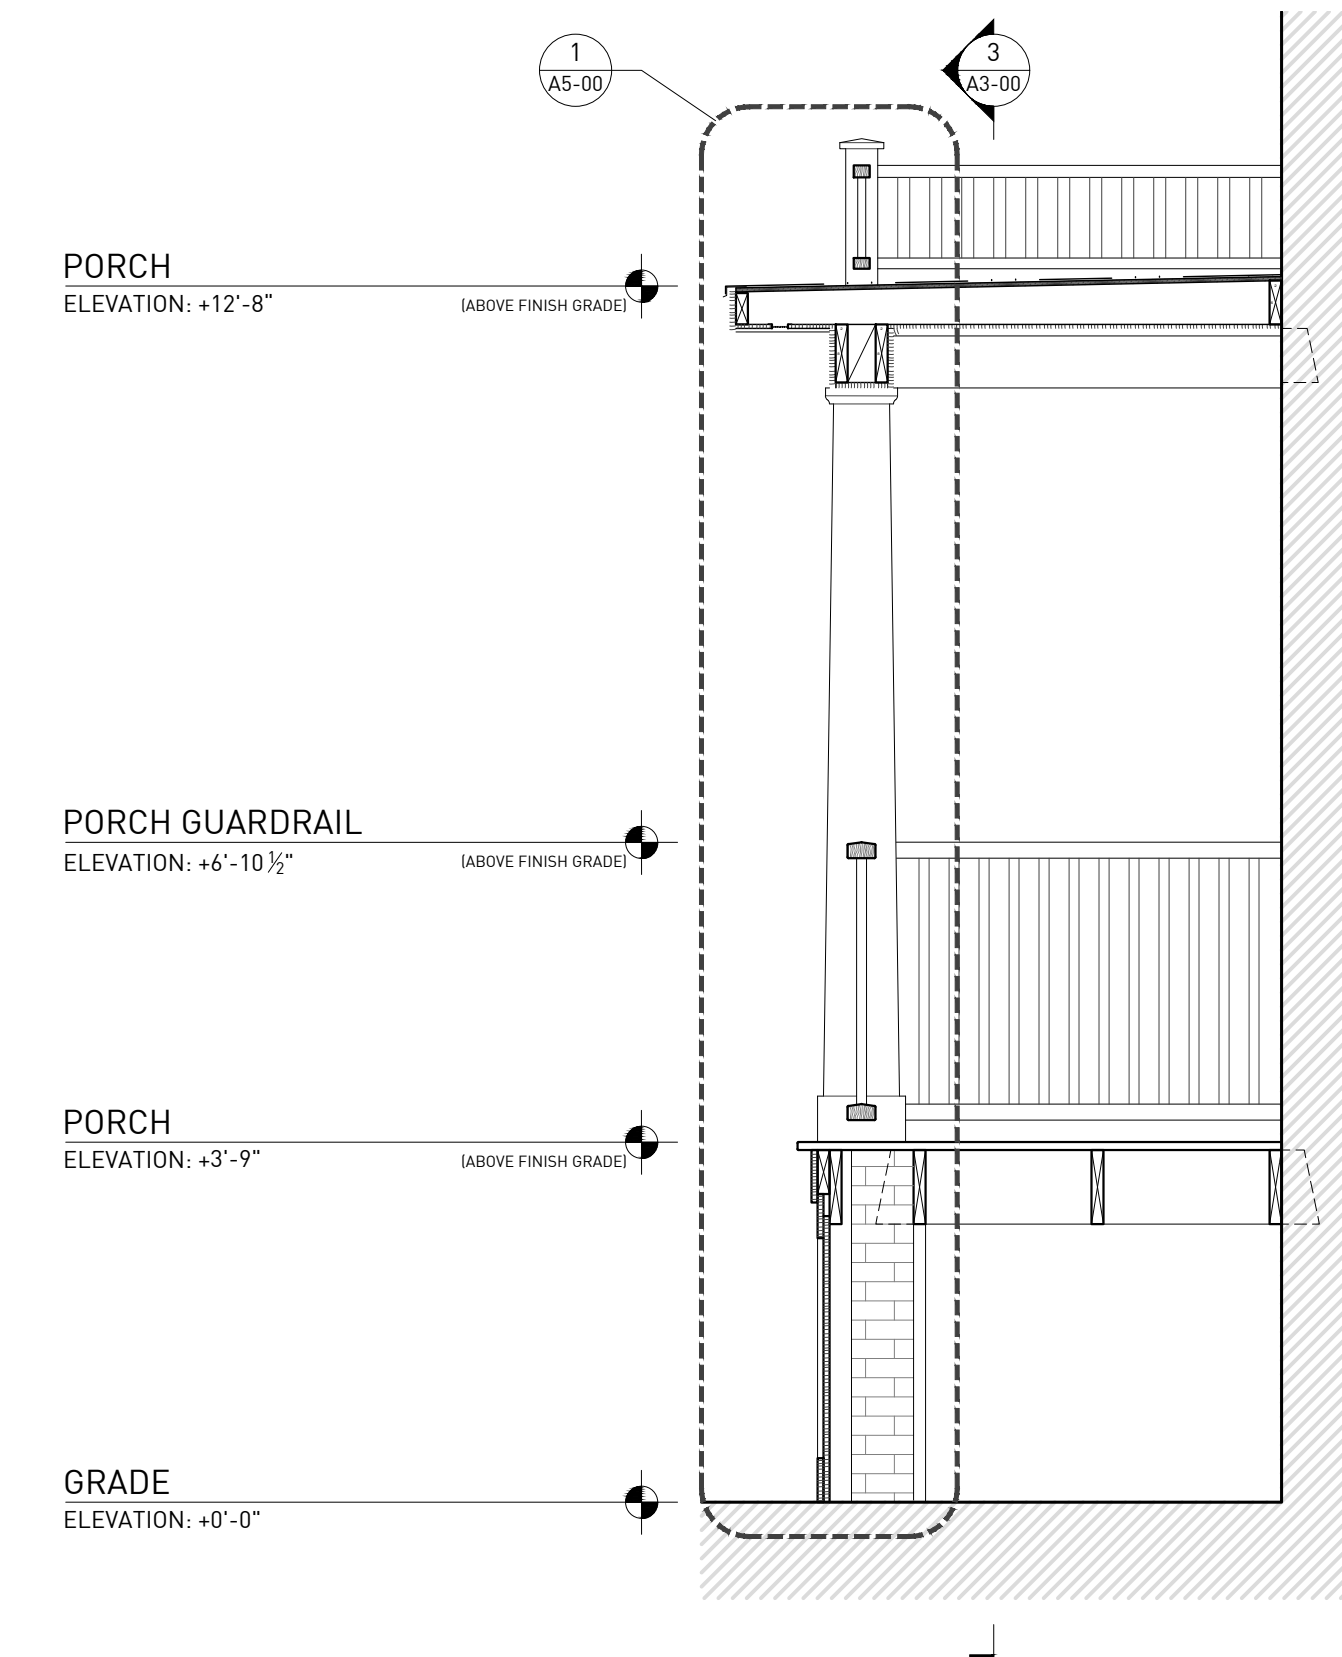

5 PORCH SECTION
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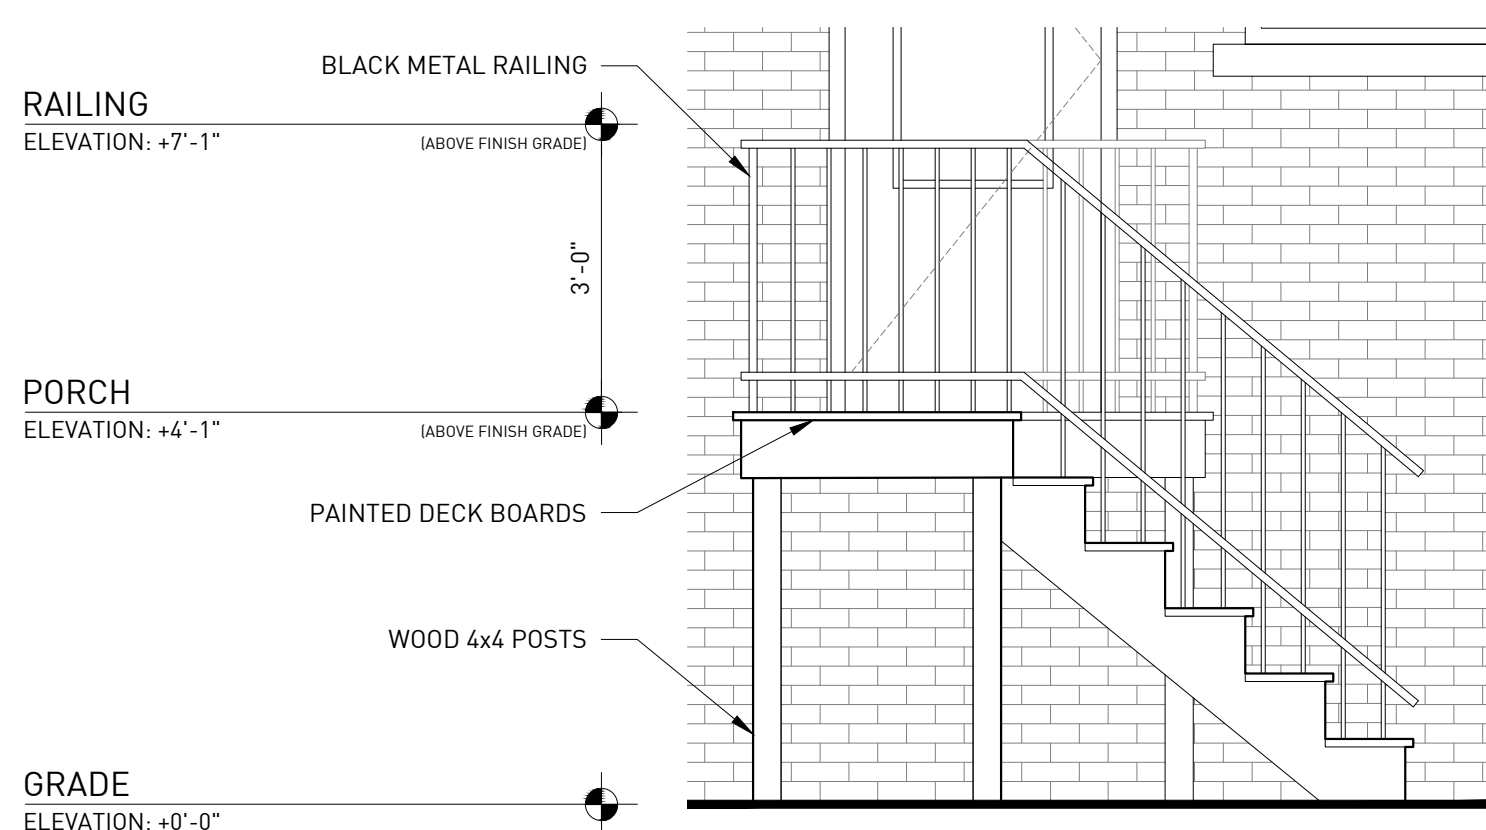
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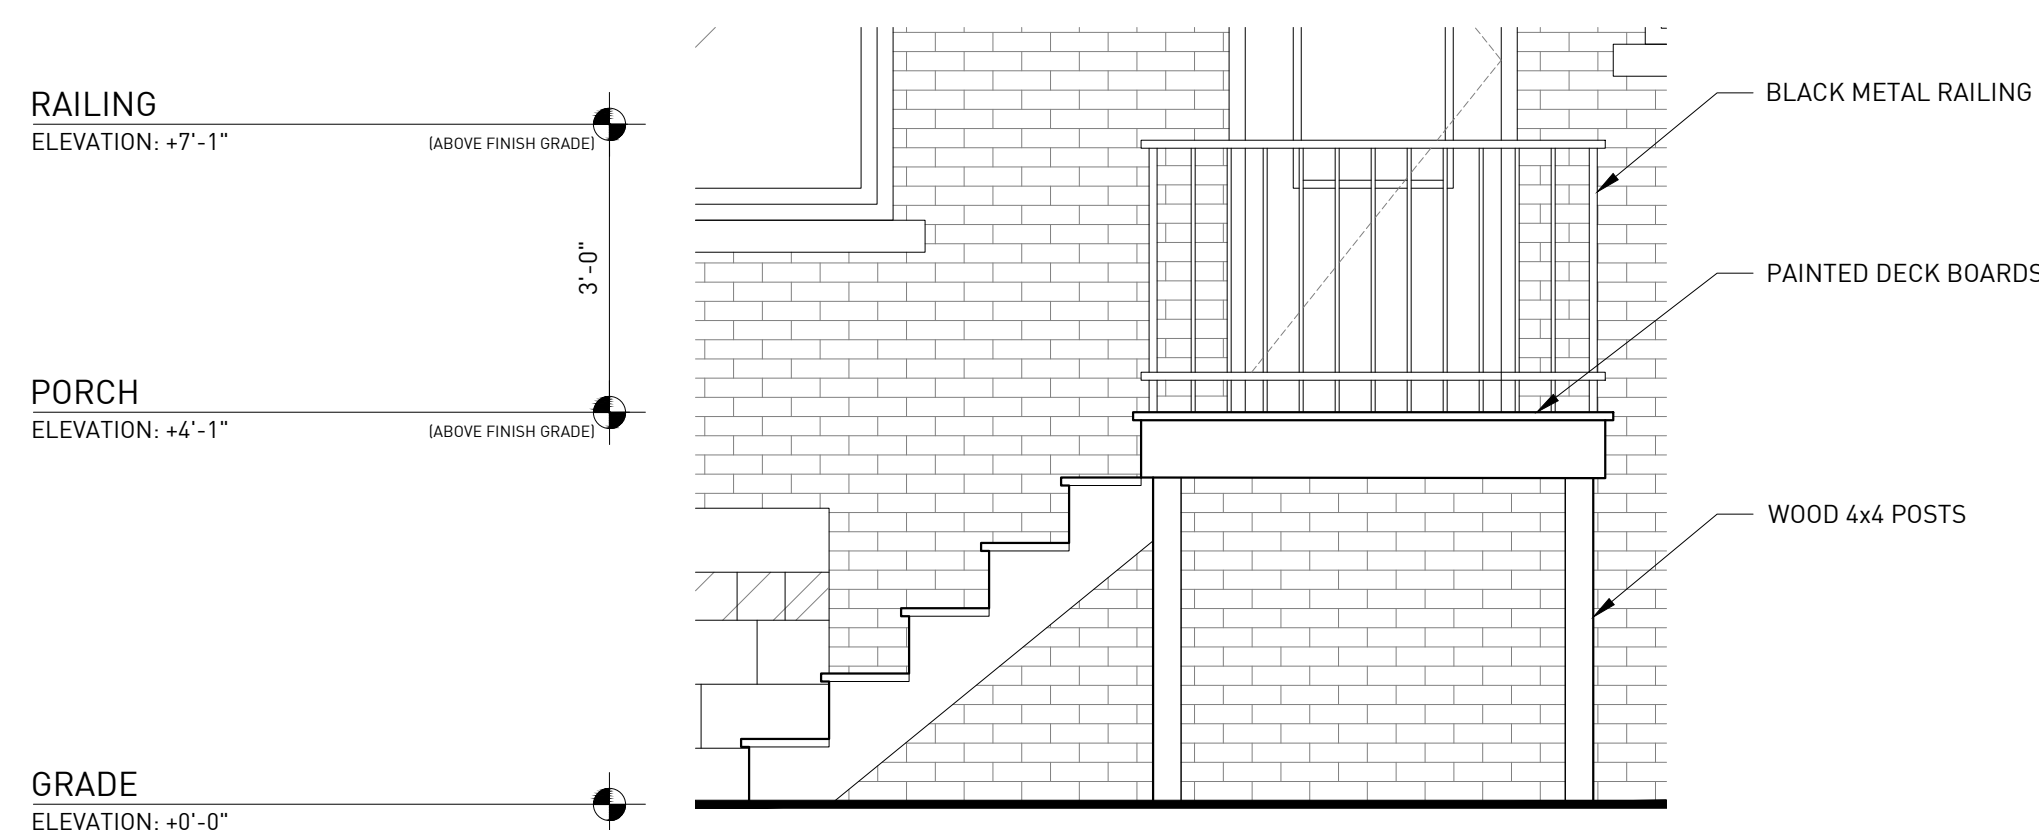
FRONT PORCHES ELEVATIONS AND SECTIONS

DRAWING NO. **A3-00**


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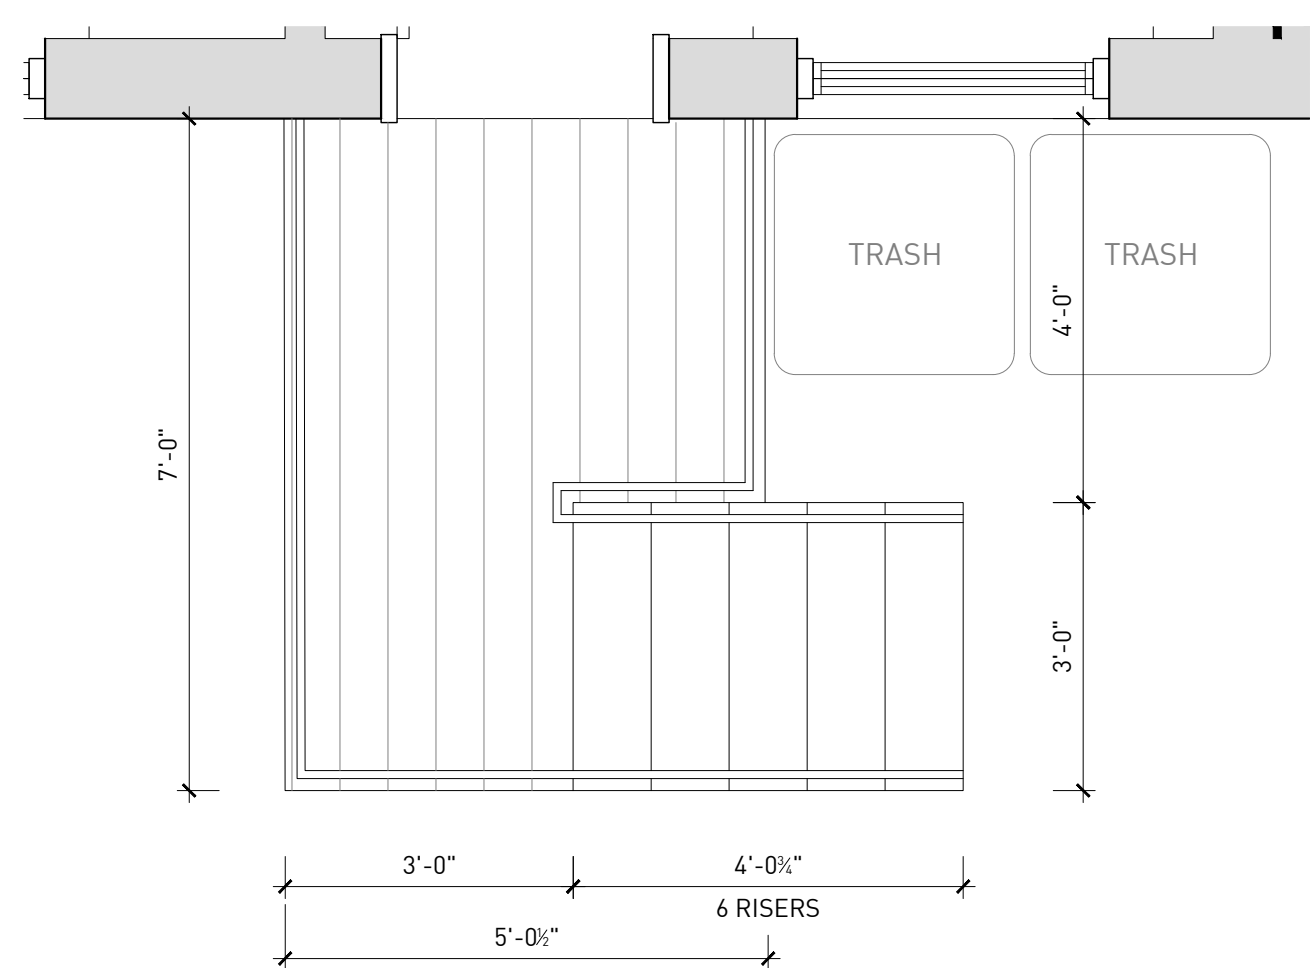
1 ENLARGED PORCH ELEVATION
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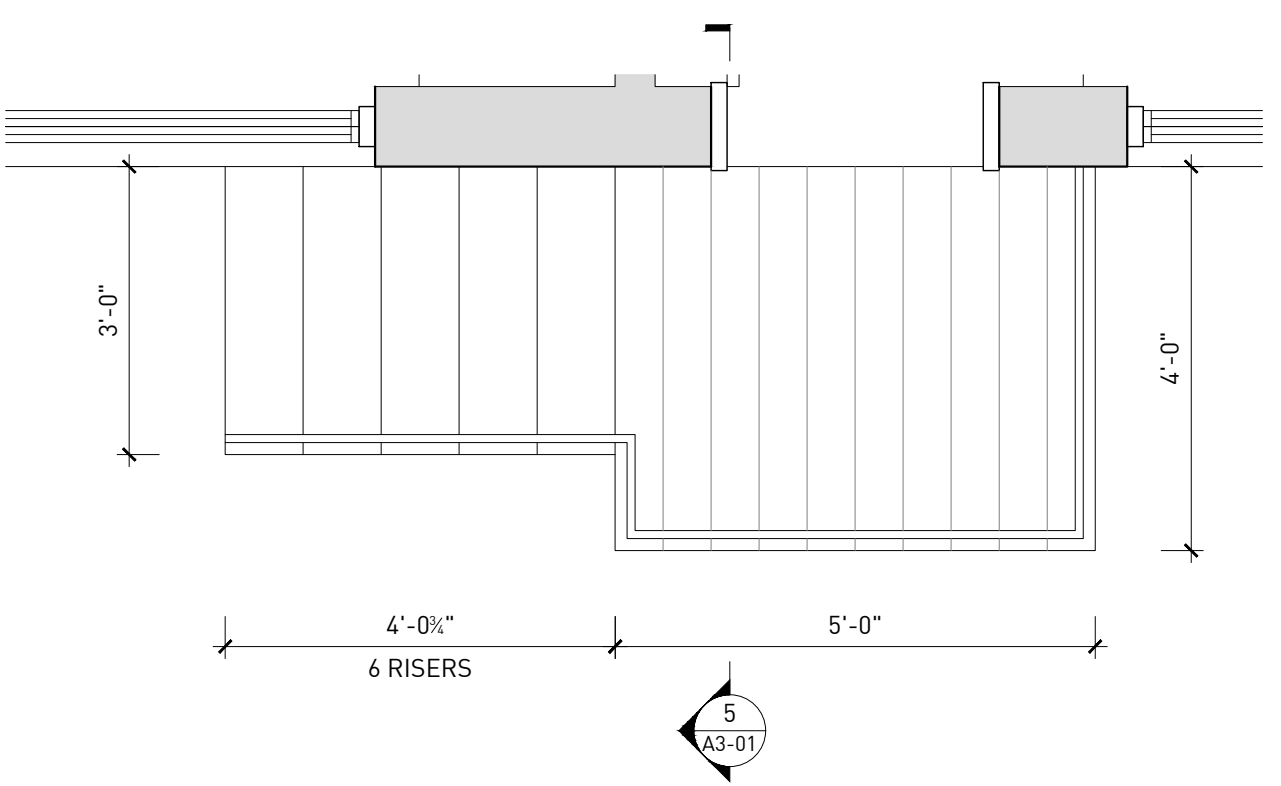
2 ENLARGED PORCH ELEVATION
 ORIGINAL IMAGE SCALE: 1/2" = 1'-0"



5 ENLARGED PORCH SECTION
 ORIGINAL IMAGE SCALE: 1-1/2" = 1'-0"



3 ENLARGED PORCH PLAN
 ORIGINAL IMAGE SCALE: 1/2" = 1'-0"

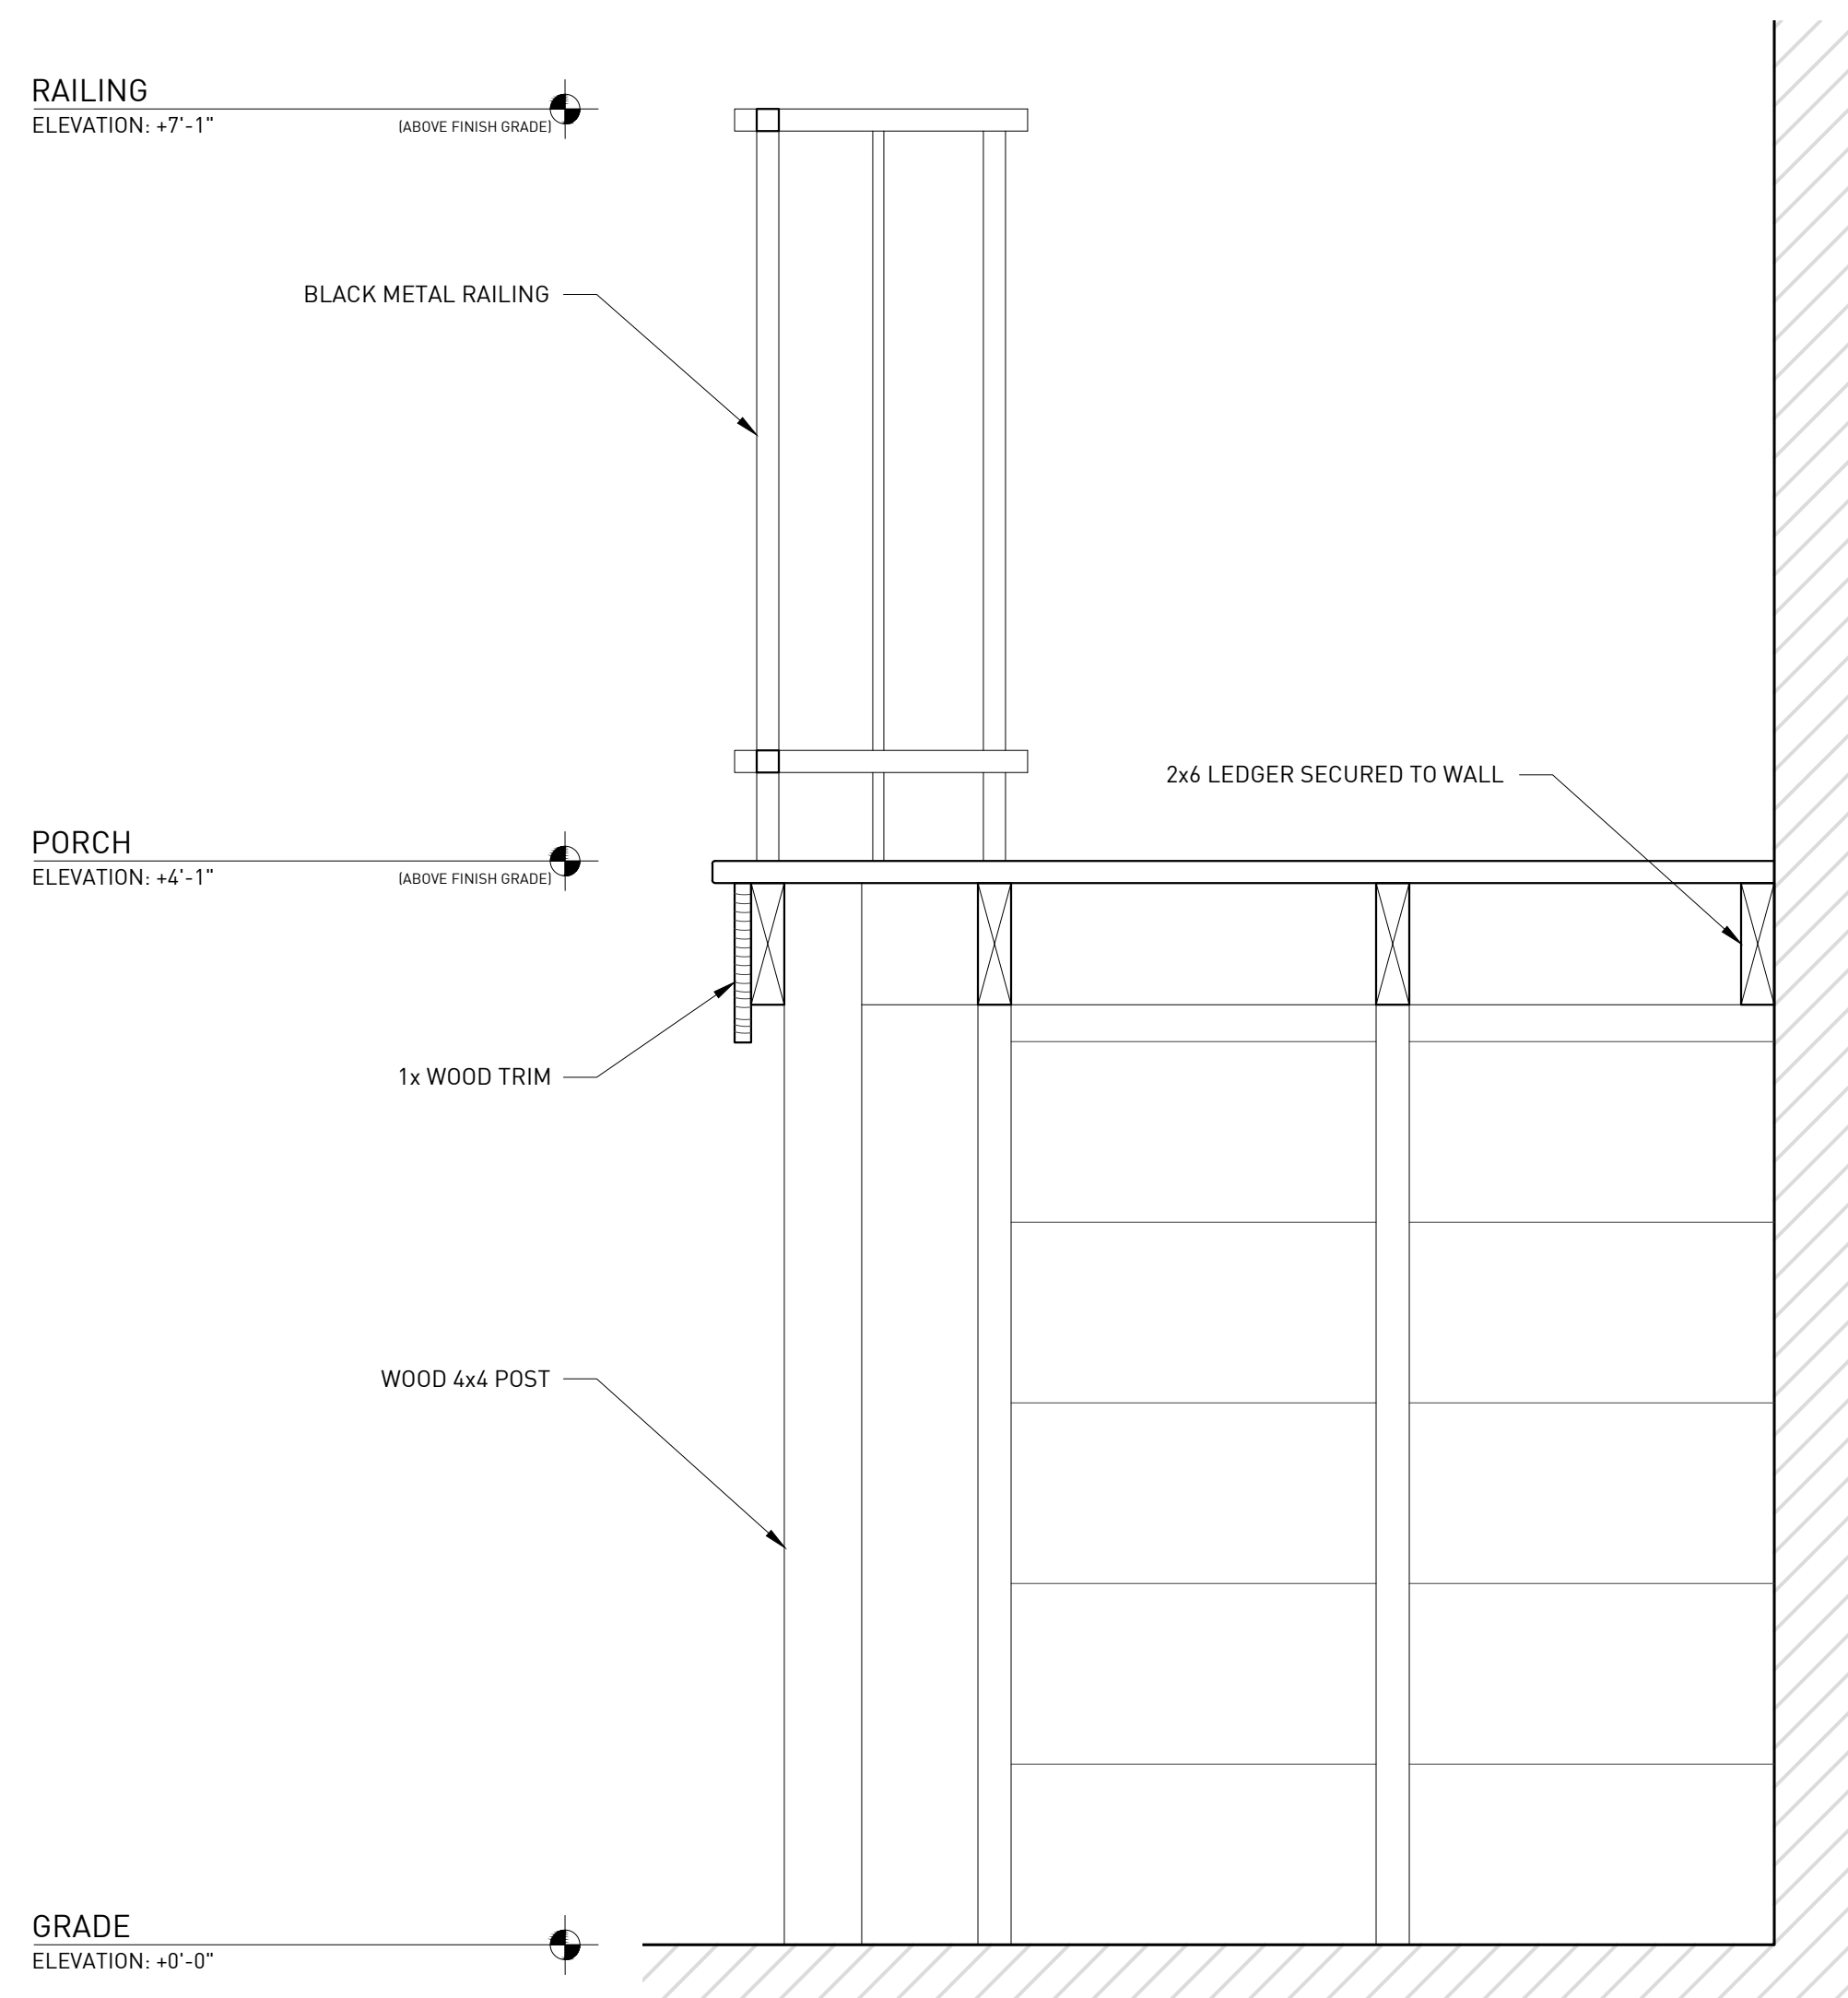

4 ENLARGED PORCH PLAN
 ORIGINAL IMAGE SCALE: 1/2" = 1'-0"

MECHANICAL ENGINEER
 STRUCTURAL ENGINEER

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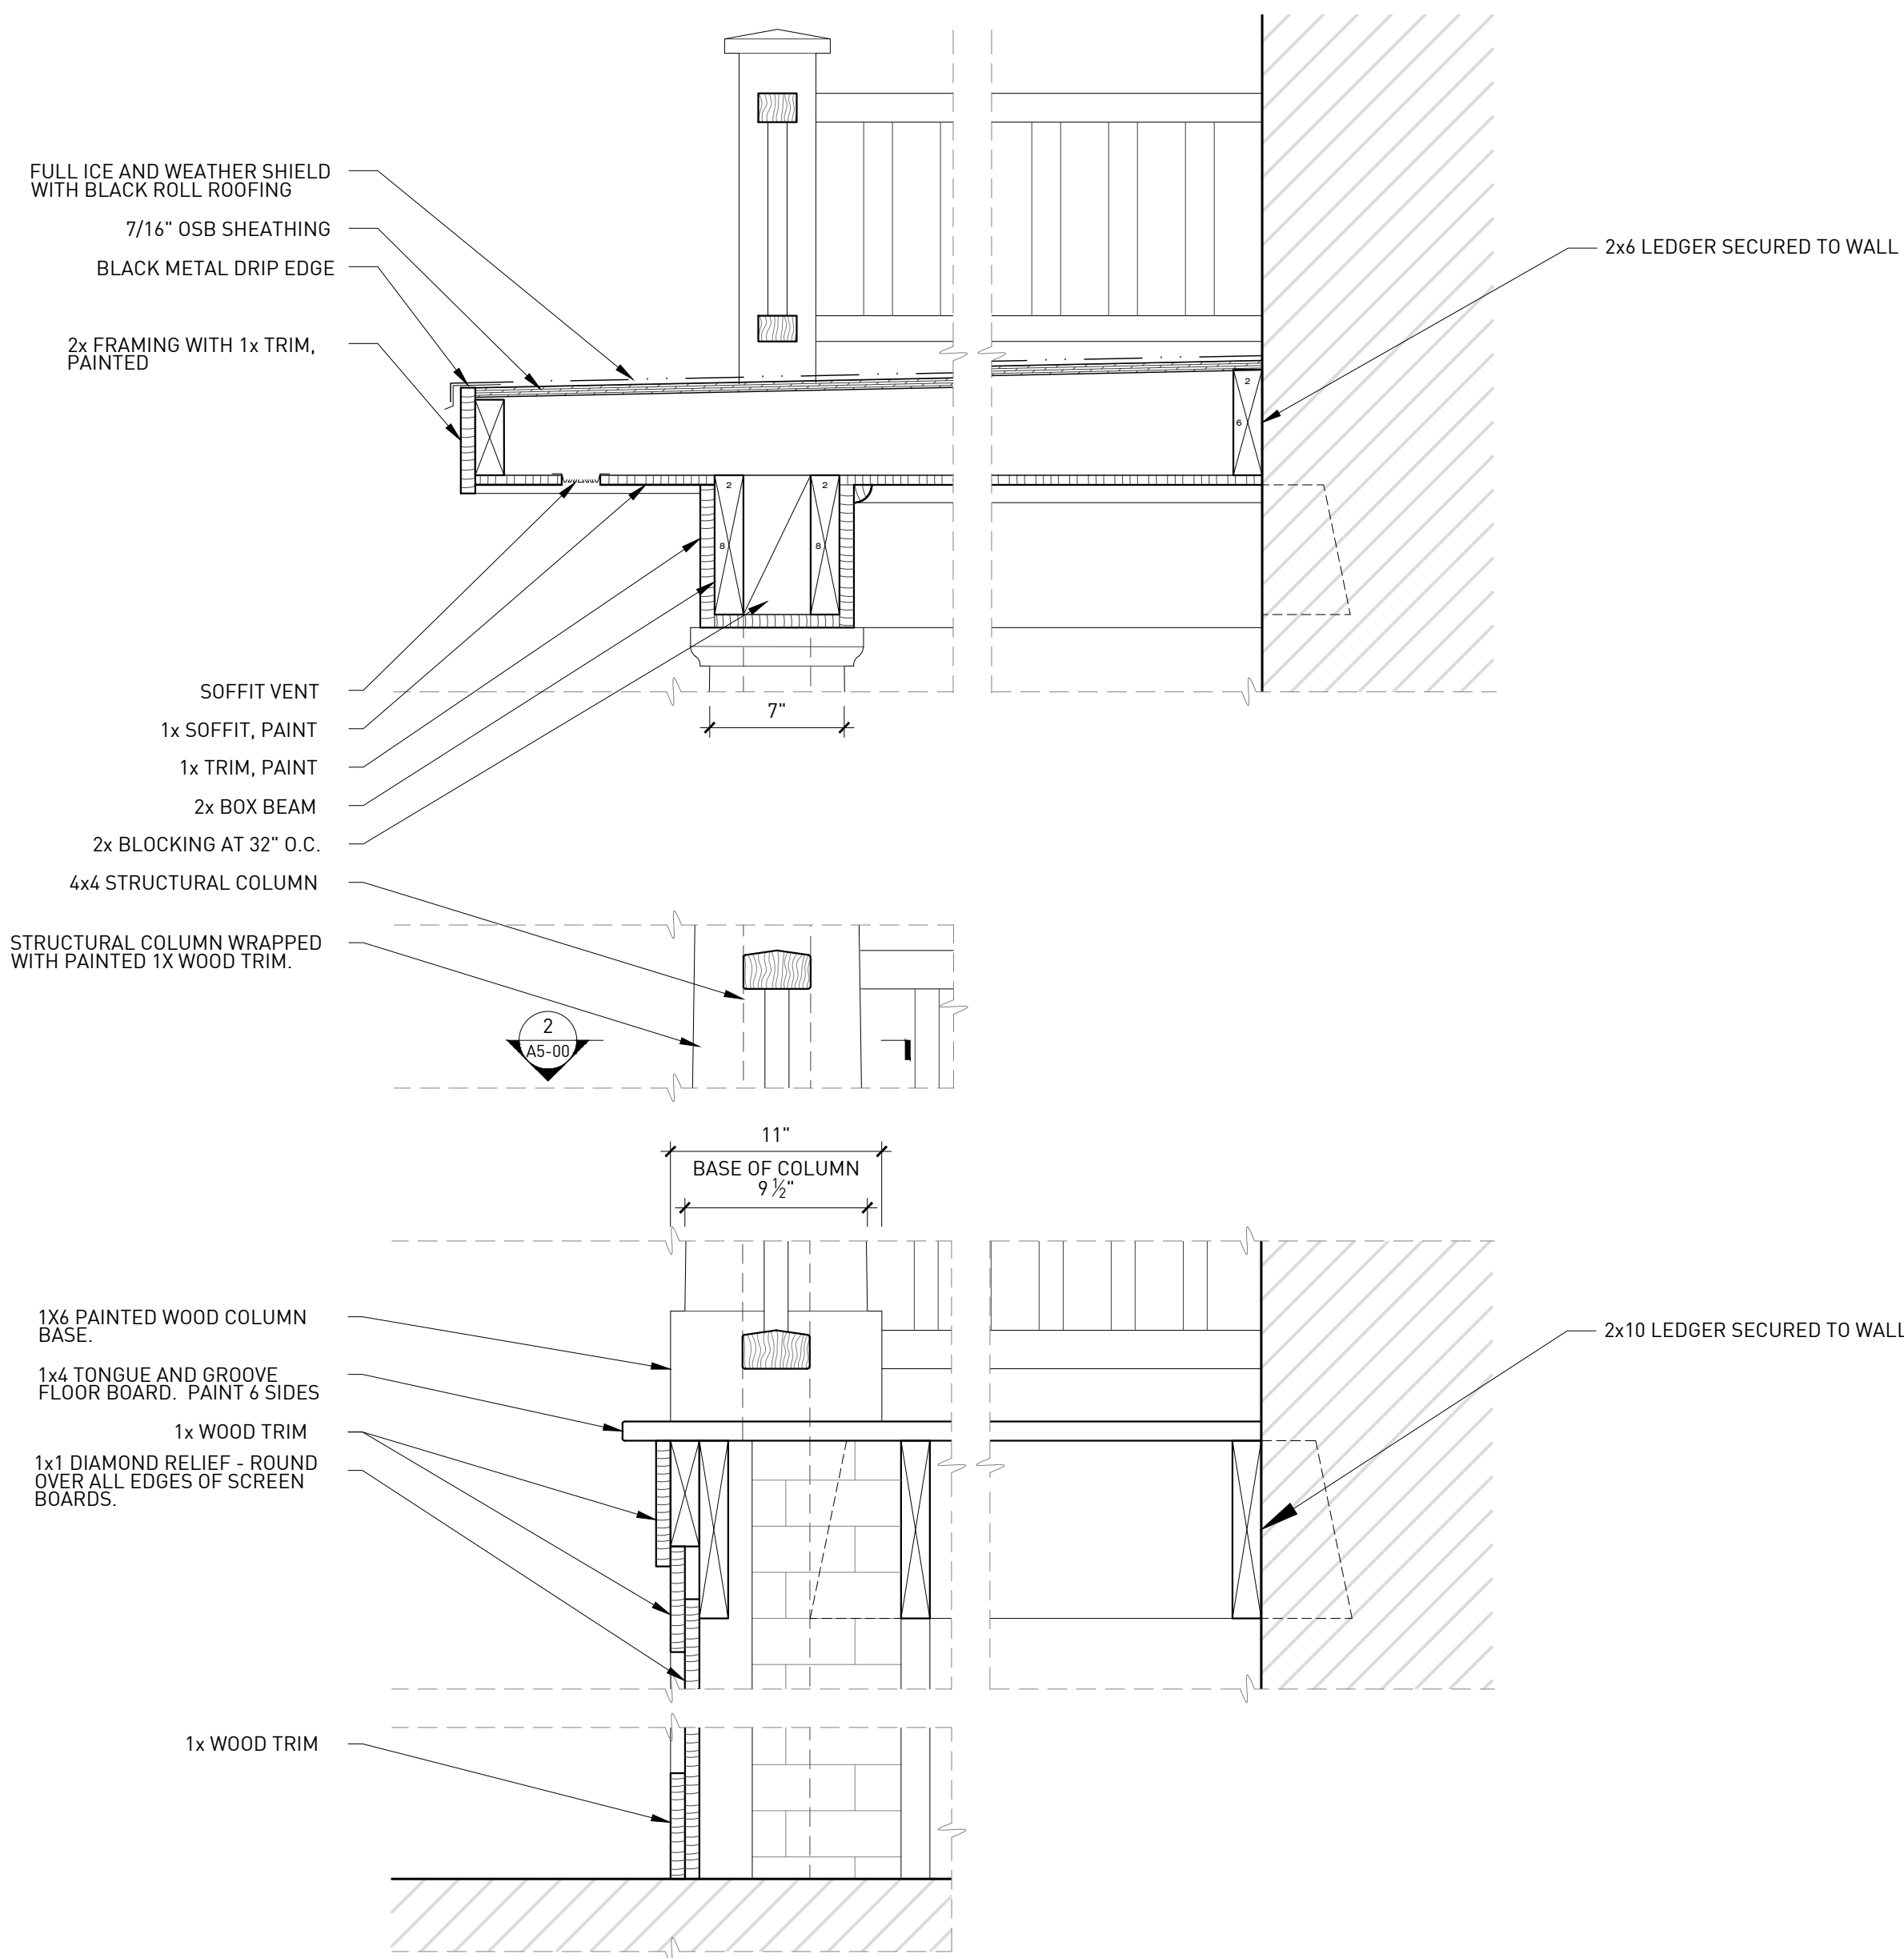
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1.	20201118	PERMIT REVIEW




REAR PORCHES
 ELEVATIONS AND
 SECTIONS


DRAWING NO. **A3-01**




1 PORCH SECTION DETAILS
ORIGINAL IMAGE SCALE: 1 1/2" = 1'-0"

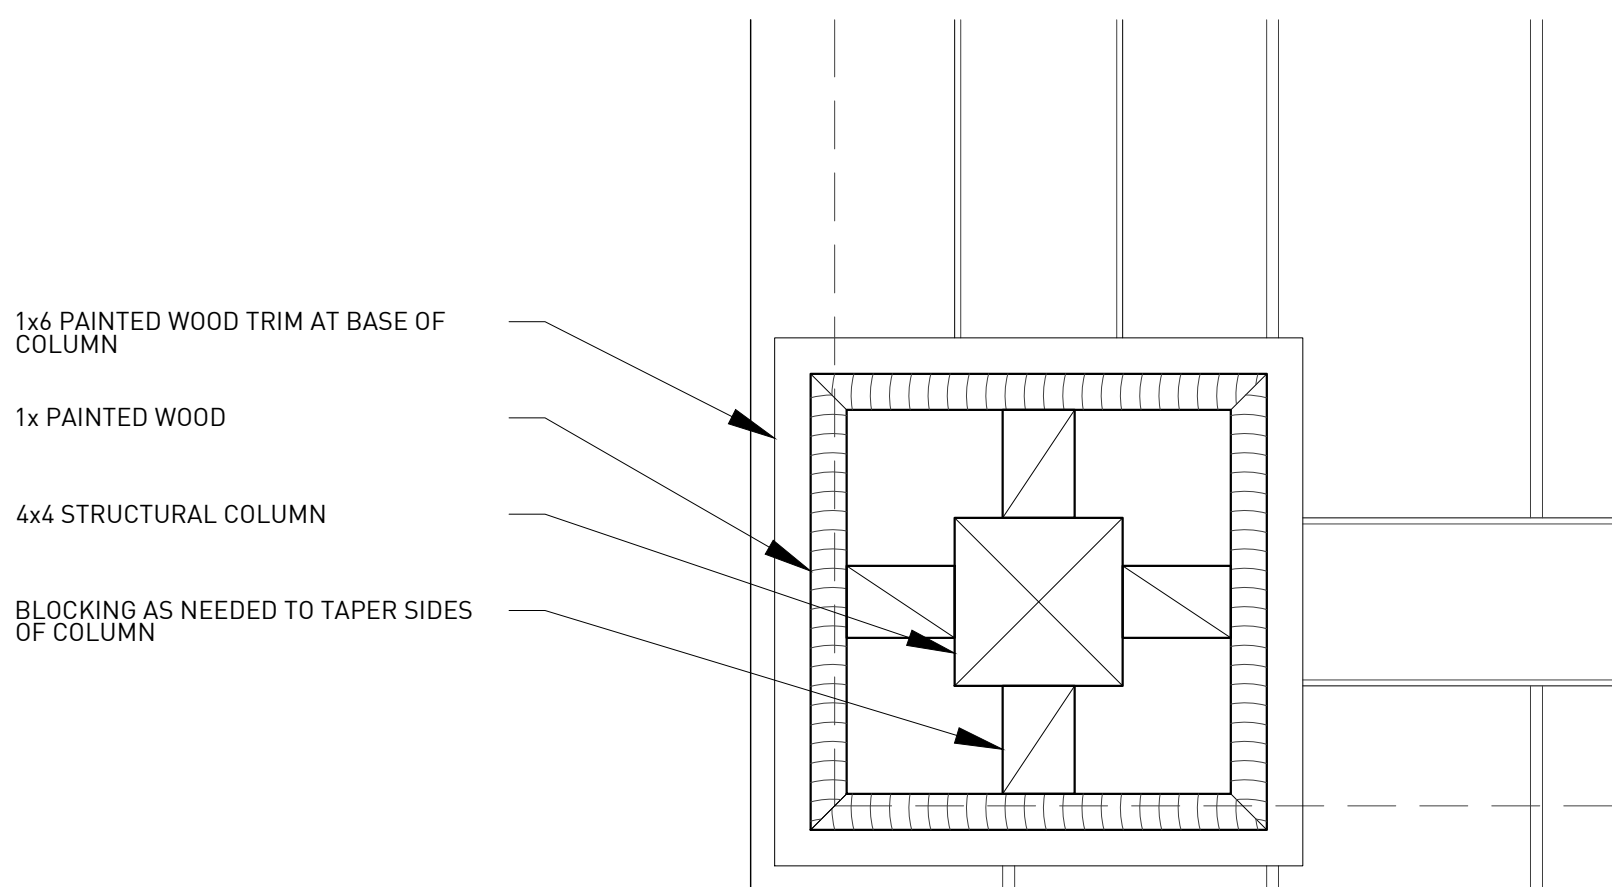

2 PORCH COLUMN PLAN DETAIL
ORIGINAL IMAGE SCALE: 1 1/2" = 1'-0"

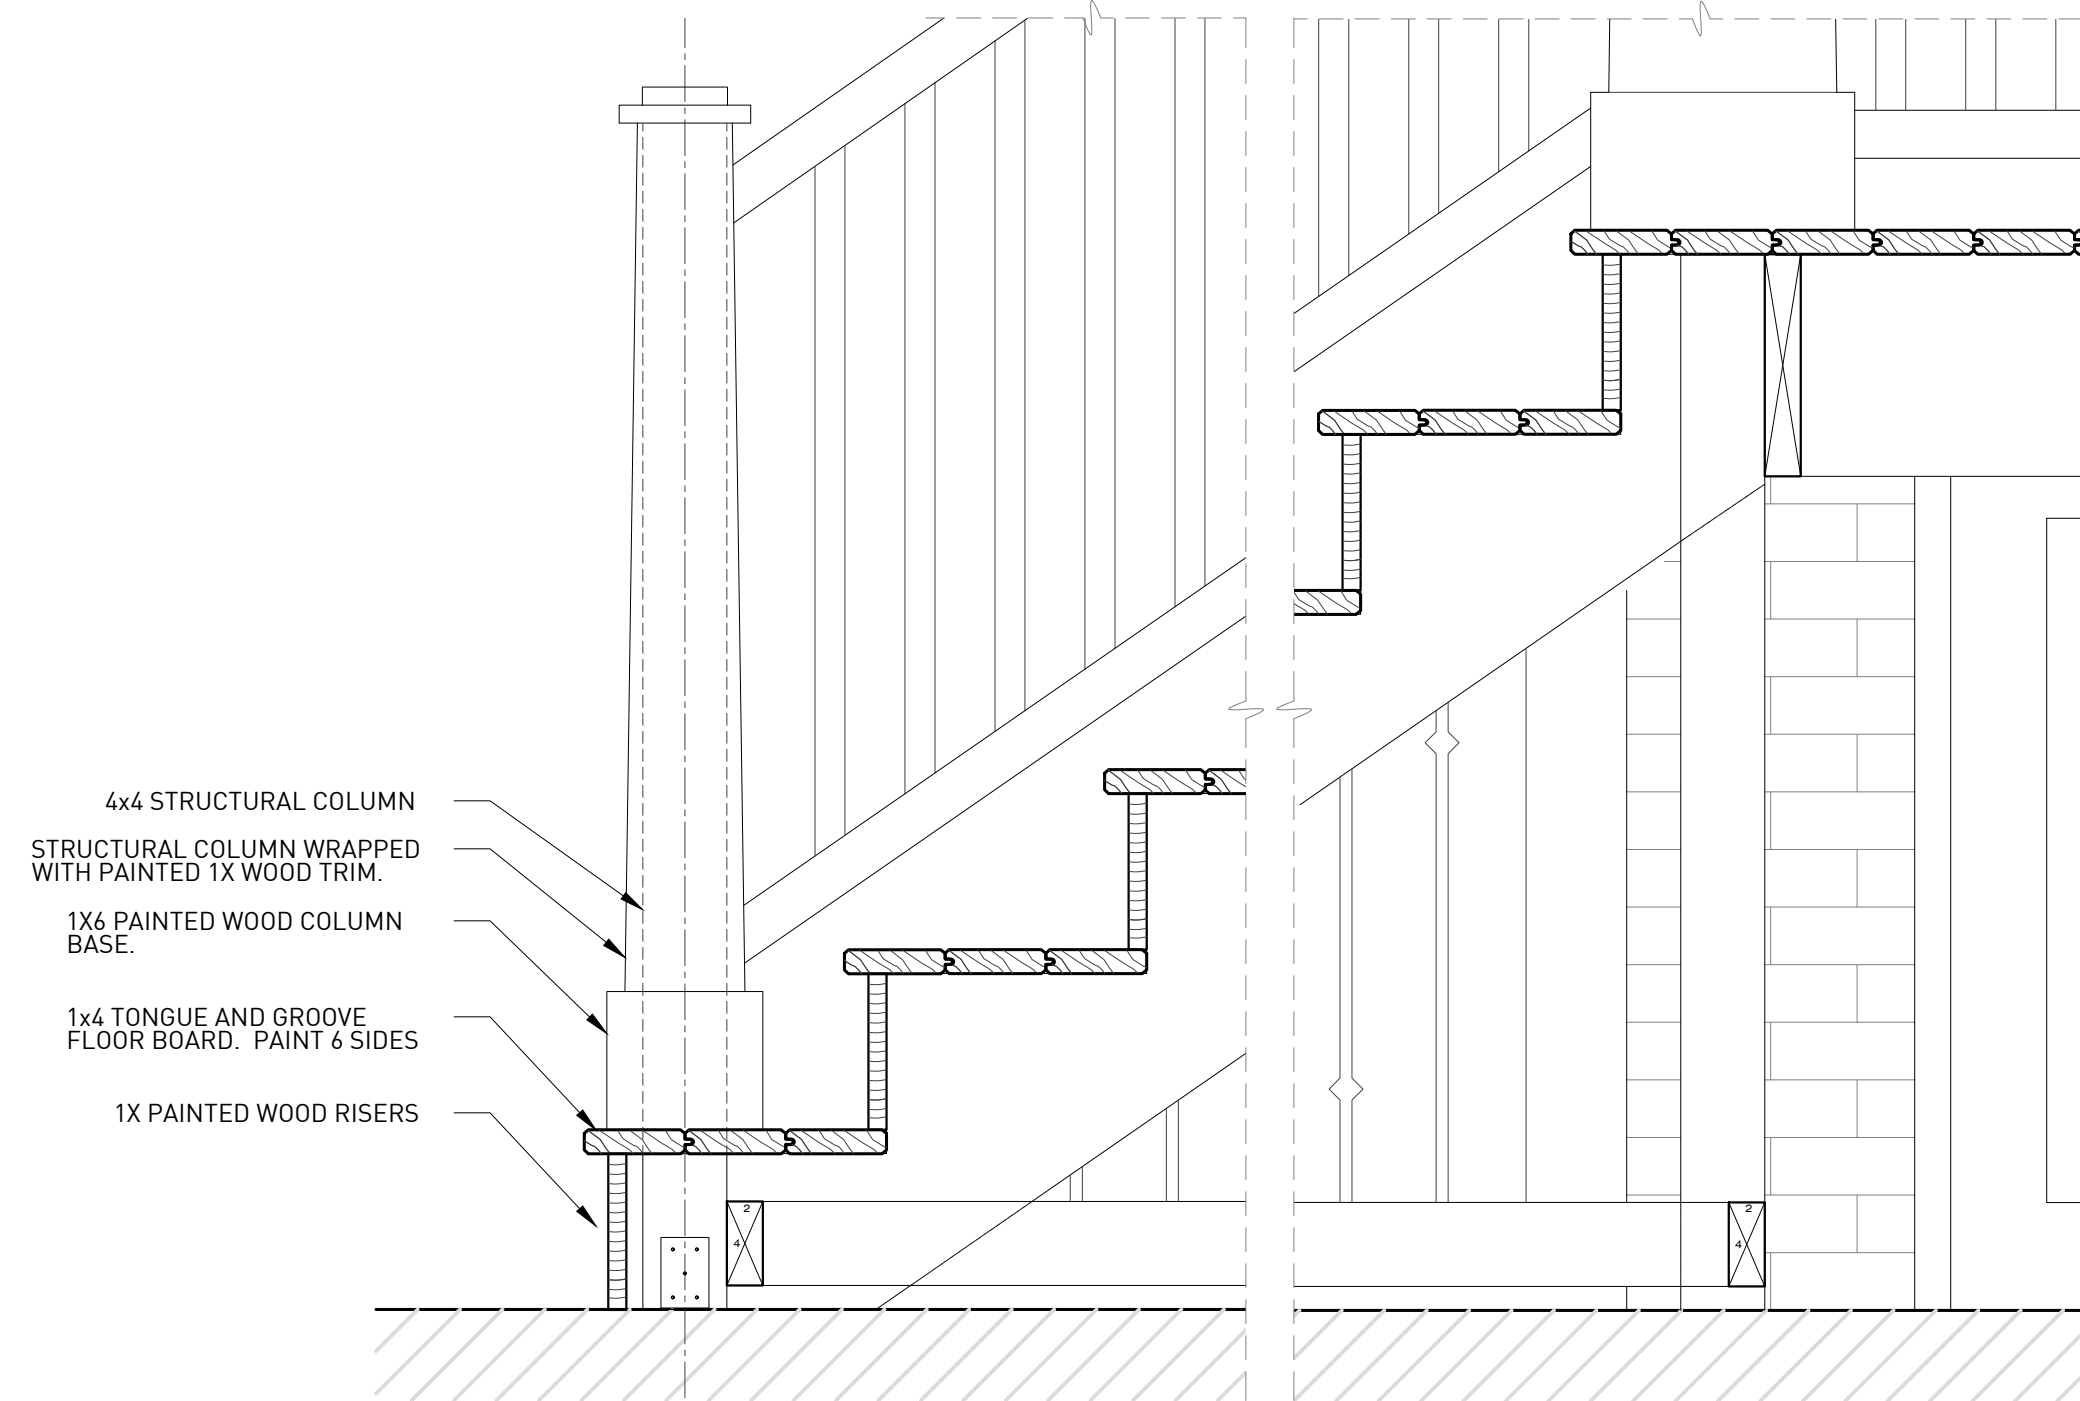


3 PORCH STAIR DETAIL
ORIGINAL IMAGE SCALE: 1 1/2" = 1'-0"

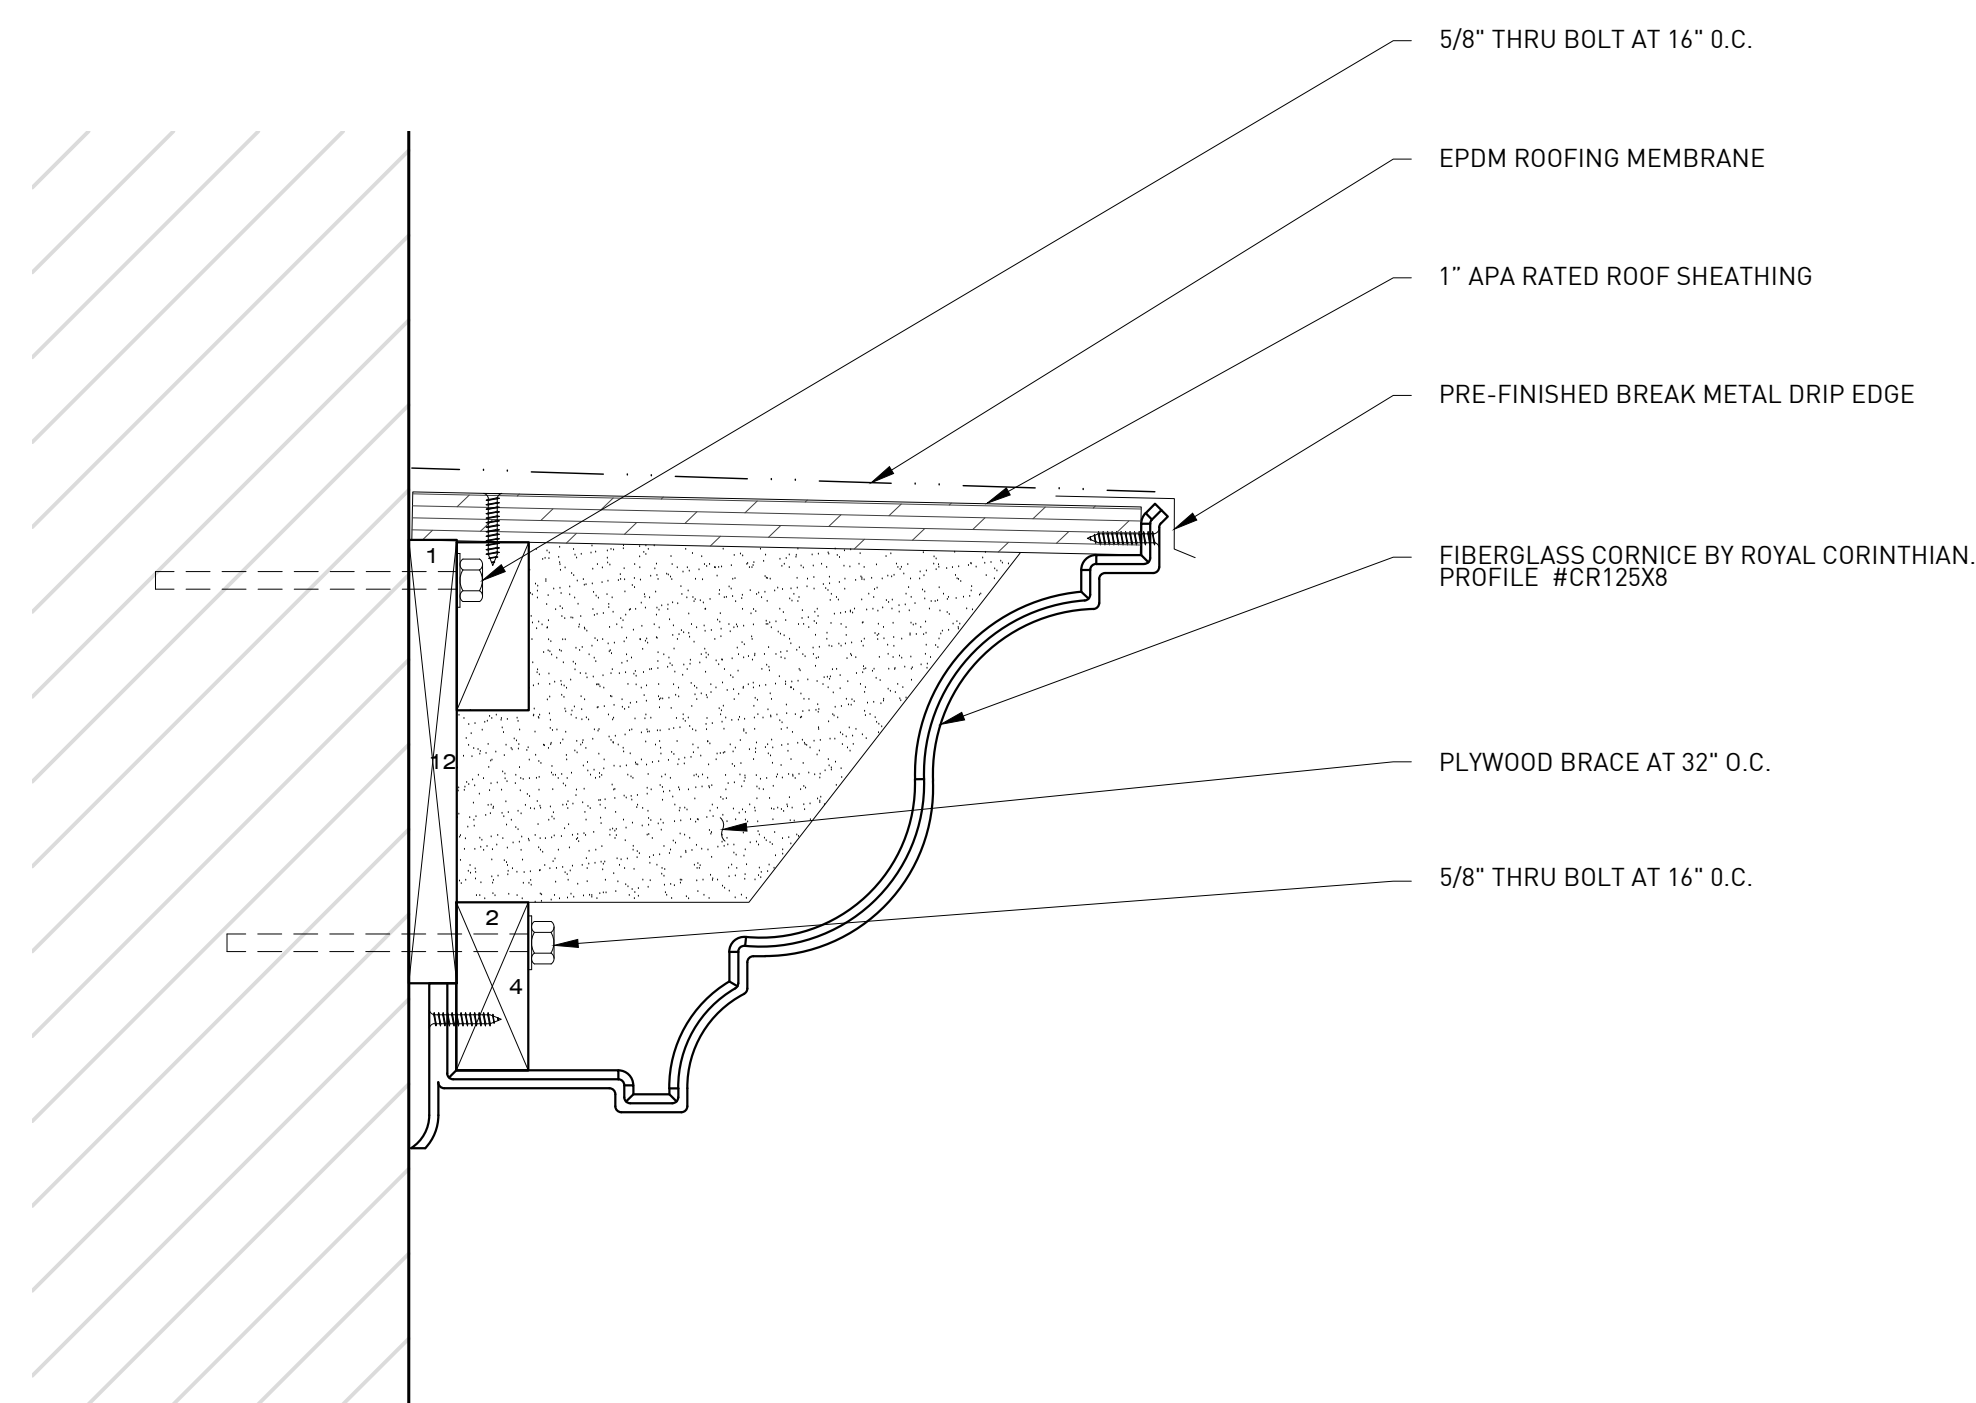

4 CORNICE DETAIL
ORIGINAL IMAGE SCALE: 1 1/2" = 1'-0"

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ALL CONTRACTORS (GENERAL CONTRACTOR, SUB-CONTRACTORS, MEMBERS OR AGENTS OF EITHER OR BOTH) ARE TO VERIFY AND COORDINATE ALL CONDITIONS, DIMENSIONS, QUANTITIES AND DETAILS, STATED OR NOT, WITHIN THESE DRAWINGS AND WITHIN THE SPECIFICATIONS BEFORE COMMENCING WITH THE WORK. IF A DIMENSIONAL ERROR OR CONFLICT OCCURS BETWEEN THESE DRAWINGS, THE SPECIFICATIONS OR THE EXISTING / PROPOSED CONDITIONS, IT SHALL BE BROUGHT TO THE IMMEDIATE ATTENTION OF THE ARCHITECT, BEFORE PROCEEDING WITH THE WORK. ANY PARTY (GENERAL CONTRACTOR, SUB-CONTRACTORS, MEMBERS OR AGENTS OF EITHER OR BOTH) WHO FAILS TO DO SO, TAKE FULL RESPONSIBILITY OF ANY ERRORS, CONFLICTS, SCHEDULE AND COST IMPLICATIONS.

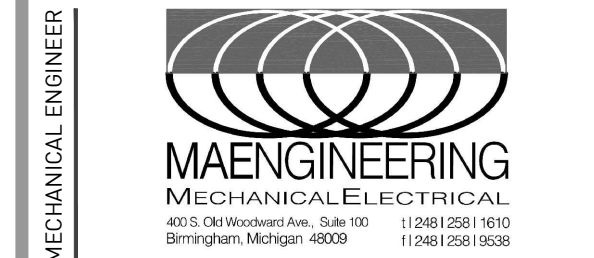

MECHANICAL ENGINEER
STRUCTURAL ENGINEER

1531 8TH STREET
DETROIT, MI 48216

PERMIT REVIEW

REVISIONS	DATE	DESCRIPTION
1.	20201118	PERMIT REVIEW



DETAILS

DRAWING NO. A5-00