STAFF REPORT: 3/10/2021 MEETING PREPARED BY: D. RIEDEN APPLICATION NUMBER: #21-7106

ADDRESS: 550 FISKE

HISTORIC DISTRICT: BERRY SUBDIVISION

APPLICANT: CHARLES WILLIAMS

PROPERTY OWNER: CHARLES WILLIAMS

DATE OF PROVISIONALLY COMPLETE APPLICATION: 01/28/2021

DATE OF STAFF SITE VISIT: 2/24/2021

SCOPE: ERECT NEW GARAGE/STORAGE STRUCTURE

EXISTING CONDITIONS

Built in 1960, this 2-story single-family house with attached garage stands midblock on two lots on Fiske Street, facing west. The low-pitched, hipped-roof is accompanied by a large chimney, composed of light-grey bricks that wrap around the first floor of the home. Black-shuttered windows punctuate the second story's white clapboard siding and front elevation. The entry overhang features delicate, modern black-metal balustrade and matching columns. The property includes a fenced side lot, and consists mostly of an open lawn with periodic shade trees and evergreens.







Site Photo 2 by Applicant: Garage site (North/East) side/rear.

The owner purchased the property in March 2019. As staff currently does not have access to some of the previous paper applications and approval letters, the Detroit Property Index is the only available information on the property. This property has no previous HDC approved work, nor any violations.

PROPOSAL

The current owner provided an application, narrative, site photos, construction documents and material details for the following proposed work: construct a new 20' x 25' garage, with a 4" concrete pad, set back 3 feet from the rear (east) and side (north) property line. See also attached documents provided by the applicant. No driveway or other site improvements are included because the proposed use for the garage is storage.



Sanborn Map, Vol.8, P109, 1915. 1



Aerial of Parcel 19006294 and 19006293. 1



Aerial, May 2020 1

STAFF OBSERVATIONS AND RESEARCH

- Upon receipt of the application, Staff requested the following details regarding the applicant's proposed scope of work.
 - o Show site plan details of any new additional pavement or gravel-way for the proposed garage.
 - Verify proposed siding material type, color and finish.
 - o The applicant sent verification that there is no proposed additional pavement or gravel-way to the entrance of the garage.
 - The applicant verified that the proposed siding is white, vinyl siding.
- The construction drawings show windows and exterior wall sconces at the doors, but the project narrative states that there will be no windows nor exterior lighting on the garage.
- Staff visited the site on February 24, 2021. Staff photographed the property from the public right-of-way and observed the front (west) and sides (north and south) of the house. (See staff photos enclosed)
- The proposed location of the new garage is behind the house and aligned with the applicant's neighbor's garage immediately to the east. Because of this location and the garage being less than the maximum height allowed (15 ft) at 11 ½ feet, it would not be hardly visible to the public.
- The proposed low pitch, hipped roof of the garage aligns in design, color and texture with the existing house's roof.
- The Timberline natural shadow charcoal Architectural shingles are appropriate material.
- The orientation of the garage on the site has the main garage door facing south with the side door facing west, towards the house. Thus, the roof's ridgeline would be perpendicular to the house's roof ridgeline.
- The light-grey color siding and white doors match the existing color scheme of the house.
- It is staff's opinion with Hardie cladding, the materials, size, colors are appropriate for the existing context of the Berry Subdivision Historic District.

ISSUES

Details on the construction drawing call out James Hardie siding with 8" reveal, which would be appropriate to the design of the house. However, attached construction detailing shows a vinyl siding material. Vinyl is not a historically appropriate material for the Berry Subdivision Historic District or this particular property.

RECOMMENDATION

HDC staff recommends the Commission issue an approval for the below work items because they meet the Secretary of the Interior's Standards for Rehabilitation and conform to the Elements of Design for the Berry Subdivision Historic District:

• Construct a new 20' x 25' garage, with a 4" concrete pad

However, staff recommends the Commission issue a COA with the following conditions:

• The applicant will provide manufacturer specifications with non-vinyl siding for HDC staff review and approval prior to an issued permit.











THIS IS A 3-PAGE FORM - ALL INFORMATION IS REQUIRED FOR PROJECT REVIEW

HISTORIC DISTRICT COMMISSION PROJECT REVIEW REQUEST

City of Detroit - Planning & Development Department 2 Woodward Avenue, Suite 808 Detroit, Michigan 48226 Detroit, Michigan 48226
PROPERTY INFORMATION
ADDRESS: 550 7/ske Dr AKA:
HISTORIC DISTRICT: SCOPE OF WORK: Windows/ Roof/Gutters/ Porch/ Landscape/Fence/ Rehab
New Construction Demolition Addition Other: Garage
APPLICANT IDENTIFICATION
Property Owner/ Contractor Tenant or Business Occupant Consultant NAME: Charles Williams COMPANY NAME: NAME
NAME: Charles Williams COMPANY NAME: 1/1/
ADDRESS: 550 Fiske Orcity: Detroit STATE: MI ZIP: 48214
PHONE: 734-652-6382 MOBILE:EMAIL:
PROJECT REVIEW REQUEST CHECKLIST
Please attach the following documentation to your request: *PLEASE KEEP FILE SIZE OF ENTIRE SUBMISSION UNDER 30MB* INOTE:
Completed Building Permit Application (highlighted portions only) Based on the scope of work,
ePLANS Permit Number (only applicable if you've already applied for permits through ePLANS) See www.detroitmi.gov/hdc for i
Photographs of ALL sides of existing building or site
Detailed photographs of location of proposed work (photographs to show existing condition(s), design, color, & material)
Description of existing conditions (including materials and design)
Description of project (if replacing any existing material(s), include an explanation as to why replacement—rather than repair—of existing and/or construction of new is required)
Detailed scope of work (formatted as bulleted list)
and/or product(s), as applicable
the state of the s
Upon receipt of this documentation, staff will review and inform you of the flox of this documentation, staff will review and inform you of the flox of the work. Buildings, Safety Engineering and Environmental Department (BSEED) to perform the work. SUBMIT COMPLETED REQUESTS TO HDC@DETROITMI.GOV
SUBMIT COMPLETED REQUESTS TO I I D

P2 - BUILDING PERMIT APPLICATION

		Date: L_G_Z1
PROPERTY INFORMATIC	IN,	
Address: 550 7-/	ske Or Floor	Suite#:Stories:
AKA:	Lot(s):	Subdivision:
Parcel ID#(s):	Total Acres:Lot	Width: Lot Depth:
	Residence Proposi	
Are there any existing building	s or structures on this parcel?	DYes DNo
PROJECT INFORMATION		
	Alteration Addition []	
	ange of Use Temporary Use	
Revision to Original Permit		ginal permit has been issued and is active)
Description of Work (Describ	e in detail proposed work and use of prope	erty, attach work list) Lation pour ex
und Garag	TOTAL STATE OF THE	
	☐ MBC use	change No MBC use change
ncluded Improvements (C)	neck all applicable; these trade areas requir	re separate permit applications)
] HVAC/Mechanical	Electrical Plumbing Fire	re Sprinkler System 🔲 Fire Alarm
tructure Type		
New Building Existi	ing Structure Tenant Space	Garage/Accessory Building
	ize of Structure to be Demolished (I	
Construction involves change		
e.g. interior demolition or construc		
Ise Group:	Type of Construction (per current MI E	Bldg Code Table 601)
stimated Cost of Construc	tion \$	\$
tructure Use	By Contractor	By Department
Residential-Number of Units: _	Office-Gross Floor Area	Industrial-Gross Floor Area
Commercial-Gross Floor Area:		Other-Gross Floor Area
	List materials to be stored in the b	uilding:
	- Landahallaha	ow all easements and measurements
nust be correct and in detail)	. SHOW ALL streets abutting lot, in	dicate front of lot, show all buildings, lication Continues on Next Page)
xisting and proposed distance	es to lot lines. (Dunding	
	For Building Department Use	0 01101 111
itake By:	Date:	Fees Due: DugBla! LIN
Permit Description:		
emin Description.		
111111	Prop	osed Use:
urrent Legal Land Use:	Date Permit Issued:	Permit Cost: \$
ermit#:	Date Permit Issued. Zoning G	
oning District:		
	Yes No (attach zoning c	
evised Cost (revised permit a	applications only) Old \$	New \$
	Date:	Notes:
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tructural:	Date.	Notes:
tructural:oning:	Date:	Notes:

DETROIT

DENTIFICATION (All Fields Requ	uired Veroperty Owner/Homeowner is Permit Applicant Property Owner/Homeowner is Permit Applicant 1/8214
Property Owner/Homeowner	Property Owner/Homes NATH 1/8214
Name: Charles William	Or City: Det State: MLZip: 48214 Or City: Det State: MIZip: 48214
Address: 550 Fiske	Or City: Det State: LE Mobile: Mobile: Revwilliams 72@gmail. Co. Email: Revwilliams 72@gmail.
Phone: 734 652 6382	Mobile:
	Email: Revari
Driver's License #:Contractor is Per	rmit Applicant
	Company Name Zip:
Representative Name:	City: State:
Address: Mobile:	Email:
Phone:	
City of Detroit License #:	
CONTECT OCCII	IDANT Tenant is Permit Applicant
TENANT OR BUSINESS OCCU	
Name:Phon	e: Permit Applicant
	SINTANT Architect/Engineer/Consultant is Permit Applicant
ARCHITECT/ENGINEER/CON	E-miration Date.
Name:	State Registration#: Zip: Zip:
Address:	City: Email:
Phone: Mobil	P.
	Only required for residential permits obtained by homeowner.) where and occupant of the subject property and the work described ompleted by me. I am familiar with the applicable codes and other for all code compliance, fees and
Print Name: Charles Williame (Homeowner) Subscribed and sworn to before me th	//work herein described. I shall neither hire nor sub-contraction of the work covered by this building permit. // Date:
	My Commission Expires:
Signature: (Notary	
P	ERMIT APPLICANT SIGNATURE
restrictions that may apply to an acceptify that the proposed work is at to make this application as the proposed all applicable laws and ordinances	1 11 4 A D SIGNOW
	Expiration:
Driver's License #:	this day of A.D County, Michigan
Subscribed and swom to before me!	My Commission Expires:
Signature:	
	4072DA220 BACI 175 1571A
	te construction code act of 1972, 1972PA230, MCL 125.1523A, te construction code act of 1972, 1972PA230, MCL 125.1523A, om conspiring to circumvent the licensing requirements of this are sons who are to perform work on a residential building or a residential building or a recture. Visitors of Section 23a are subject to civil fines.

This application can also be completed online. Visit detroitmi.gov/bseed/elaps for more information.













HBC

I am submitting application for new garage construction, there is no garage in this space at the present time. I have already sent photos where the garage will be built. The reason I am building the garage is because I don't have space for my lawn mower equipment, as well as lawn furniture and snow removal equipment. So basically the garage will be used specifically for storage. The existing space where the garage will be built is a level surface with nothing but grass. There will be no windows in the garage there will be no external lighting on the structure there will be lighting on the interior of the garage

WILLIAMS RESIDENCE ACCESSORY STRUCTURE

550 FISKE DR. DETROIT, MI 48214

ARCHITECT

STUDIO DETROIT 2111 WOODWARD AVE. STE 1001 DETROIT, MI 48201 CONTACT: KEVIN J CROSBY, AIA, NCARB 313.909.3607

GENERAL SCOPE OF WORK

THE ADDITION OF A NEW SINGLE STORY ACCESSORY STORAGE STRUCTURE IN THE REAR YARD.


BUILDING CODE INFORMATION

APPLICABLE CODES:


1. MICHIGAN RESIDENTIAL CODE 2015 2. MICHIGAN UNIFORM ENERGY CODE 2015

ZONING INFORMATION

SEE SITE PLAN SP1.1

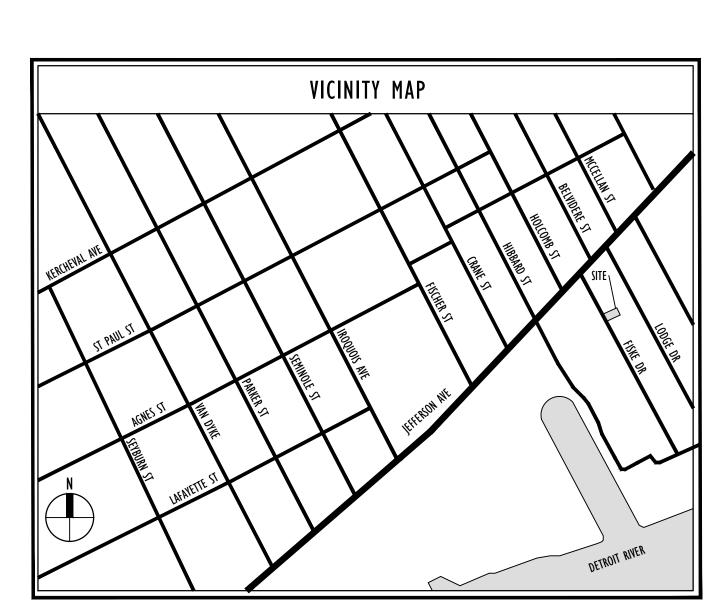

	ISSU	ED FO	R	
SHEET INDEX				
DRAWING INDEX KEY:				
NOT ISSUED		#1		
PREVIOUSLY ISSUED	/ PERMITS	ADDENDUM #1		
■ ISSUED	BIDS	ADDE		
REFERENCE	12.02.20	12.18.20		
GENERAL				
TS1.1 TITLE SHEET,SHEET INDEX, AND VICINITY MAP				T
SP1.1 ARCHITECTURAL SITE PLAN	С			
ARCHITECTURAL				
A1.3 GARAGE FLOOR PLAN - NEW WORK				
A2.2 GARAGE EXTERIOR ELEVATIONS	C			
A3.2 GARAGE BUILDING/ WALL SECTIONS				

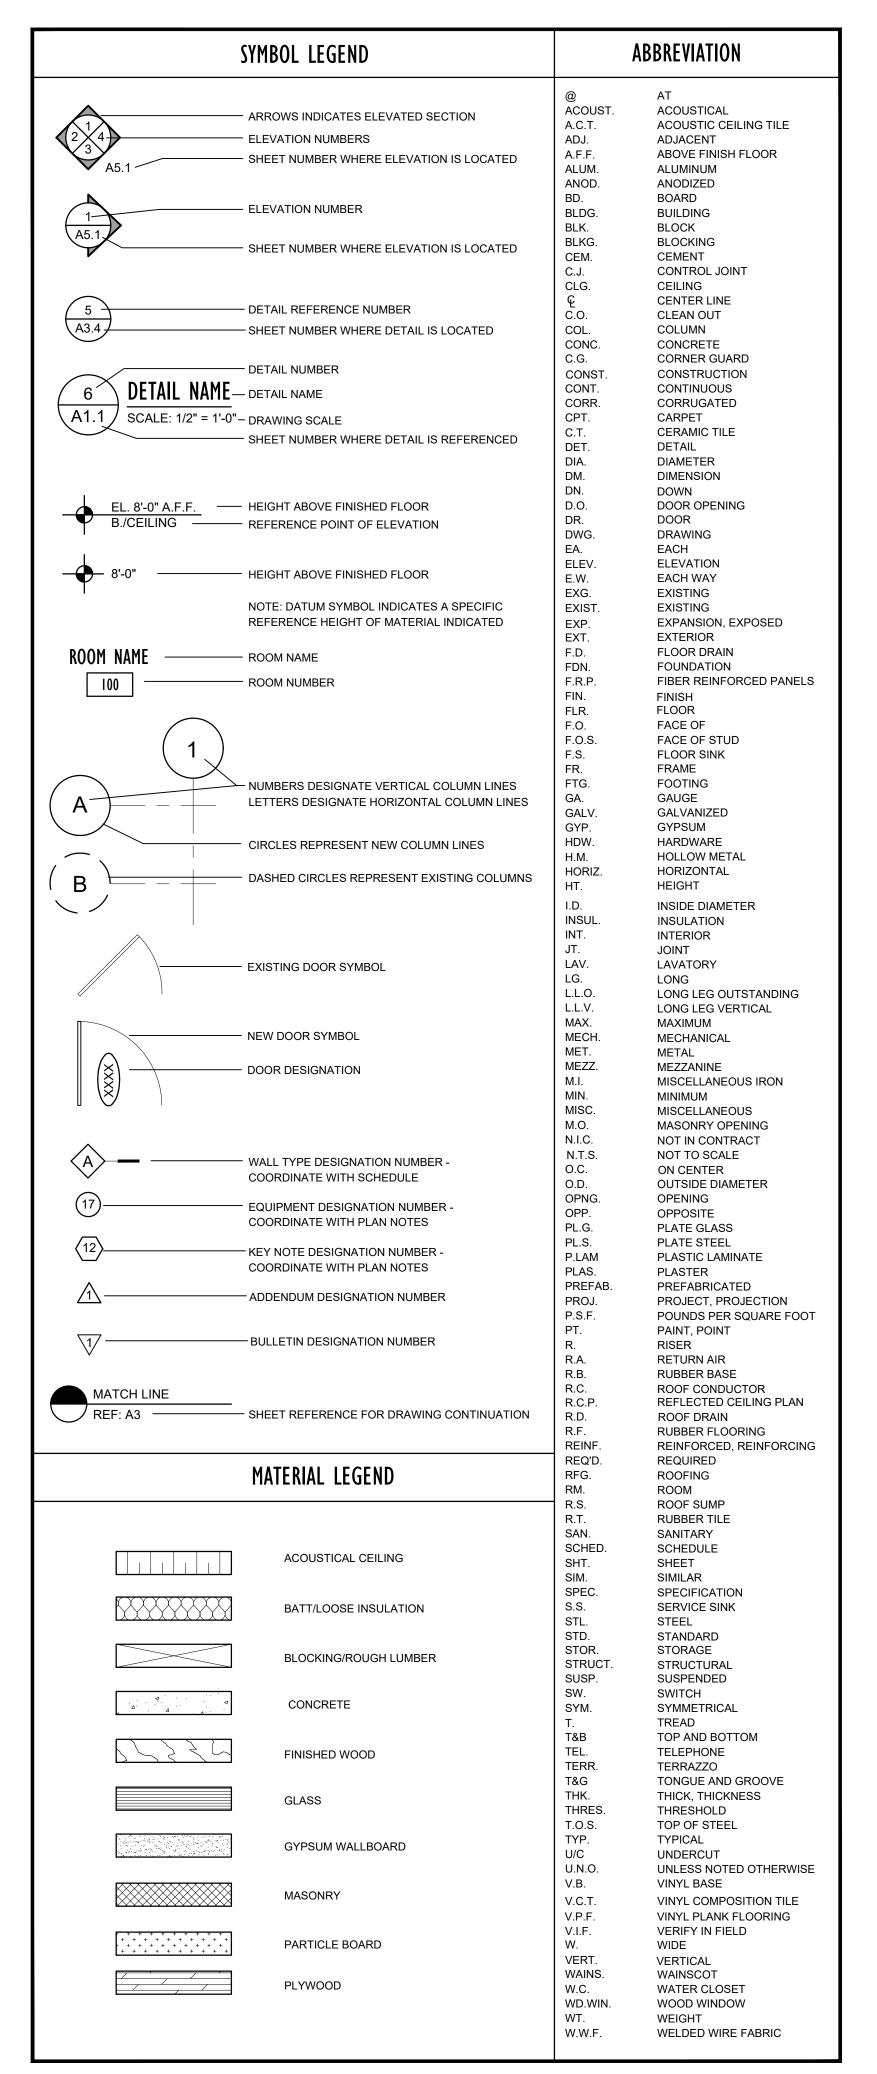



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12.02.20 BIDS/ PERMITS 12.18.20 ADDENDUM #1

FILE 1939_TSI-I_Coversheet.dwg DRAWN RILEY L. RINNAN CHECKED KEVIN J. CROSBY

CLIENT CHARLES WILLIAMS

PROJECT WILLIAMS RESIDENCE ADDITION 550 FISKE FISKE DR


JOB NO.

DETROIT, MI 48214

SHEET TITLE SHEET

SHEET NO.

SITE DATA SUMMARY TABLE CURRENT ZONING SITE AREA R1 - SINGLE FAMILY RESIDENTIAL 9,000 S.F. ±.2 ACRES MAX. LOT COVERAGE 35% BUILDING LOT COVERAGE 1,240 S.F. EXISTING RESIDENCE PROPOSED ACCESSORY STRUCTURE 500 S.F PROPOSED TOTAL BUILDING LOT COVERAGE 1,740 S.F. PROPOSED TOTAL LOT COVERAGE 19% **BUILDING SETBACKS (RESIDENCE)** FRONT REQUIRED: 20 FEET EXISTING: ±31.7 FEET SIDE REQUIRED: 4 FEET EXISTING: ±8.6 FEET CUMULATIVE SIDE REQUIRED: 14 FEET EXISTING: ±11.6 FEET REQUIRED: 30 FEET REAR EXISTING: ±63.7 FEET BUILDING SETBACKS (ACCESSORY STRUCTURE) REAR REQUIRED: 3 FEET PROPOSED: 3 FEET SIDE: REQUIRED: 3 FEET PROPOSED: 3 FEET ACCESSORY STRUCTURE MUST BE LOCATED IN REAR YARD < 50% OF REQUIRED REAR SETBACK AREA > 10 FEET FROM ANY SINGLE OR TWO FAMILY DWELLING MAX. HEIGHT: 15 FEET PROPOSED HEIGHT: ±11.6 FEET (TOP OF ROOF STRUCTURE)

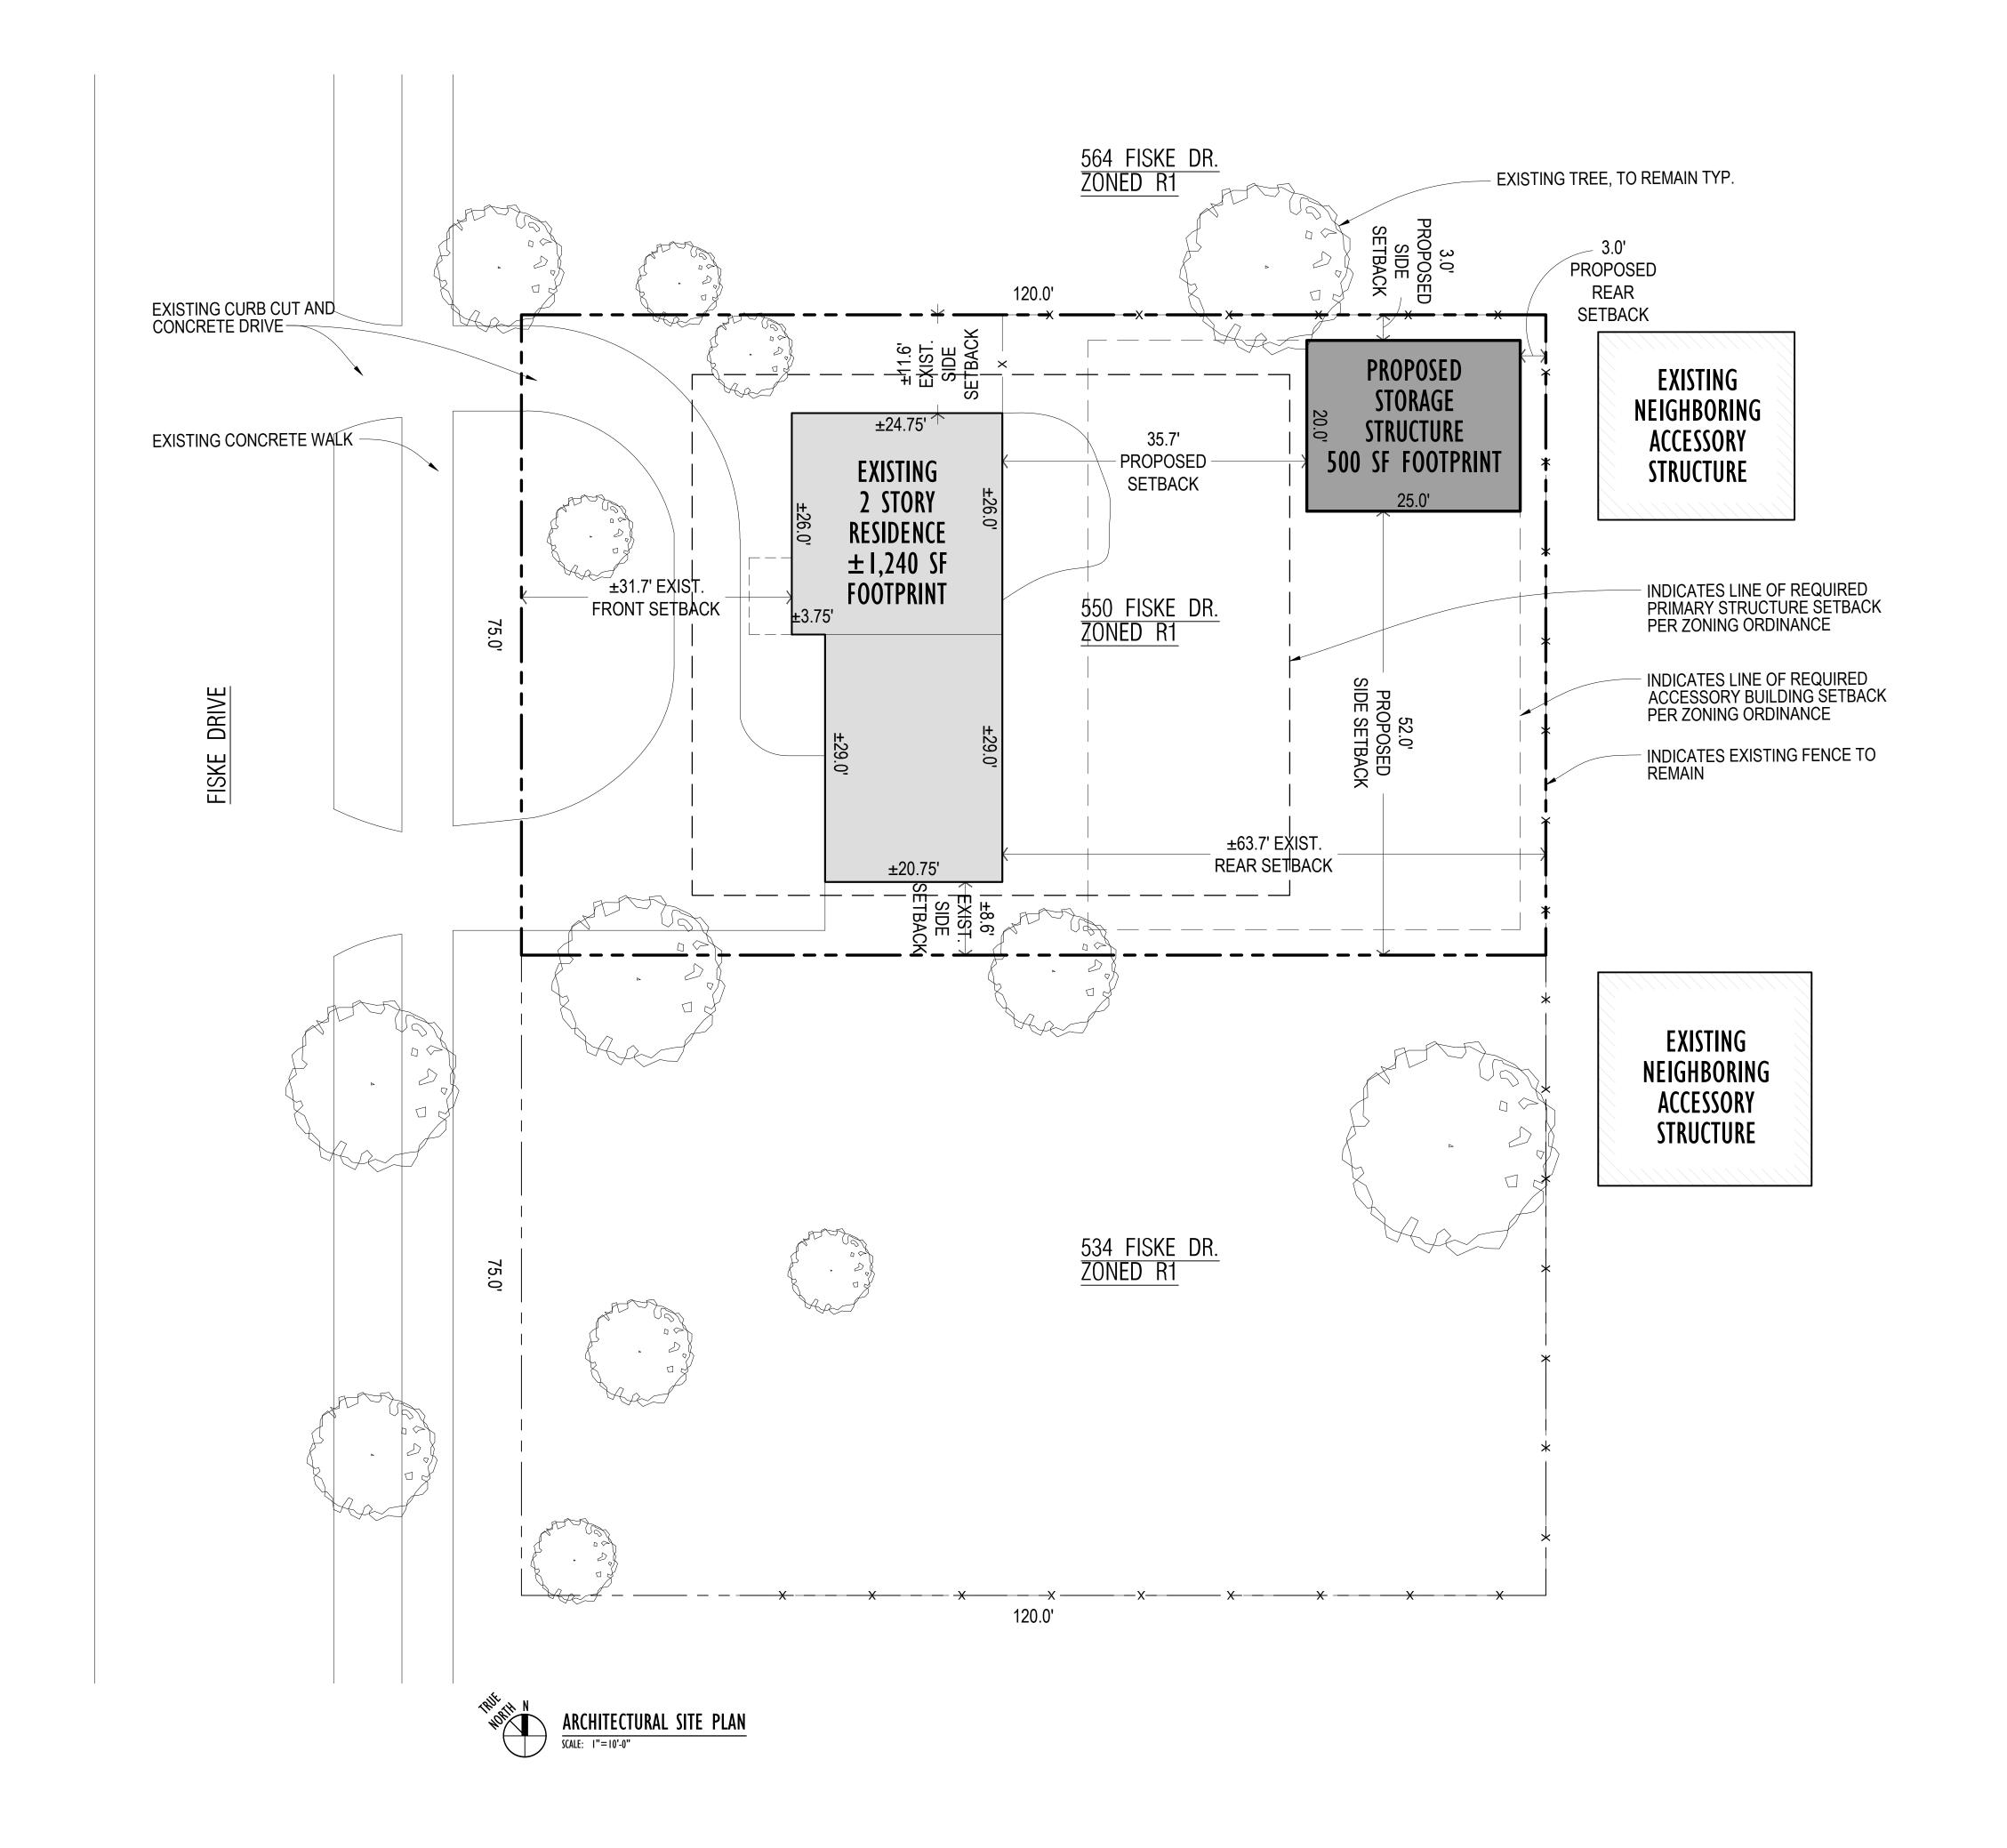

VISIONARIES INNOVATORS ARCHITECTS

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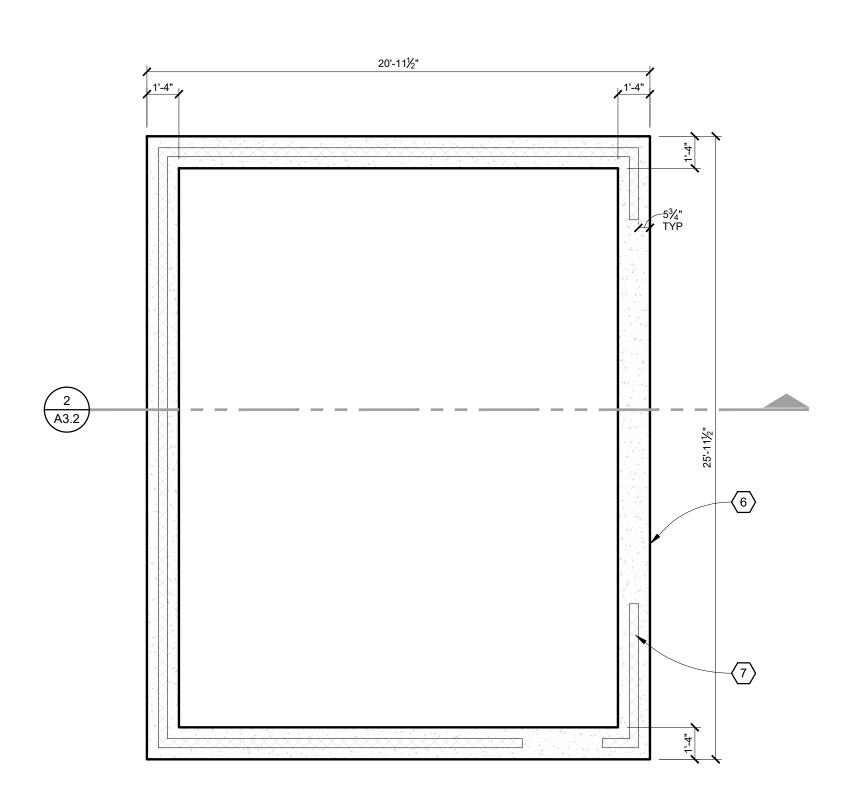
CLIENT CHARLES WILLIAMS

PROJECT WILLIAMS RESIDENCE ADDITION 550 FISKE FISKE DR DETROIT, MI 48214


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ARCHITECTURAL SITE PLAN


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FLOOR PLAN GENERAL NOTES:

- 1. ASSUMED SOIL CAPACITY IS 3,000#/SQ. FT. THE CONTRACTOR SHALL DETERMINE THE BEARING CAPACITY THROUGH FIELD-TESTING.
- 2. EXTERIOR MASONRY WALLS DIMENSIONED TO FACE OF MASONRY. EXTERIOR SIDED WALLS DIMENSIONED TO FACE OF SHEATHING
- 3. COORDINATE BUILT-IN FURNITURE, FINISHES, FIXTURES, TRIM, &
- OTHER SIMILAR DETAILS w/ OWNER 4. ALL DOOR SIZES ARE LABEL IN FEET AND INCHES: 3080 = 3'-0" WIDE x 8'-0" HIGH
- 5. UNLESS NOTED OTHERWISE ON THE CONSTRUCTION DOCUMENTS, LOCATE ALL DOORS MINIMUM 4" FROM ADJACENT WALL ON HINGE SIDE. IF CASING LARGER THEN 2 1/4" IS SELECTED, ADJUST AS NECESSARY. IF DOORS ARE NOT LOCATED NEXT TO ADJACENT

FRAMING GENERAL NOTES:

1. HEADERS FOR OPENINGS UP TO 6'-0" LONG SHALL BE MIN. (2) 2x8 AND BEAR ON (2) 2x4 BUILT-UP COLUMN AT EACH END U.O.N.

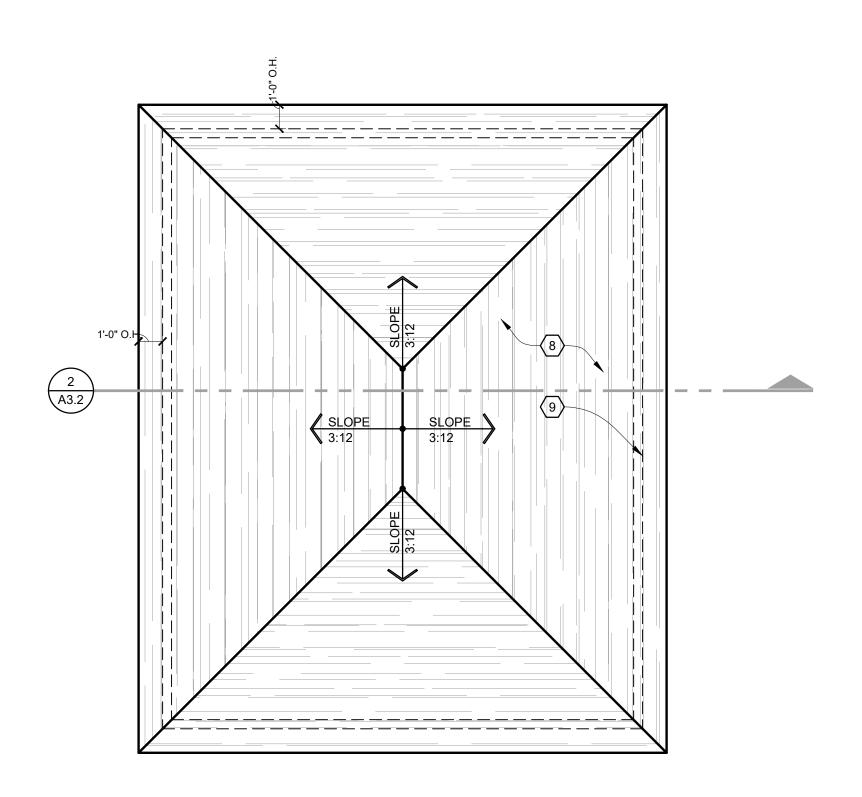WALL, CENTER ON SPACE THEY ENTER INTO

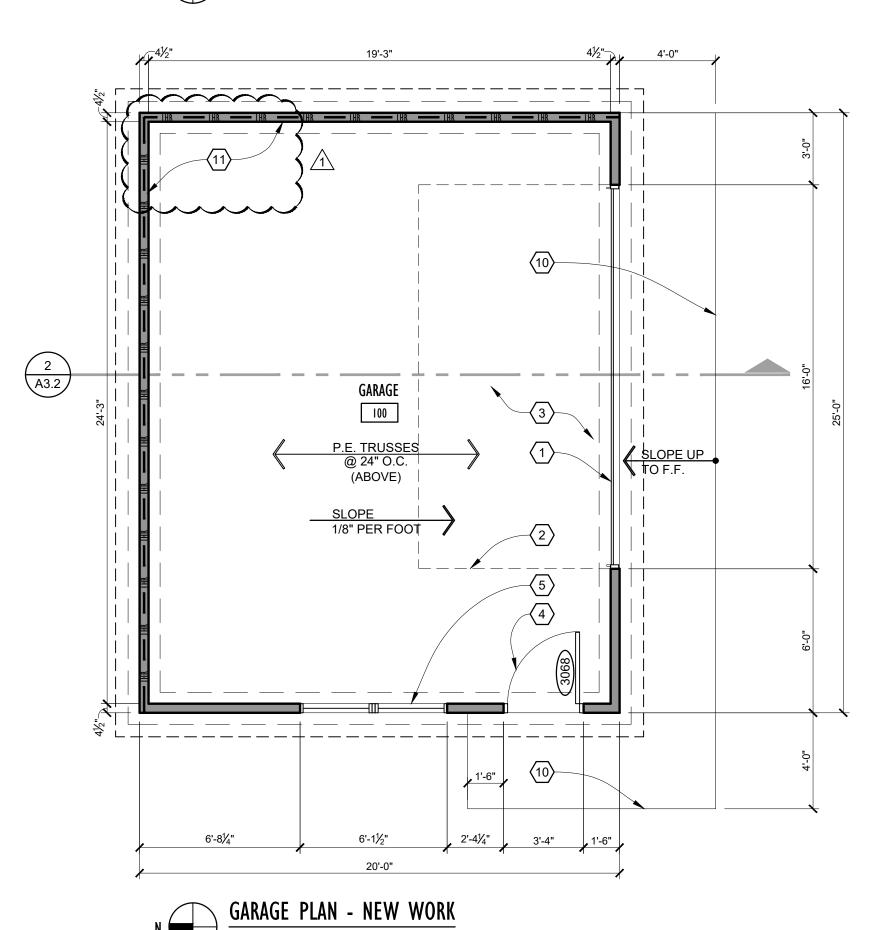- 2. HEADERS FOR OPENINGS FROM 6'-0" TO 10'-0" SHALL BE MIN (2) 2x12 AND SHALL BEAR ON (3) 2x4 BUILT-UP COLUMNS AT EACH END
- 3. SEALED DRAWINGS FOR PRE-ENGINEERED ROOF TRUSSES SHALL BE AVAILABLE ONSITE AT THE TIME OF ROUGH-FRAMING
- 4. ALL FRAMING IN CONTACT WITH MASONRY SHALL BE M.R.T.
- 5. LVL PROPERTIES: E= 1,800,000 PSI, Fb= 2,400 PSI
- 6. MULTIPLE STUDS SHALL BE REQUIRED UNDER TRUSS GIRDER BEARING POINTS - COORDINATE WITH TRUSS MANUFACTURER. VERIFY ADDITIONAL HEADER SUPPORT WITH STRUCTURAL ENGINEER IF REQUIRED.

ROOF PLAN GENERAL NOTES:

- 1. PROVIDE CONTINUOUS RIDGE VENT AND/OR ROOF VENTS PER MRC 2015; VENTS TO BE HIDDEN FROM STREET VIEW
- 2. ROOF CONTRACTOR SHALL INSPECT EXISTING ROOF STRUCTURE AND FLASHING CONDITIONS FOR DEFICIENCIES AND REPAIR AND REPLACE AS REQ. PER OWNER'S DIRECTION.

FLOOR PLAN KEY NOTES:

- 1 7'h O.H. DOOR w/ OPENER
- 2 INDICATES LINE OF O.H. DOOR ABOVE
- 3 POURED CONCRETE SLAB
- 4 DOOR AND FRAME AS SCHEDULED
- 5 WINDOW AND FRAME AS SCHEDULED
- 6 16" WIDE REINF. CONC. TRENCH FOOTING FROM 4" BELOW FINISH FLOOR TO 42" MIN BELOW GRADE, SEE GENERAL NOTES THIS SHEET & SECTION. FINAL DESIGN BY PROFESSIONAL ENGINEER.

11) 1-HR FIRE RESISTANCE RATED WALL PER AMERICAN WOOD

COUNCIL ASSEMBLY WS4-1.3 AS NOTED; SEE SECTION AND DETAIL

- 7 4" CMU STARTER COURSE
- 8 25 YR ARCHITECTURAL SHINGLES
- 9 LINE OF NEW EXTERIOR WALL SHEATHING FACE BELOW (10) CONCRETE APRON; SLOPE TO GRADE

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12.02.20	BIDS/ PERMITS
1 12.18.20	ADDENDUM #1

FILE 1939_A1.3_Garage_FirstFloorPlan DRAWN RILEY L. RINNAN

CHECKED KEVIN J. CROSBY

CLIENT CHARLES WILLIAMS

PROJECT WILLIAMS RESIDENCE ADDITION


550 FISKE FISKE DR DETROIT, MI 48214


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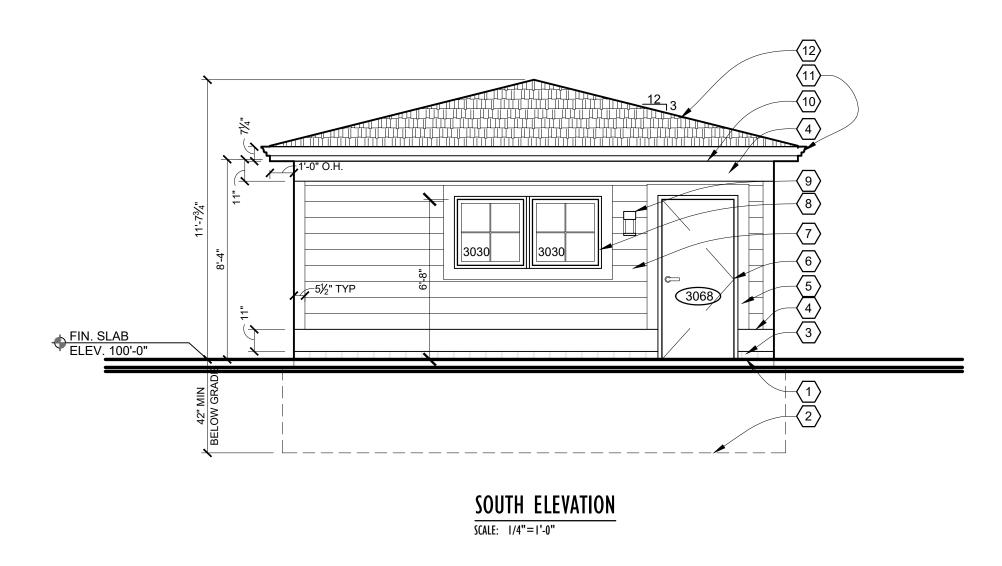
GARAGE PLAN


SHEET NO.

- NEW WORK



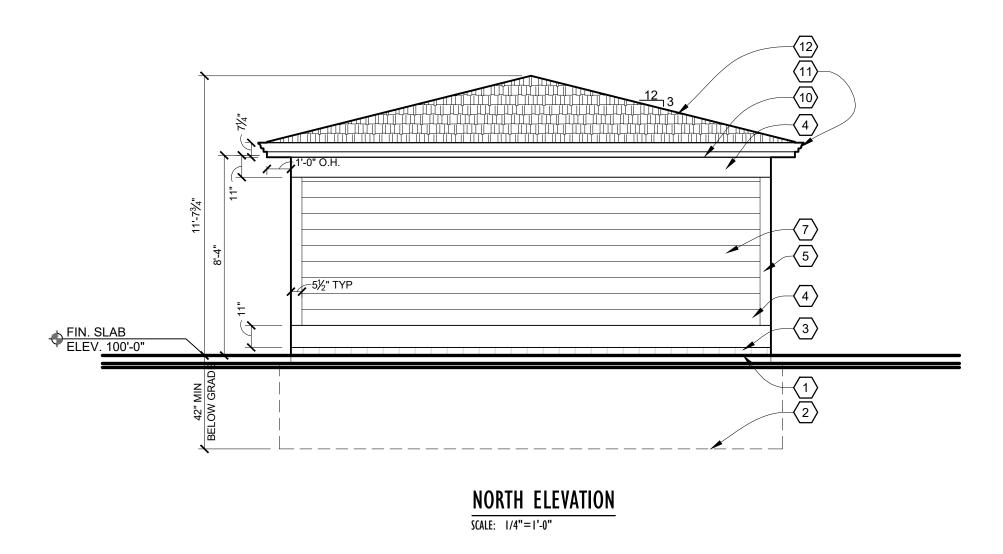

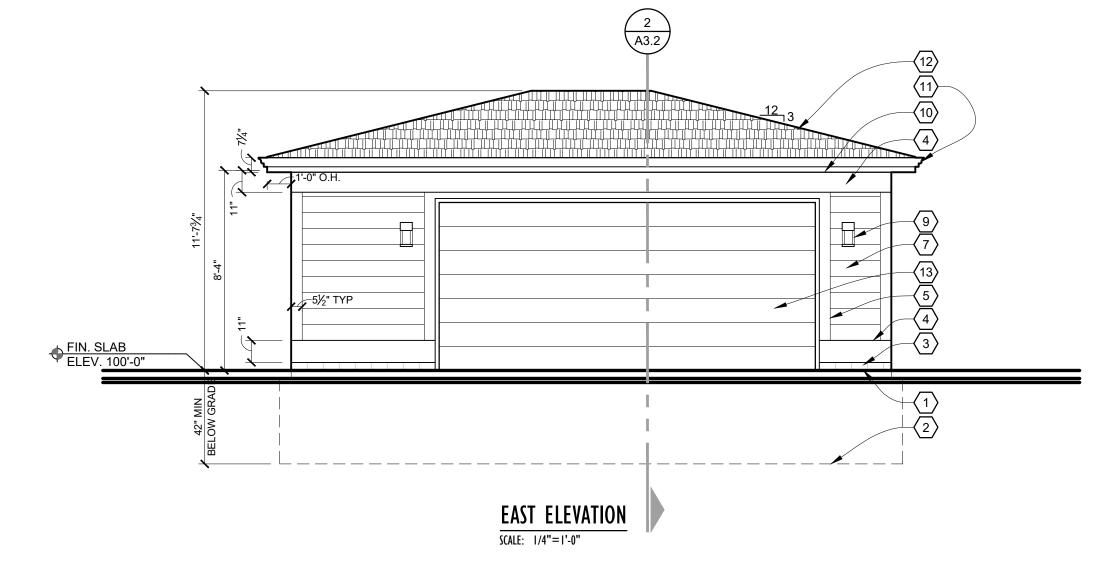

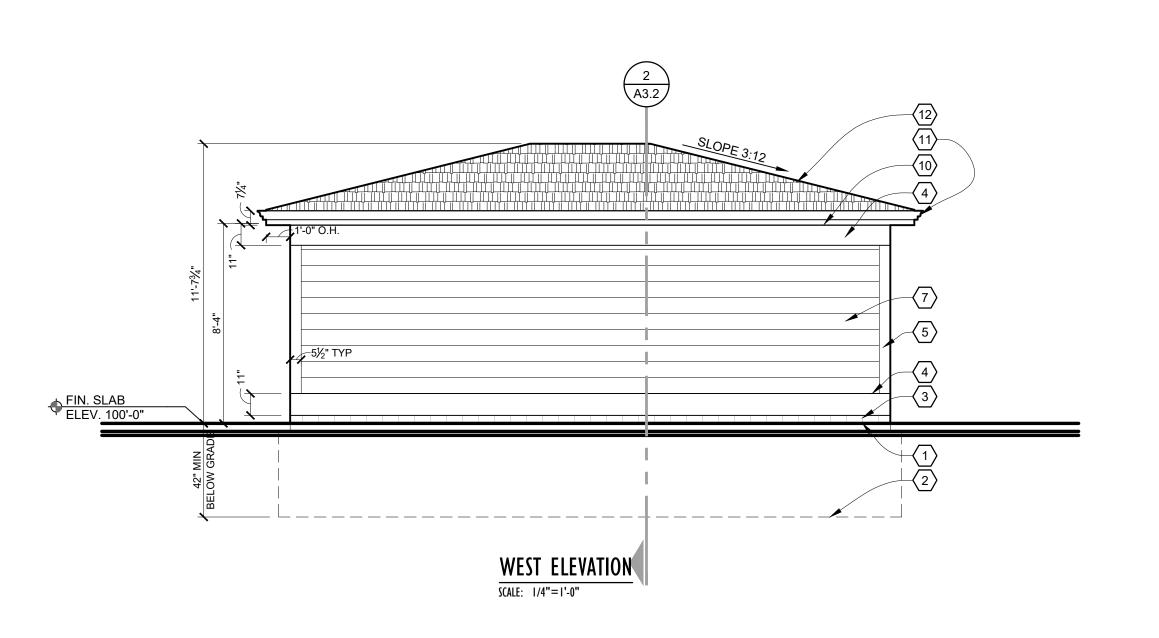

GENERAL ELEVATION NOTES:

- ALL FINISH/ TRIM SUPPLIERS SHALL SUBMIT SHOP DRAWINGS OR SAMPLES OF ALL FINISH MATERIALS FOR APPROVAL BY OWNER/ ARCHITECT PRIOR TO ORDERING.
- ALL CUT ENDS OR DRILLED LUMBER SHALL BE REPAIRED WITH SEALER.
- PROVIDE 1x_BLOCKING BEHIND ALL WALL MOUNTED ITEMS; VERIFY SIZES.

EXTERIOR ELEVATION KEY NOTES:

- 1 INDICATES LINE OF GRADE
- 2 INDICATES LINE OF NEW TRENCH FOOTING TO MIN 3'-6" BELOW FINISHED GRADE
- (3) 4" CMU STARTER COURSE
- 1x_TRIM BOARD; MRT, PAINT.
- 5 1x_TRIM; TYP. PAINT.
- 6 DOOR & FRAME; PAINT.
- JAMES HARDIE SIDING w/ 8" REVEAL; COLOR TBD BY OWNER
- 8 WINDOW AND FRAME
- 9 EXTERIOR WALL SCONCE AS SELECTED BY OWNER
- 10 1x8 MRT WD. FASCIA BD; PRIME & PAINT
- CONTINUOUS PRE-FINISHED SEAMLESS ALUM. GUTTER SYSTEM W/ DOWN SPOUTS
- ARCHITECTURAL SHINGLES ON NEW CONSTRUCTION; SEE ROOF PLAN
- 7'h O.H. DOOR w/ OPENER

l NC

CONTRACTOR TO PROVIDE AND INSTALL
CONTINUOUS ALUM. GUTTERS, DOWNSPOUTS AND
SPLASH BLOCKS IN APPROPRIATE LOCATIONS;
COORDINATE COLOR AND PROFILE SELECTION w/
OWNER



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FILE 1939_A2-3_GarageExtElevations.dwg

DRAWN RILEY L. RINNAN

CHECKED KEVIN J. CROSBY

CLIENT CHARLES WILLIAMS

PROJECT WILLIAMS RESIDENCE ADDITION 550 FISKE FISKE DR DETROIT, MI 48214


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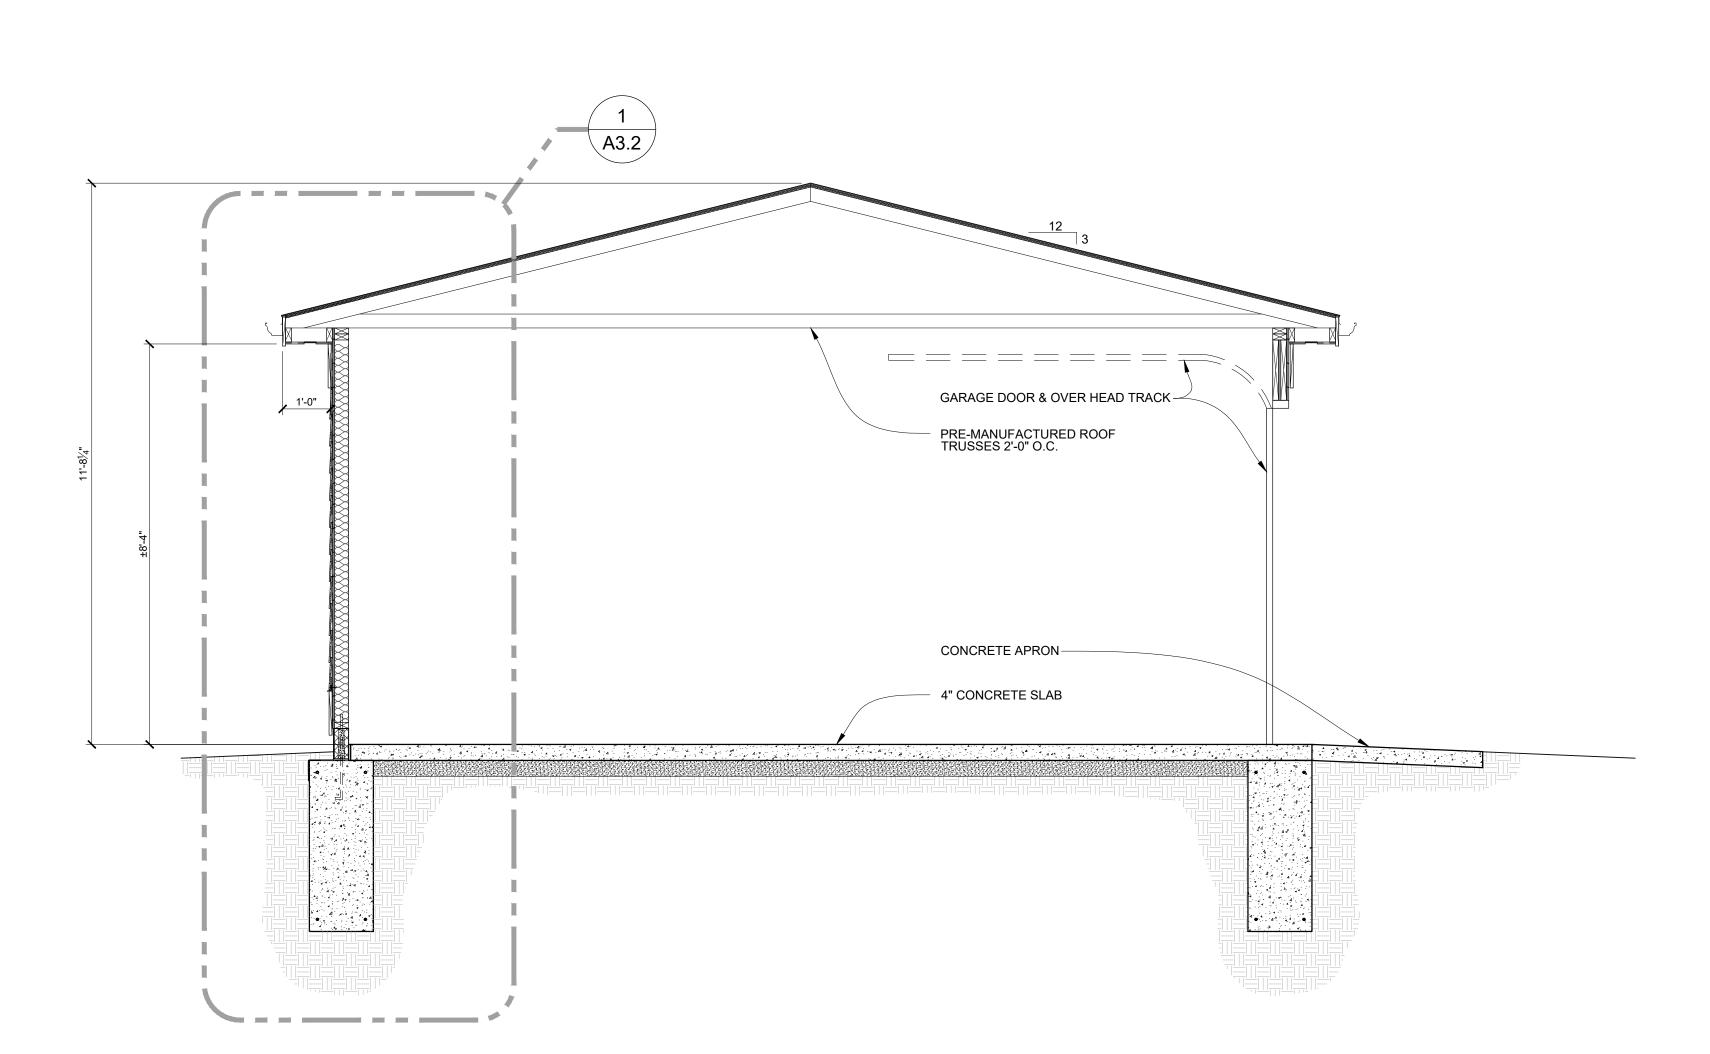
SHEET

GARAGE
EXTERIOR ELEVATIONS


SHEET NO.

12.2



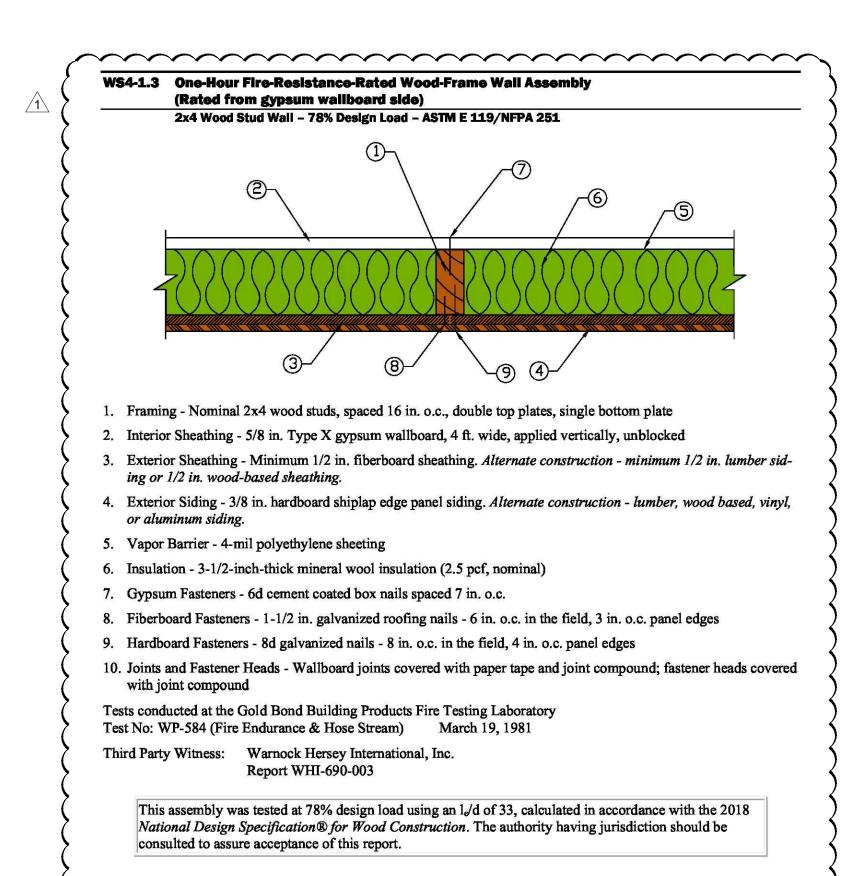



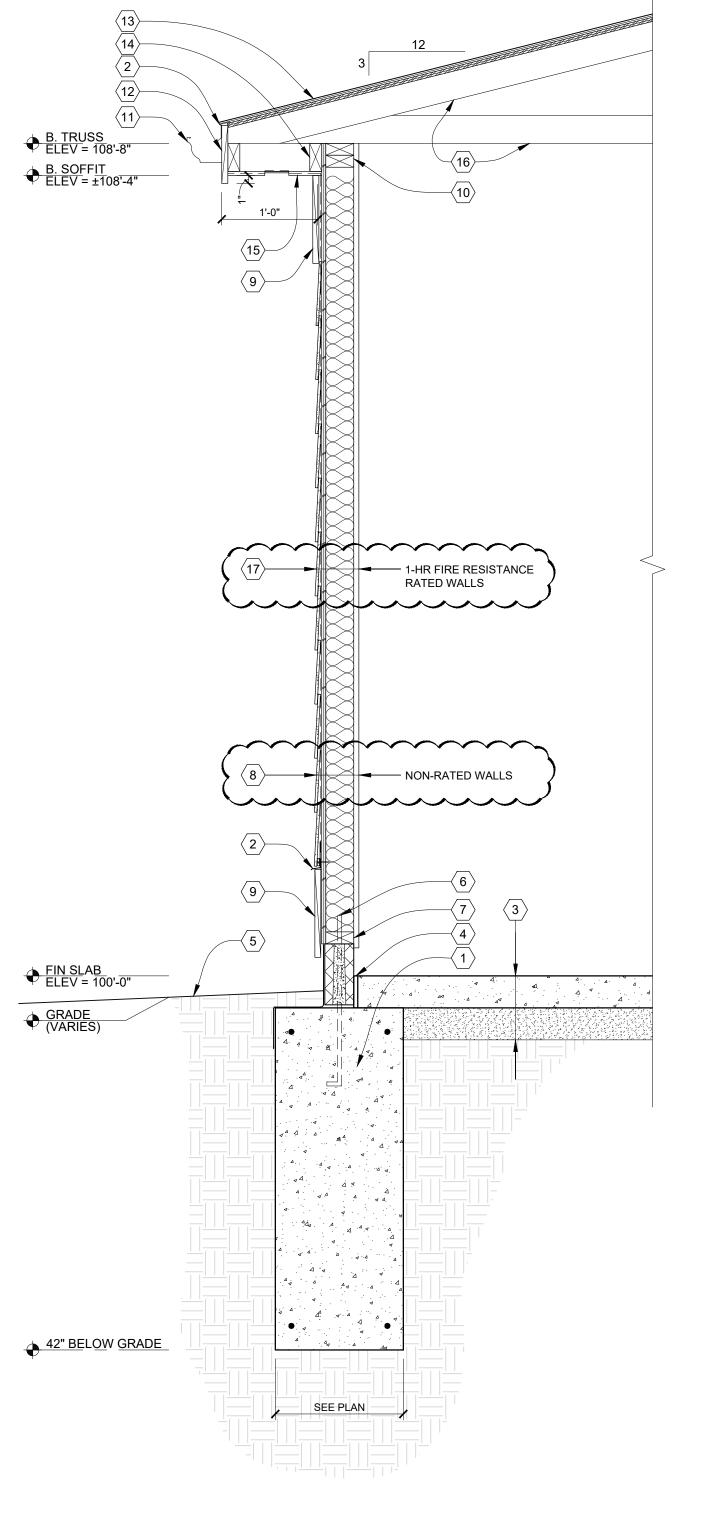

1 WALL SECTION

A3.2 SCALE: 1"=1'-0"

WALL SECTION KEY NOTES: (TYPICAL THIS SHEET ONLY)

\langle 1 \rangle CONCRETE TRENCH FOOTING w/ #4 BARS 24" O.C. VERT. AND 24" O.C. HORIZ.

- (2) CONTINUOUS PRE-FINISHED ALUMINUM FLASHING w/ DRIP EDGE
- 3 SLAB ON GRADE 4" CONCRETE SLAB ON 6 MIL. VAPOR BARRIER ON 4" COMPACTED SAND BASE.
- $\langle 4 \rangle$ 1/2" EXPANSION JOINT.
- 5 INDICATES LINE OF GRADE; PITCH AWAY FROM STRUCTURE
- $\langle 6 \rangle$ 1/2" ANCHOR BOLT @ 32" O.C. 12" FROM CORNERS AND ENDS

7 2x4 MRT SILL PLATE w/ SILL SEALER \langle 8 \rangle EXTERIOR NON- RATED WALL JAMES HARDIE SIDING w/ 8" REVEAL (OR ALT. VINYL SIDING) ON AIR INFILTRATION BARRIER ON 1/2" APA RATED SHEATHING ON 2x4 WD STUDS @ 16" O.C. ON 1/2" GYP. BD. (GYP. BD FINISH OPTIONAL. COORDINATE w/

- \langle 9 \rangle 1x_ TRIM BOARD; MRT, PAINT. COORDINATE w/ EXTERIOR ELEVATIONS
- (10) 2x4 DOUBLE TOP PLATE
- (11) CONTINUOUS PRE-FINISHED SEAMLESS ALUM. GUTTER SYSTEM
- $\langle 12 \rangle$ 1x8 MRT WD. FASCIA BD; PRIME & PAINT
- (13) ROOFING 25 YR ARCHITECTURAL SHINGLES ON 15# FELT (TAPE) ON 1/2" APA RATED SHEATHING - SEE ROOF PLAN
- $\langle 14 \rangle$ 2x WD. BLOCKING/ FRAMING
- (15) PRE-FINISHED VENTED SOFFIT PANELS
- (16) PRE-MANUFACTURED ROOF TRUSSES @ 24" O.C. $\langle 17 \rangle$ EXTERIOR 1-HR RATED WALL JAMES HARDIE SIDING w/ 8"
- REVEAL (ALT. VINYL SIDING) ON AIR INFILTRATION BARRIER ON 1/2" APA RATED SHEATHING ON 2x4 WD STUDS @ 16" O.C. w/ MINERAL WOOL INSULATION, 4 MIL VAPOR BARRIER AND 5/8" TYPE X GYP. BD. AT INTERIOR FACE OF WALL; INSTALL PER AMERICAN WOOD COUNCIL ASSEMBLY WS4-1.3; SEE DESCRIPTION, THIS SHEET.

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ISSUED	
12.02.20	BIDS/ PERMITS
12.18.20	ADDENDUM #1

FILE 1939_A3.3_GarageSections.dwg DRAWN RILEY L. RINNAN CHECKED KEVIN J.CROSBY

CLIENT CHARLES WILLIAMS

PROJECT WILLIAMS RESIDENCE ADDITION

550 FISKE FISKE DR DETROIT, MI 48214

GARAGE SECTIONS

















Exterior View

36 in. x 80 in. 9 Lite Primed Steel Prehung Left-Hand Inswing Back Door with Brickmould



by JELD-WEN >

**** (83) V

Write A Review

Questions & Answers (41)

- Made of durable rust-resistant galvanized steel
- Prehung steel door includes frame for easier installation
- Actual unit size is 37-7/16 in. x 81-3/4 in.
- See More Details

\$29574

Save up to \$100 on your qualifying purchase.

Apply for a Home Depot Consumer Card

Common Door Size (WxH) in.: 36 x 80

32 x 80

36 x 80

Door Handing: Left-Hand/Inswing

Left-Hand/Inswing

Right-Hand/Inswing

How to Get It

Internet #100658149 Model #0601180 Store SKU #775276



















Timberline Natural Shadow Charcoal Algae Resistant Architectural Shingles (33.33 sq. ft. per Bundle) (21-pieces)

by GAF >



Write A Review

Questions & Answers (120)

Detroit 7 Mile/Meyers Store



✓ 144 in stock Aisle 16, Bay 030 Text to Me

Architectural asphalt shingles covered by Lifetime Ltd. Warranty

- Classic Natural Shadow® effect provides look of even-toned wood
- Class A fire rating & 130 mph wind warranty provide peace of mind
- See More Details



598 /bundle Buy 36 or more \$22.08 /bundle

Save up to \$100 on your qualifying purchase.

Apply for a Home Depot Consumer Card

Color/Finish: Charcoal














Internet #303866775 Model #TR4SAMPLNS

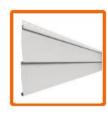













Take Home Sample Transformations Double 4 in. x 24 in. Vinyl Siding in Stone Gray



by Ply Gem > (Brand Rating: 3.8/5) 1



Write A Review

Questions & Answers (11)

- 0.040 in. thickness for superior resistance to impact
- Oversized lock mechanism and full-length return for secure setup
- Backed by manufacturer's limited lifetime warranty
- See More Details

\$849

Save up to \$100 on your qualifying purchase.

Apply for a Home Depot Consumer Card

Color/Finish: Ivory



How To Get it

This item is currently out of stock