## HDC2024-00183

## APPROVAL DOCUMENT - POST AT WORK LOCATION

CITY OF DETROIT HISTORIC DISTRICT COMMISSION 2 WOODWARD, SUITE 808 DETROIT, MICHIGAN 48226

05/14/2024

## **CERTIFICATE OF APPROPRIATENESS**

Anthony Askew
Edmund Place Partners LLC
64 Edmund Place
Detroit, MI 48202

RE: Application Number HDC2024-00183; 64 Edmund Place; Brush Park Historic District Scope: Erect rear addition and roof decks, restore full-width front porch, install windows

Dear Applicant,

At the Regular Meeting that was held on May 8, 2024, the Detroit Historic District Commission ("DHDC") reviewed the above-referenced application. Pursuant to Section 5(1) of the Michigan Local Historic District Act, as amended, being MCL 399.205 (1) and Sections 21-2-73/21-2-78 of the 2019 Detroit City Code; the DHDC hereby issues a Certificate of Appropriateness ("COA") for the following work, effective on May 14, 2024, as it meets the Secretary of Interior's Standards for Rehabilitation and the district's Elements of Design:

Per the attached drawings and documentation, erect rear addition and roof decks, restore full-width front porch, install windows

With the following conditions:

- The four chimneys on the main house be repaired and preserved.
- The "doghouse" elements housing the new stairs to the mid-building roof deck be redesigned to be less obtrusive, via internal reconfiguration of the stairs, the introduction of glass planes to allow greater transparency through the elements, and/or reintroduction of a rooftop balustrade as seen in historic photographs.
- Window product selection and configuration throughout the rehabilitated areas of the building will be true wood or aluminum-clad wood units, with vertically oriented double-hung configuration compatible with Italianate or Colonial Revival examples. A new front elevation depicting revisions to the first-floor, front-facing windows shall be submitted.

Please retain this COA for your files and post it at the subject property until work is complete. It is important to note that approval by the DHDC does not waive the applicant's responsibility to comply with any other applicable

ordinances or statutes. If you have any questions regarding the foregoing, please contact staff at 313-224-1762 or hdc@detroitmi.gov.

For the Commission:

Garrick B. Landsberg

Director of Historic Preservation, Staff to the Commission





April 15, 2024

64 Edmund Pl., Detroit, MI 48201

RE: 64 Edmund Renovations, District Historic Commission Submission

### **Project Narrative**

64 Edmund Place is a large residential building in the historic Brush Park neighborhood whose construction dates back to the 1800s. The prominent brick home sits in the middle of the block, between Woodward Ave. and John R. St. Currently, the structure has extensive damage due to age and neglect. The intent of this project is to turn 64 Edmund Pl. into a 3-unit multifamily residence with modern amenities, while maintaining its historic character.

The structure is two stories, clad on all four sides with brick. It features tall window bays, several of which have notable arching brick headers. No original windows remain. All new windows in existing bays will be Anderson 400 series single-hung in black. The front facade features a covered wood porch and stair to a central entry. Above is a centered rectangular window bay and circular window bay. Historic photos show the current porch is not original to the structure, and it is not seen as contributing to its historic character. It will be demolished, and a new covered wood porch and stair will be constructed, to align with the home's character. It will feature painted wood columns and railings. The west facade features a protruding wood bay window near the street, which will be repaired using in-kind materials and painted to match the porch. A new wood porch and entry will be added to the west side of the structure, in place of a previously existing window. This porch will have a modern black aluminum railing. All exterior detailing will be repaired as required with in-kind materials. Existing bricks will be tuckpointed as required.

The existing roof on the north mass of the structure is a square hip, with 2 brick chimneys on 2 sides. The peak of the hip is flat, with a pointed skylight feature. Damaged roof elements will be removed and replaced with new wood roof trusses. The roof will be clad with asphalt shingles. The chimneys will also be removed.. Roof eave detailing similar to that seen in historic photos will be added on the front facade and wrap the sides of the hip roof. The roof of the south portion has extensive damage, and what



remains will be demolished. A new membrane roof will be constructed in its place.

A new 3rd story doghouse and roof deck will be constructed on top of the existing structure. The doghouse structure will be clad in Hardie board and batten siding (final color TBD). Its modern appearance will differentiate it from the historic structure, but its small stature allow it to still be complementary. The roof deck, divided between 2 units, will have a modern composite decking and aluminum railing.

The interior walls and floors of the existing structure will be demolished as required, and rebuilt. There will be new mechanical, electrical, and plumbing systems. The existing basement will be excavated approximately 2'-0".

A new 2-story addition will be constructed at the structure's rear. The south wall of the existing structure will be demolished as required to facilitate access to the addition. Like the doghouses, it is intended to be notably visually different from, but still a complement to, the historic structure. It will have three 2-car garages, with living spaces and a private roof deck above. The first floor will be clad in a brick that coordinates with the existing structure. The second floor will be clad in the same Hardie board and batten siding as the 3rd story doghouses. The addition will have a shallow gable roof, with two single-sloped dormers facing the rear. It will feature tall window bays on each side, using the same Anderson 400 series windows in black seen throughout the project. Sliding glass doors, also Anderson 400 series, and a modern full-lite exterior door will open to the roof deck. This roof deck will be the same modern composite decking and aluminum railing as the others.



April 15, 2024

64 Edmund Pl., Detroit, MI 48201

RE: 64 Edmund Renovations, District Historic Commission Submission

### Scope of Work

- 1. Demolition of interior walls and floors
- 2. Demolition of southeast (rear) exterior wall
- 3. Demolition of existing front porch
- 4. Removal of damaged roof elements on northwest mass
  - a. Removal of existing chimneys
- 5. Removal of remaining roof elements on southeast mass
- 6. Excavate existing basement level (+/- 2'-0")
  - a. Underpin existing foundation walls as required
  - b. Construct new basement slab
- 7. Replace missing windows in existing openings
  - a. Anderson 400 series single hung windows in black
  - b. Void spaces below new windows to be clad with black metal panel
- 8. Existing bay window to be repaired using in-kind materials and painted
- 9. Construct new painted wood front porch
  - a. Porch covering, columns, and railings to be painted wood
- 10. Construct new side entry porch
  - a. Masonry with black aluminum railing
- 11. Demolish west exterior wall as required for new side entry door in existing window space
- 12. Construct new membrane roof on existing southeast mass
- 13. Repair/Replace existing exterior detailing as required using in-kind materials



- 14. Construct new 3rd story doghouses and roof decks on existing building
  - a. To be clad with Hardie board and batten siding in rich espresso
  - b. Windows to be Anderson 400 series in black
  - c. Roof decks to be Trex Signature in whidbey with aluminum railing in black
  - d. Stained wood trellis overhead

#### 15. Build out interior

- a. New wood framed floors and walls
- b. Existing masonry walls to be furred out with wood framing and gyp. bd. interior
- c. Coordinate new mechanical, electrical, and plumbing systems

### 16. Construct new rear addition

- a. 1st floor brick to coordinate with existing
- b. 2nd floor clad in Hardie board and batten siding in rich espresso
- c. Windows and sliding doors to be Anderson 400 series in black
- d. Roof deck to be Trex Signature in whidbey with aluminum railing in black

# THE STANDART HOUSE

## MULTI-FAMILY RESIDENTIAL RENOVATION

64 EDMUND PLACE, DETROIT, MI 48201

ARCHITECT
4545 ARCHITECTURE | DESIGN
TIMOTHY FLINTOFF
2761 E. JEFFERSON, SUITE 302

## **PROJECT DATA**

BUILDING CODE AUTHORITY: CITY OF DETROIT

DETROIT, MI 48207

APPLICABLE CODES:

BUILDING CODE ALSO KNOWN AS THE "MICHIGAN RESIDENTIAL BUILDING CODE" 2015 MICHIGAN RESIDENTIAL CODE (MRC) AS AMENDED

MECHANICAL CODE ALSO KNOWN AS THE "MICHIGAN MECHANICAL CODE" 2015 MICHIGAN MECHANICAL CODE AS AMENDED

PLUMBING CODE ALSO KNOWN AS THE "MICHIGAN PLUMBING CODE" 2018 MICHIGAN PLUMBING CODE AS AMENDED

ELECTRICAL CODE
ALSO KNOWN AS THE "MICHIGAN ELECTRICAL CODE"
2017 NATIONAL ELECTRIC CODE (NEC) AS AMENDED & MICHIGAN AMMENDMENTS PART 8.

ENERGY CODE 2015 UNIFORM ENERGY CODE

BARRIER FREE REQUIREMENTS AMERICANS WITH DISABILITIES ACT (ADA) MBC-2015, CHAPTER 11 ICC / ANSI 117.1 - 2010, EXCEPT SECTION 611 & 707 PROJECT DESCRIPTION:
RENOVATION OF EXISTING RESIDENTIAL BUILDING & NEW CONSTRUCTION ADDITION INTO MULTIFAMILY HOUSING (3 UNITS)

BUILDING DATA:

STORIES: 2 + BASEMENT

SPRINKLERED: NO

ENERGY EFFICIENCY
COMPLY WITH SECTION N102 OF THE 2015 MICHIGAN RESIDENTIAL CODE

CLIMATE ZONE: 5A
CEILING: R-38
WOOD FRAMED WALL: R-20 OR R-13(CAVITY)+R5(SHEATHING)

MASS WALL:

FLOOR:

R-20/R-17

R-30 OR FILL CAVITY, R-19 MIN.

SLAB:

R-10 (2'-0" DEEP)

 BUILDING HEIGHTS:
 FROM GRADE
 CEILING HEIGHT

 BASEMENT
 -(5'-10")
 9'-0"

 FIRST FLOOR
 4'-2"
 10'-6"

 SECOND FLOOR
 15'-8"
 9'-0"


 ROOF (HIGH POINT)
 36'-5"

PARKING

2 GARAGE SPACES/UNIT

**BUILDING AREAS:** 

UNIT	AREA
UNIT 1	4042 GSF
UNIT 2	4050 GSF
UNIT 3	3560 GSF
TOTAL BUILDING	11,652 GSF

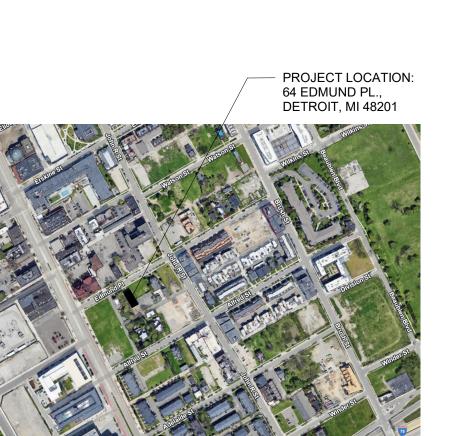






## **SHEET INDEX**

SP1.1	SITE PLAN
A1.1	BASEMENT FLOOR PLAN
A1.2	FIRST FLOOR PLAN
A1.3	SECOND FLOOR PLAN
A1.4	ROOF PLAN
A3.1	EXTERIOR ELEVATIONS
A3.2	EXTERIOR ELEVATIONS

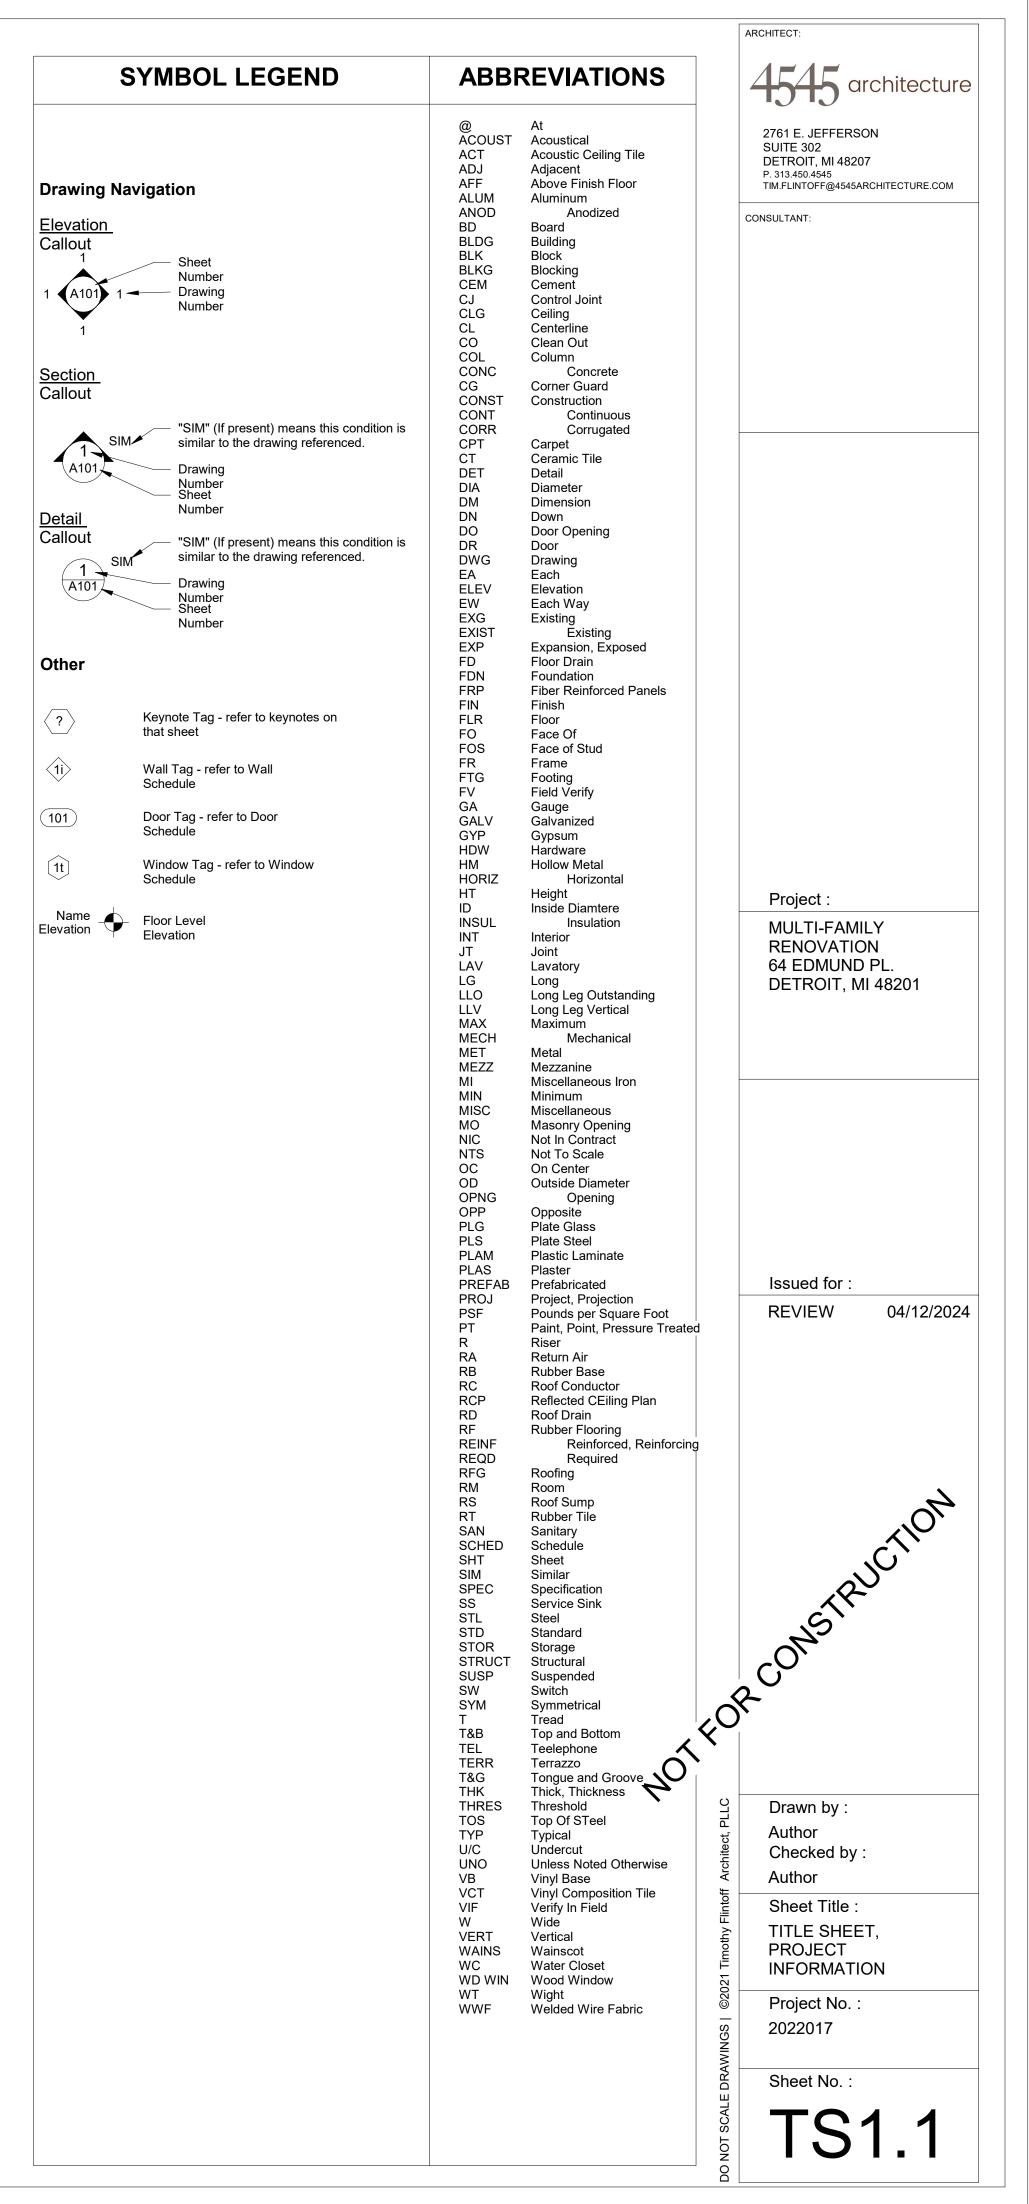



**GENERAL NOTES:** 

THIS DRAWING IS DIAGRAMMATIC AND SHOULD BE USED TO DETERMINE THE DESIGN INTENT. THE CONTRACTOR IS RESPONSIBLE FOR THE COMPLETE SET OF WORK AS INDICATED AND SHALL FIELD VERIFY ALL WORK, COORDINATE ALL DRAWINGS / NEW WORK AND SHALL NOTIFY ARCHITECT IMMEDIATELY OF ANY DISCREPANCIES IN THE DOCUMENTS BEFORE PROCEEDING. FAILURE TO DO SO WILL RESULT IN THE CONTRACTOR TAKING FULL RESPONSIBILITY AND LIABILITY FOR SAID DISCREPANCIES.

ALL DIMENSIONS ARE SHOWN FROM FINISH FACE TO FINISH FACE OF PARTITION UNLESS OTHERWISE NOTED.

3. WALL THICKNESS' ARE NOMINAL NOT ACTUAL DIMENSIONS. SEE WALL SCHEDULE FOR ACTUAL DIMENSIONS.

4. ALL WORK SHALL BE DONE IN ACCORDANCE WITH ALL LOCAL, STATE, COUNTY CODE REGULATIONS, O.S.H.A., AND THE AMERICAN WITH DISABILITIES ACT (ADA). REFER TO THE CODE PLAN FOR MORE

5. DO NOT BACKFILL WALLS UNTIL FLOOR DECKS ARE INSTALLED

ALL POSTS CONTINUOUS TO FOUNDATION

7. SHEAR WALLS TO BE PERSCRIPTIVE PER MBC 2015

26' - 7" 140' - 6" 14' - 0" 92' - 11" 47' - 7" EXISTING 2 STORY
MULTI-FAMILY BUILDING
3,732 GSF FOOTPRINT NEW 2 STORY CARRIAGE
HOUSE BUILDING 1,988 GSF FOOTPRINT EGRESS EGRESS CONC. WALK . 167' - 0" ් ත LOT DEPTH

1 CONCEPTUAL SITE PLAN
SCALE: 1/8" = 1'-0"

2761 E. JEFFERSON SUITE 302

DETROIT, MI 48207

P. 313.450.4545 TIM.FLINTOFF@4545ARCHITECTURE.COM

ARCHITECT:

CONSULTANT:

Project:

**MULTI-FAMILY** RENOVATION 64 EDMUND PL. DETROIT, MI 48201

Issued for: 04/12/2024


REVIEW


Drawn by : Author Checked by:

Sheet Title: SITE PLAN

Project No. : 2022017

Sheet No.:

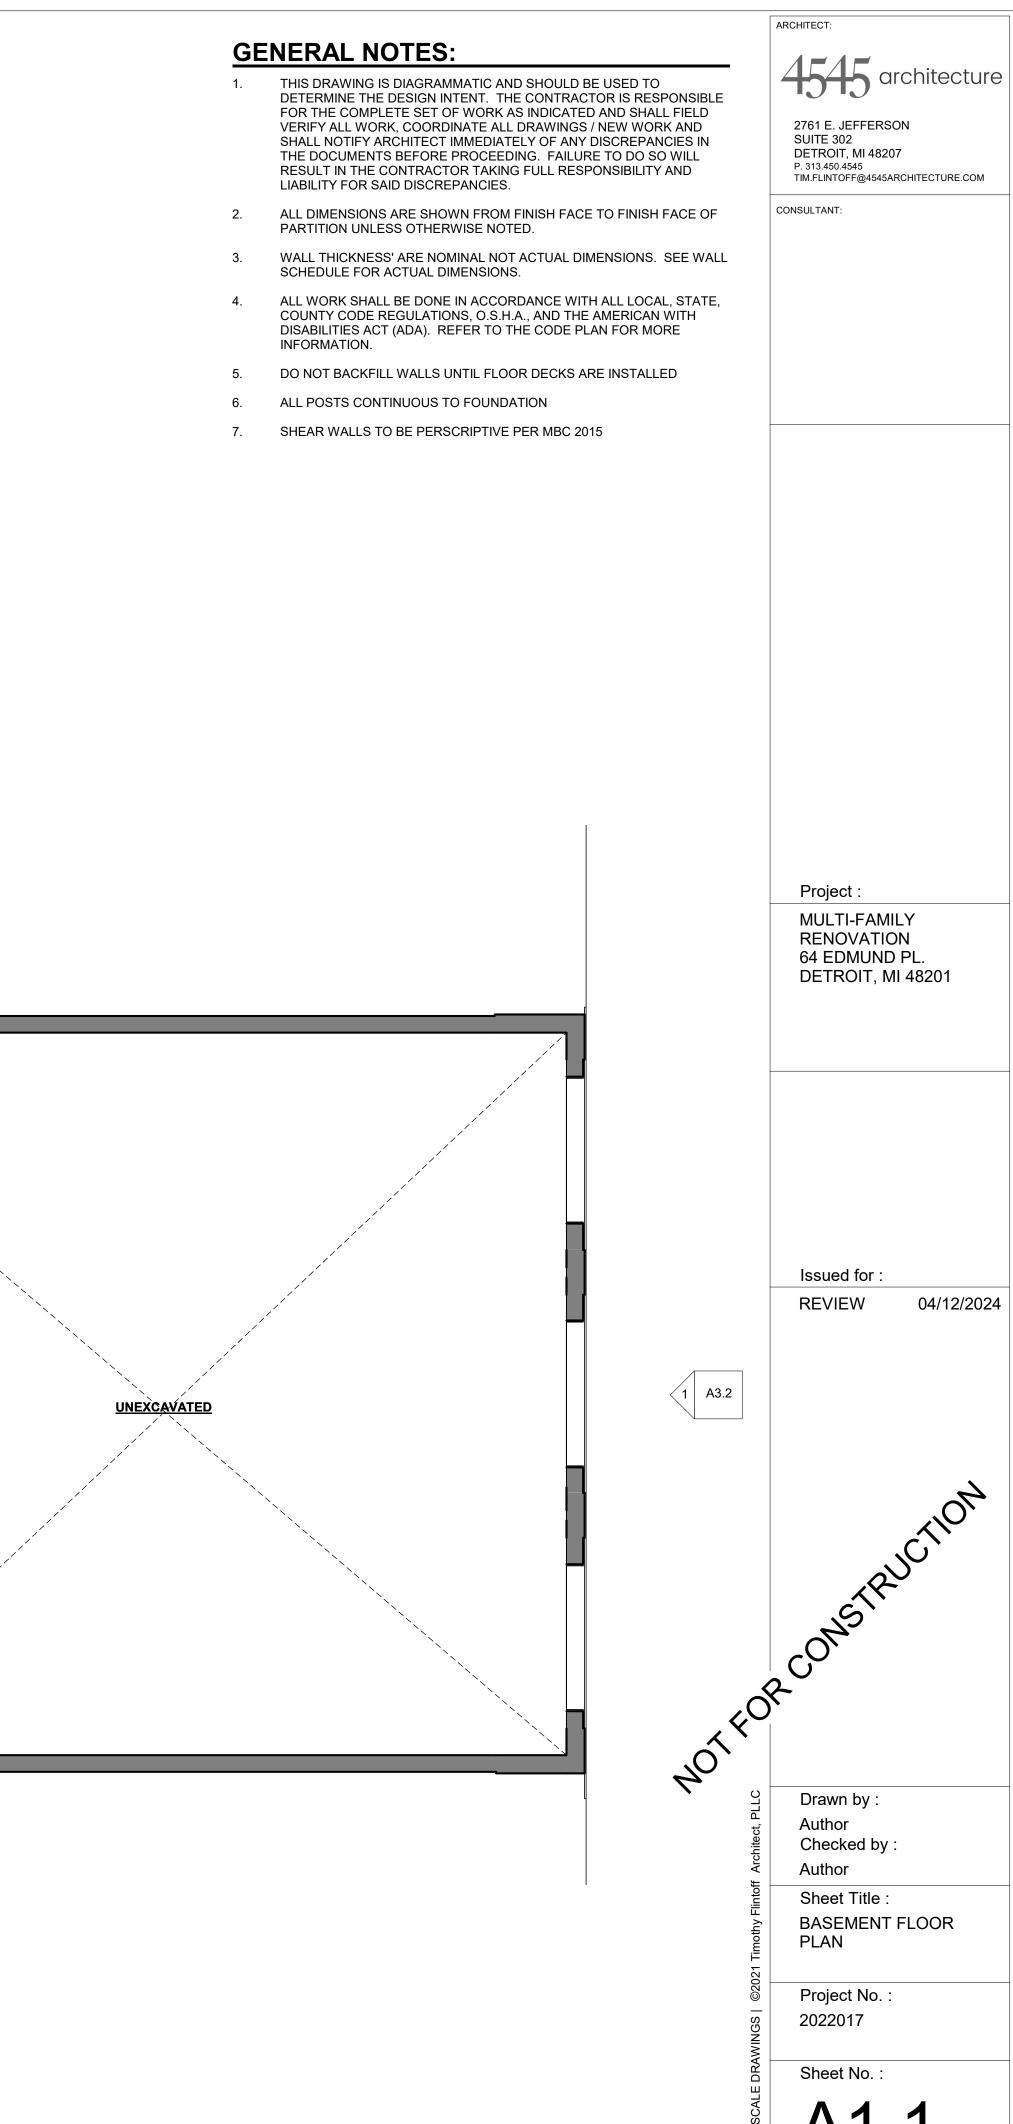


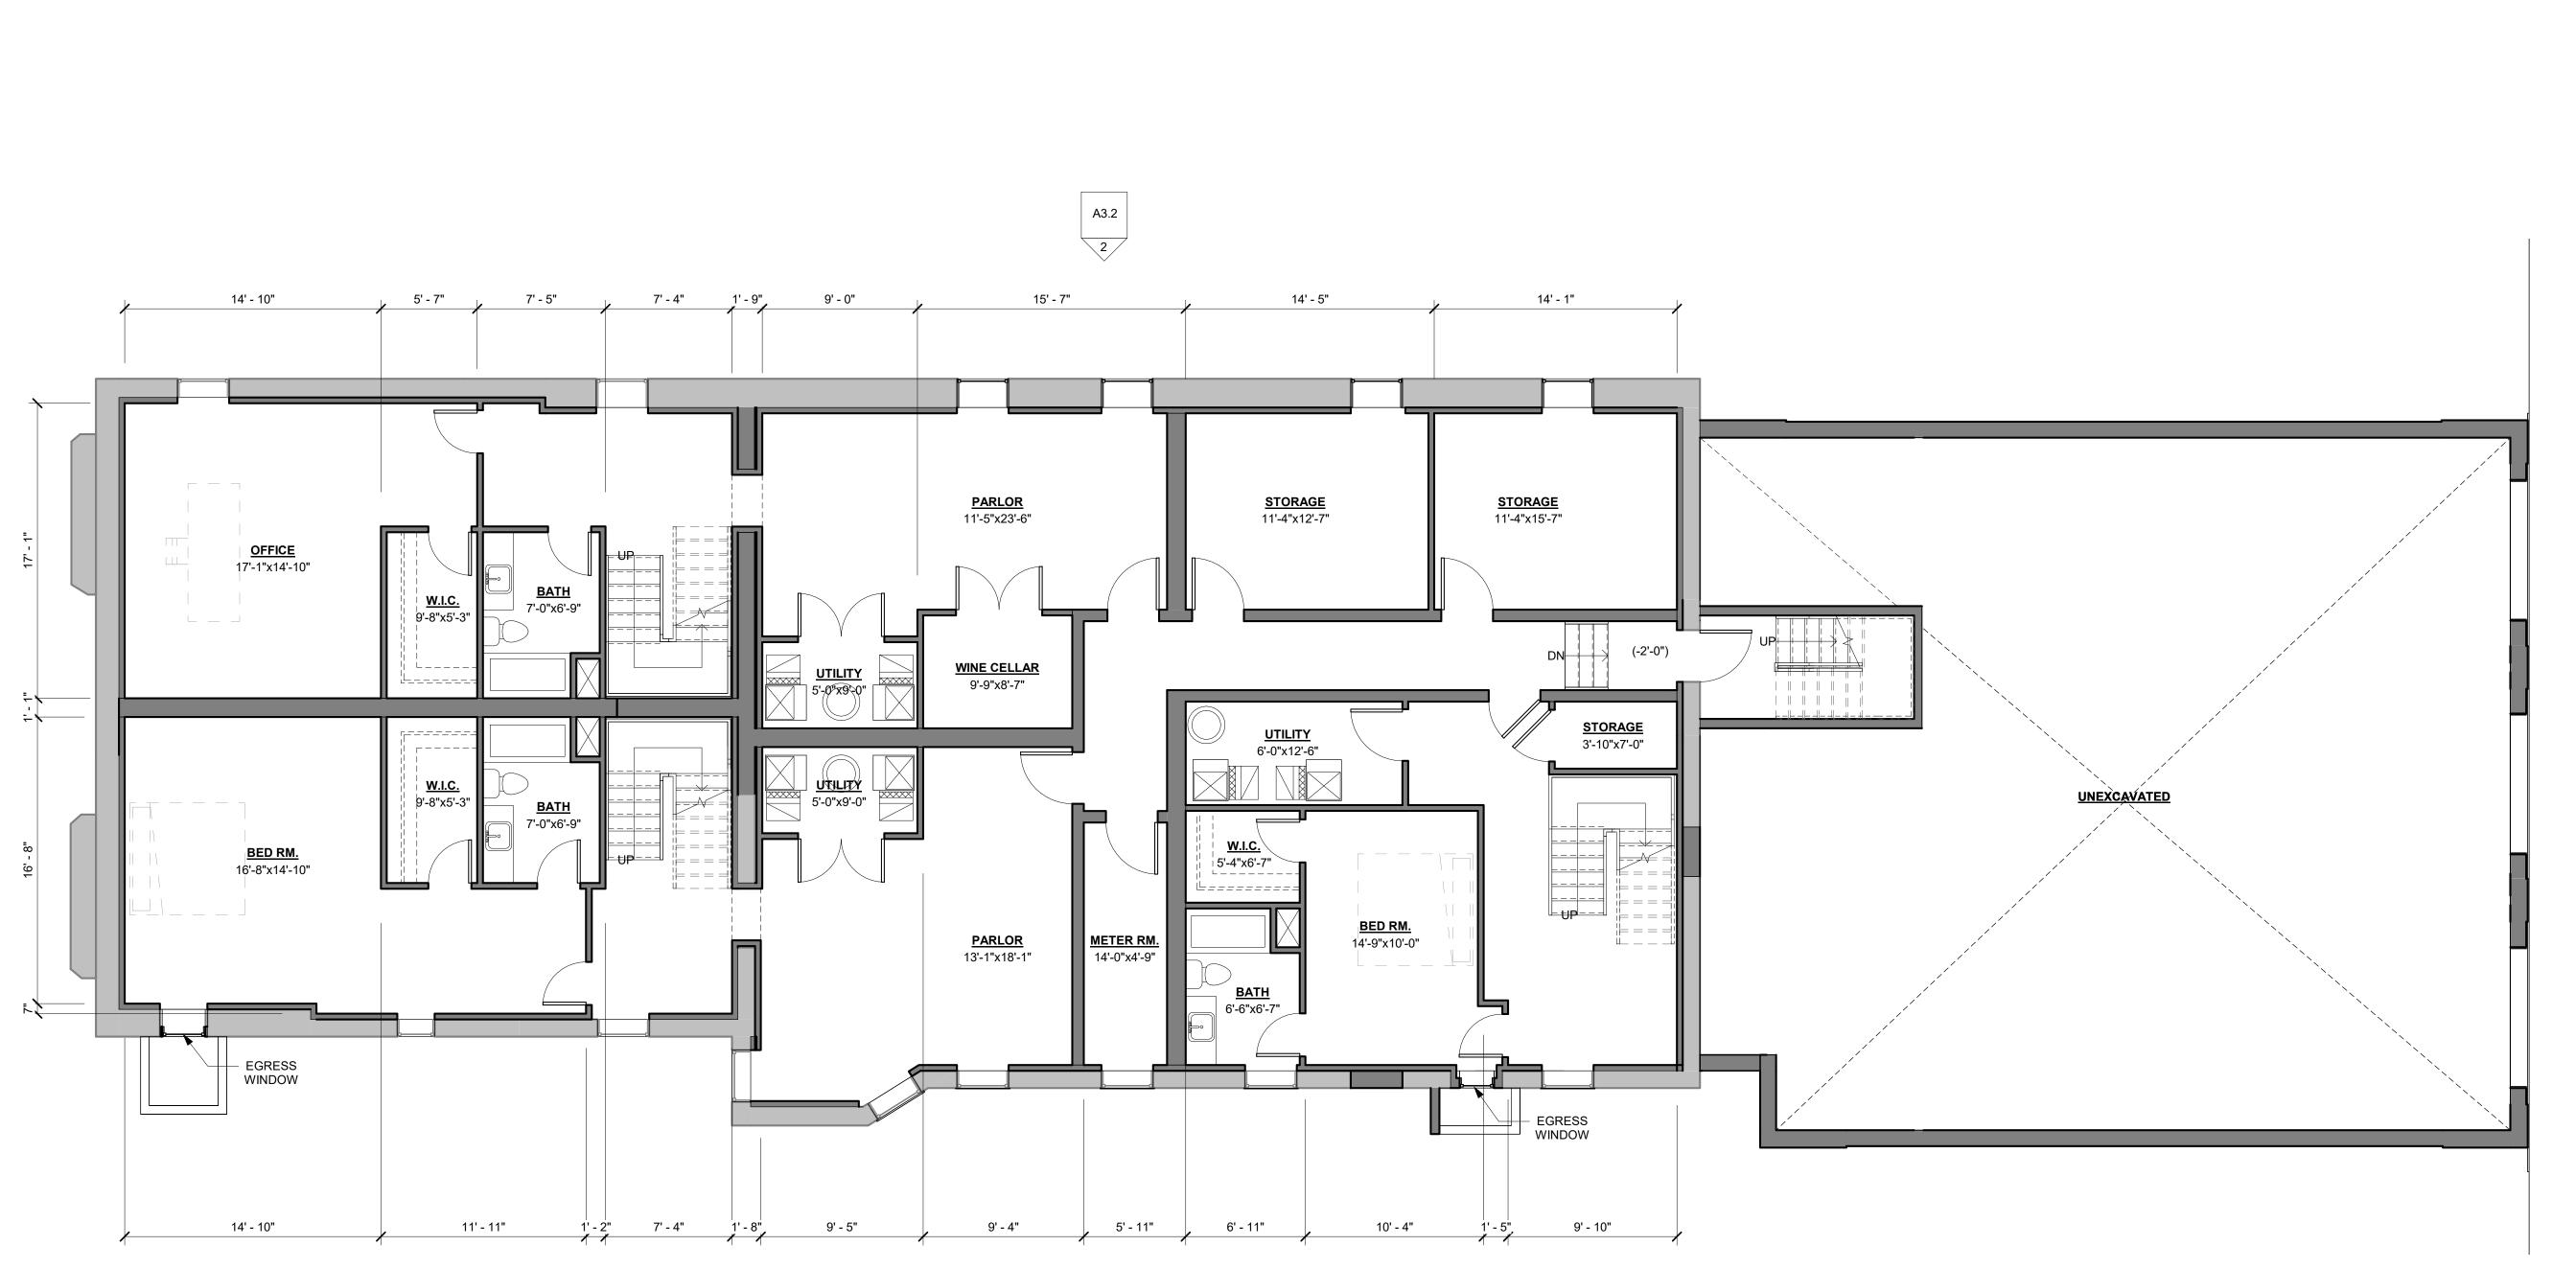

A3.1

A3.1 1

**BASEMENT**SCALE: 3/16" = 1'-0"

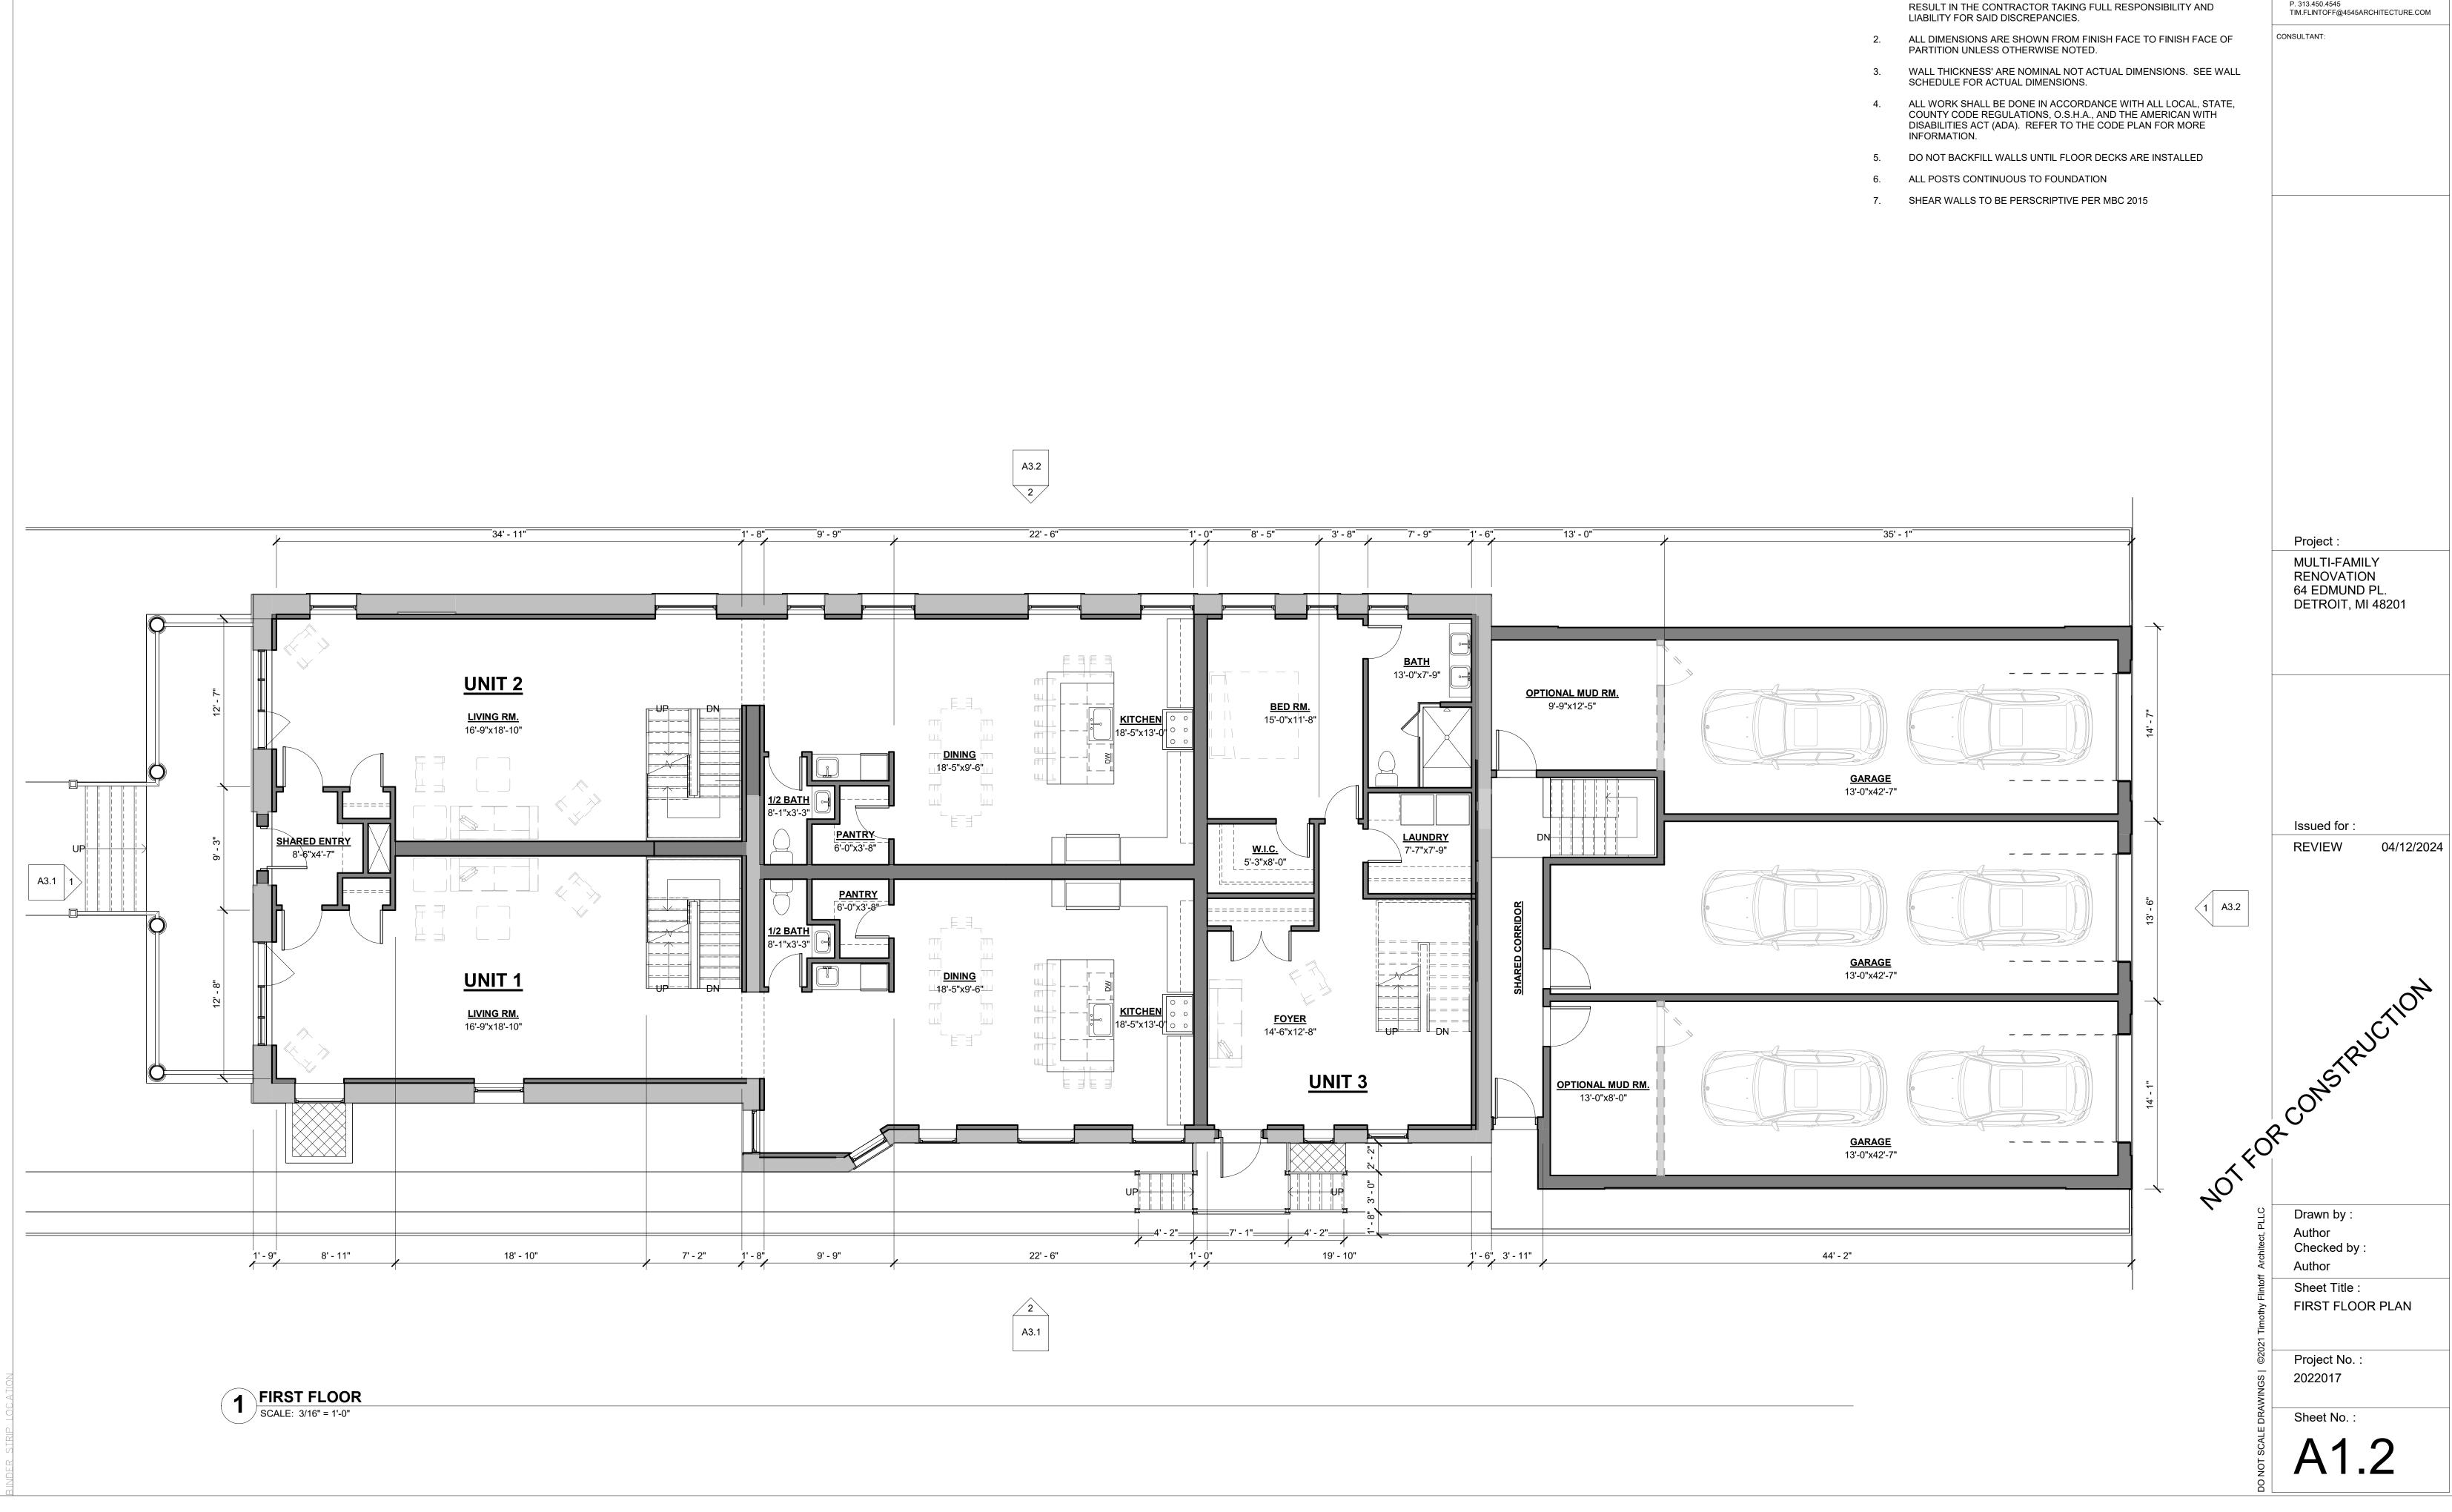

ARCHITECT:

**GENERAL NOTES:** 

THIS DRAWING IS DIAGRAMMATIC AND SHOULD BE USED TO

DETERMINE THE DESIGN INTENT. THE CONTRACTOR IS RESPONSIBLE FOR THE COMPLETE SET OF WORK AS INDICATED AND SHALL FIELD


VERIFY ALL WORK, COORDINATE ALL DRAWINGS / NEW WORK AND

THE DOCUMENTS BEFORE PROCEEDING. FAILURE TO DO SO WILL

SHALL NOTIFY ARCHITECT IMMEDIATELY OF ANY DISCREPANCIES IN


4545 architecture

2761 E. JEFFERSON SUITE 302 DETROIT, MI 48207 P. 313.450.4545

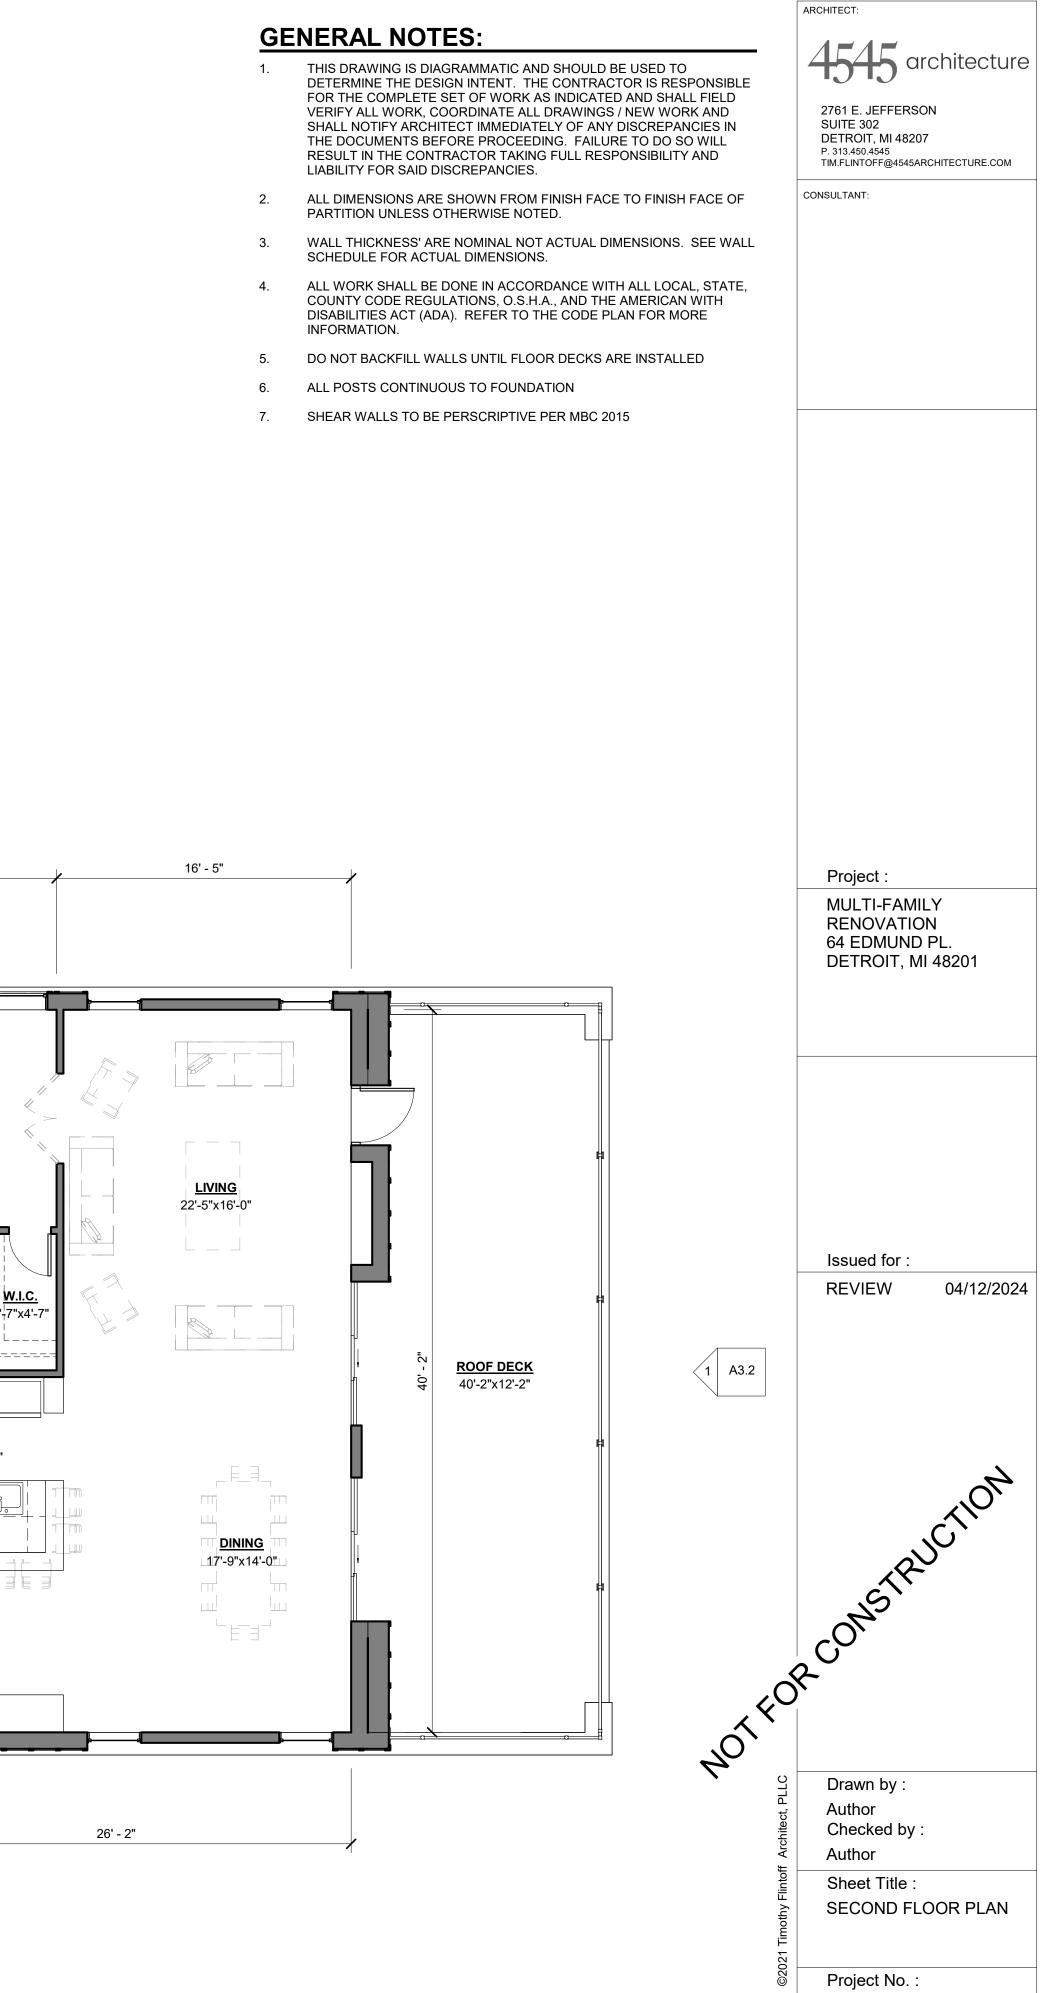

2022017

Sheet No.:

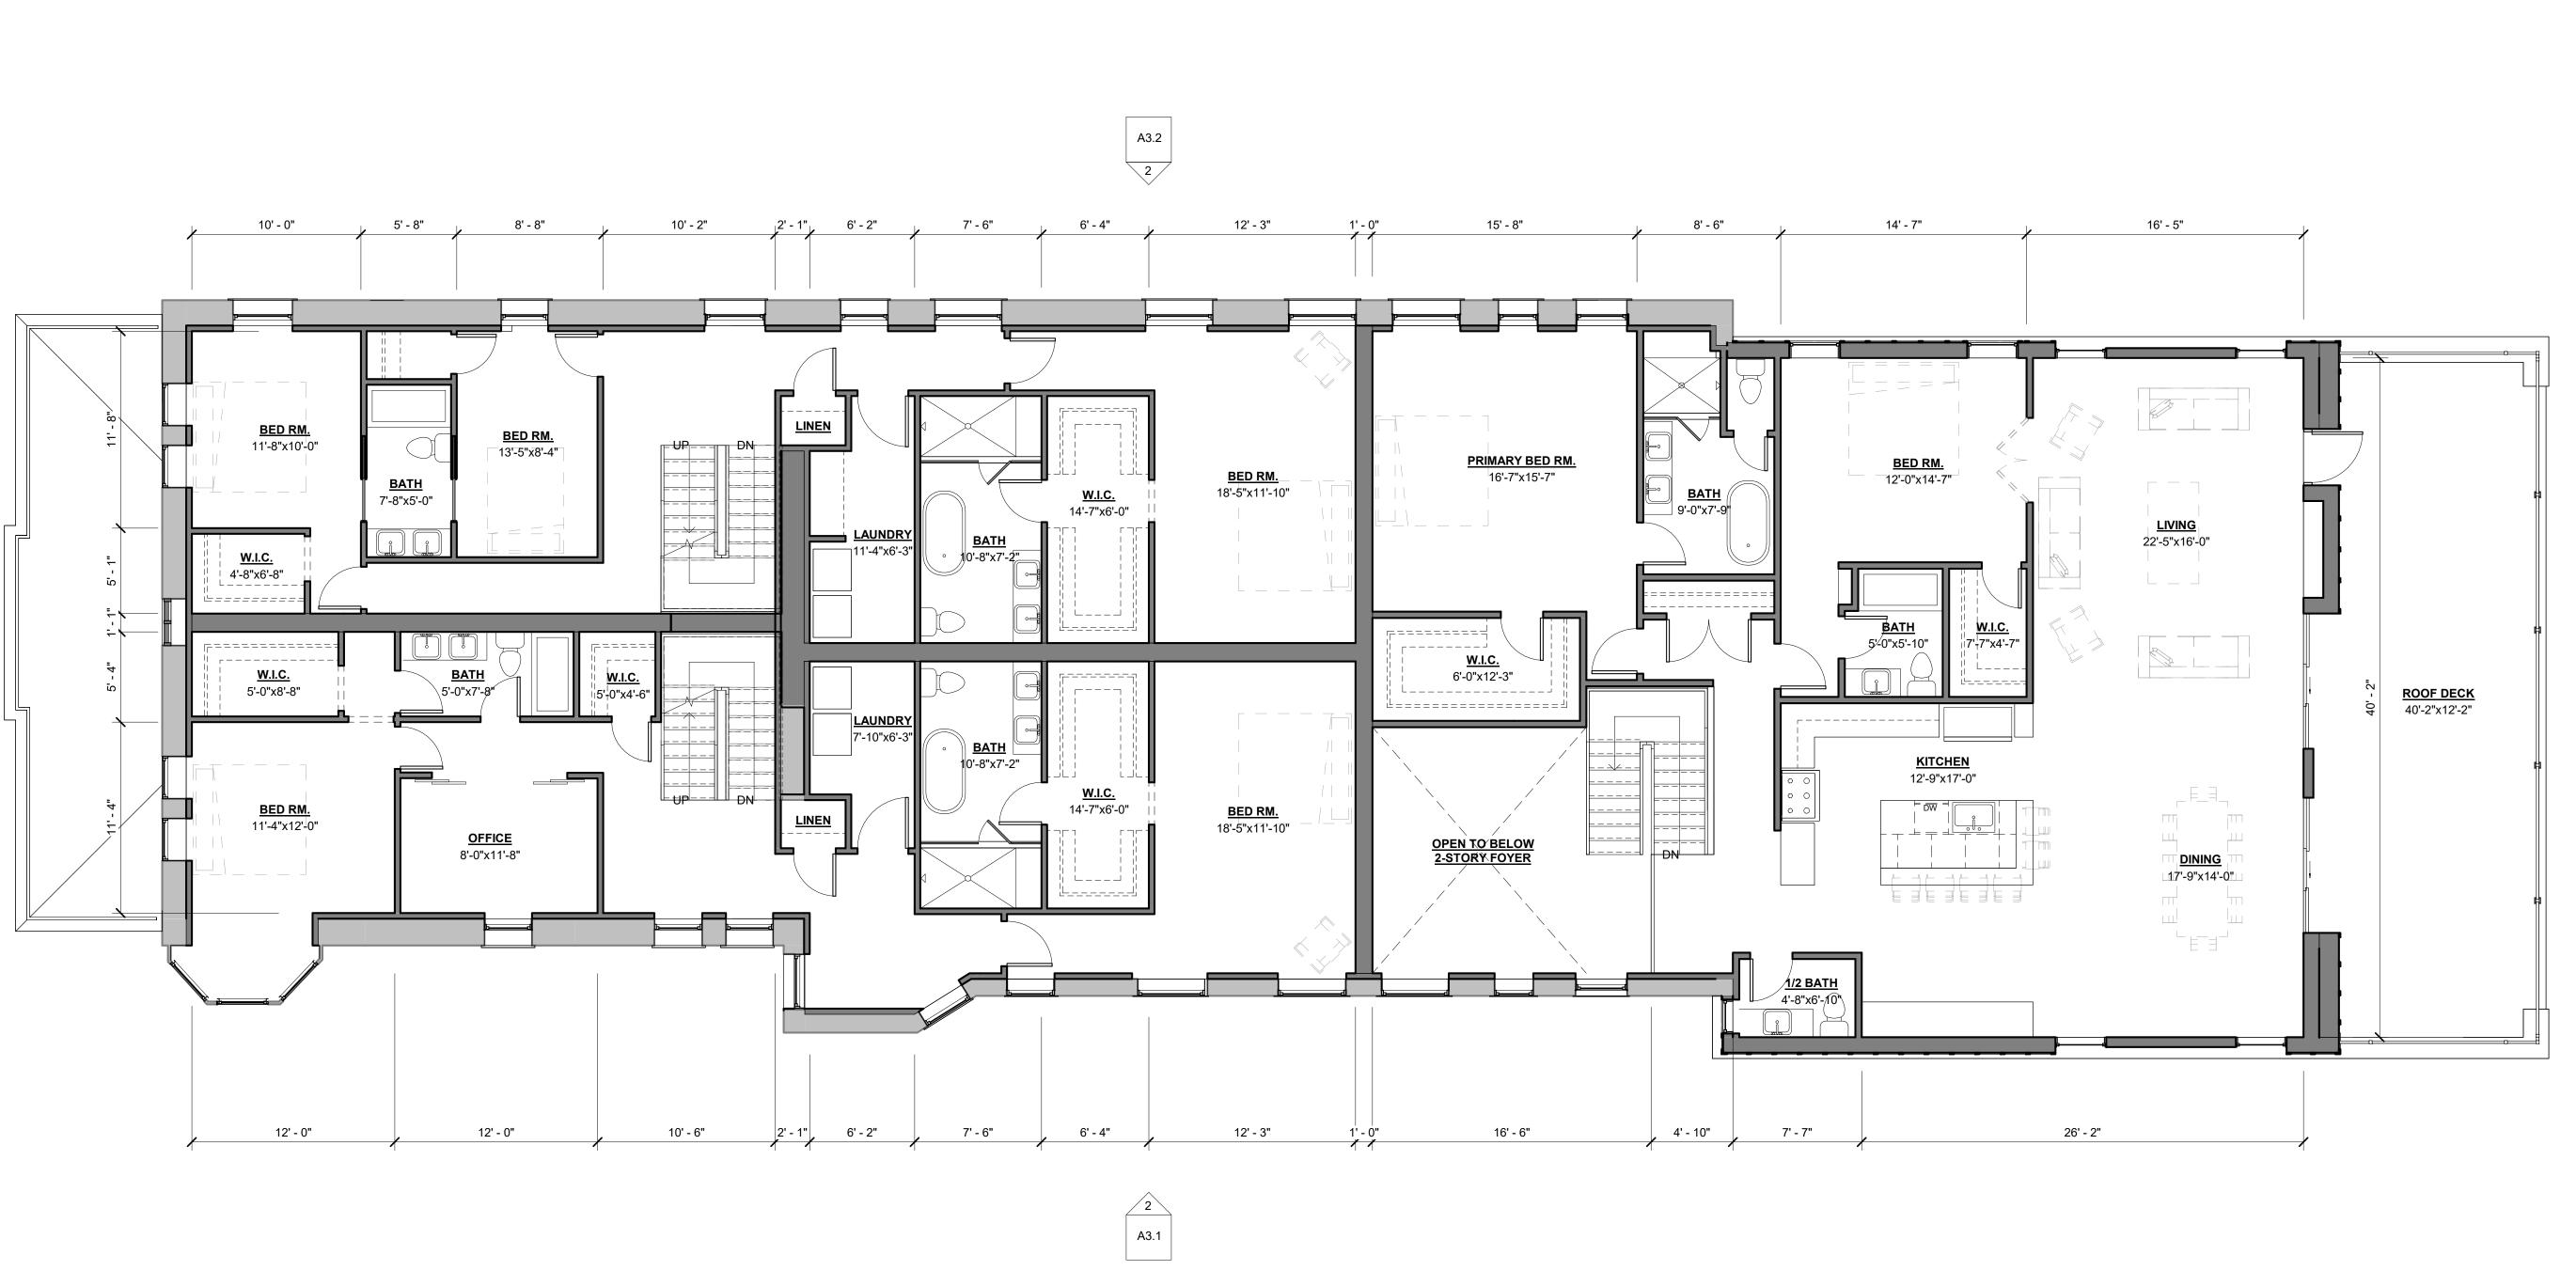


A3.1 1

SECOND FLOOR
SCALE: 3/16" = 1'-0"

## **GENERAL NOTES:**

- 1. THIS DRAWING IS DIAGRAMMATIC AND SHOULD BE USED TO DETERMINE THE DESIGN INTENT. THE CONTRACTOR IS RESPONSIBLE FOR THE COMPLETE SET OF WORK AS INDICATED AND SHALL FIELD VERIFY ALL WORK, COORDINATE ALL DRAWINGS / NEW WORK AND SHALL NOTIFY ARCHITECT IMMEDIATELY OF ANY DISCREPANCIES IN THE DOCUMENTS BEFORE PROCEEDING. FAILURE TO DO SO WILL RESULT IN THE CONTRACTOR TAKING FULL RESPONSIBILITY AND LIABILITY FOR SAID DISCREPANCIES.
- 2. ALL DIMENSIONS ARE SHOWN FROM FINISH FACE TO FINISH FACE OF PARTITION UNLESS OTHERWISE NOTED.
- 3. WALL THICKNESS' ARE NOMINAL NOT ACTUAL DIMENSIONS. SEE WALL SCHEDULE FOR ACTUAL DIMENSIONS.
- 4. ALL WORK SHALL BE DONE IN ACCORDANCE WITH ALL LOCAL, STATE, COUNTY CODE REGULATIONS, O.S.H.A., AND THE AMERICAN WITH DISABILITIES ACT (ADA). REFER TO THE CODE PLAN FOR MORE INFORMATION.
- 5. DO NOT BACKFILL WALLS UNTIL FLOOR DECKS ARE INSTALLED
- 6. ALL POSTS CONTINUOUS TO FOUNDATION
- 7. SHEAR WALLS TO BE PERSCRIPTIVE PER MBC 2015

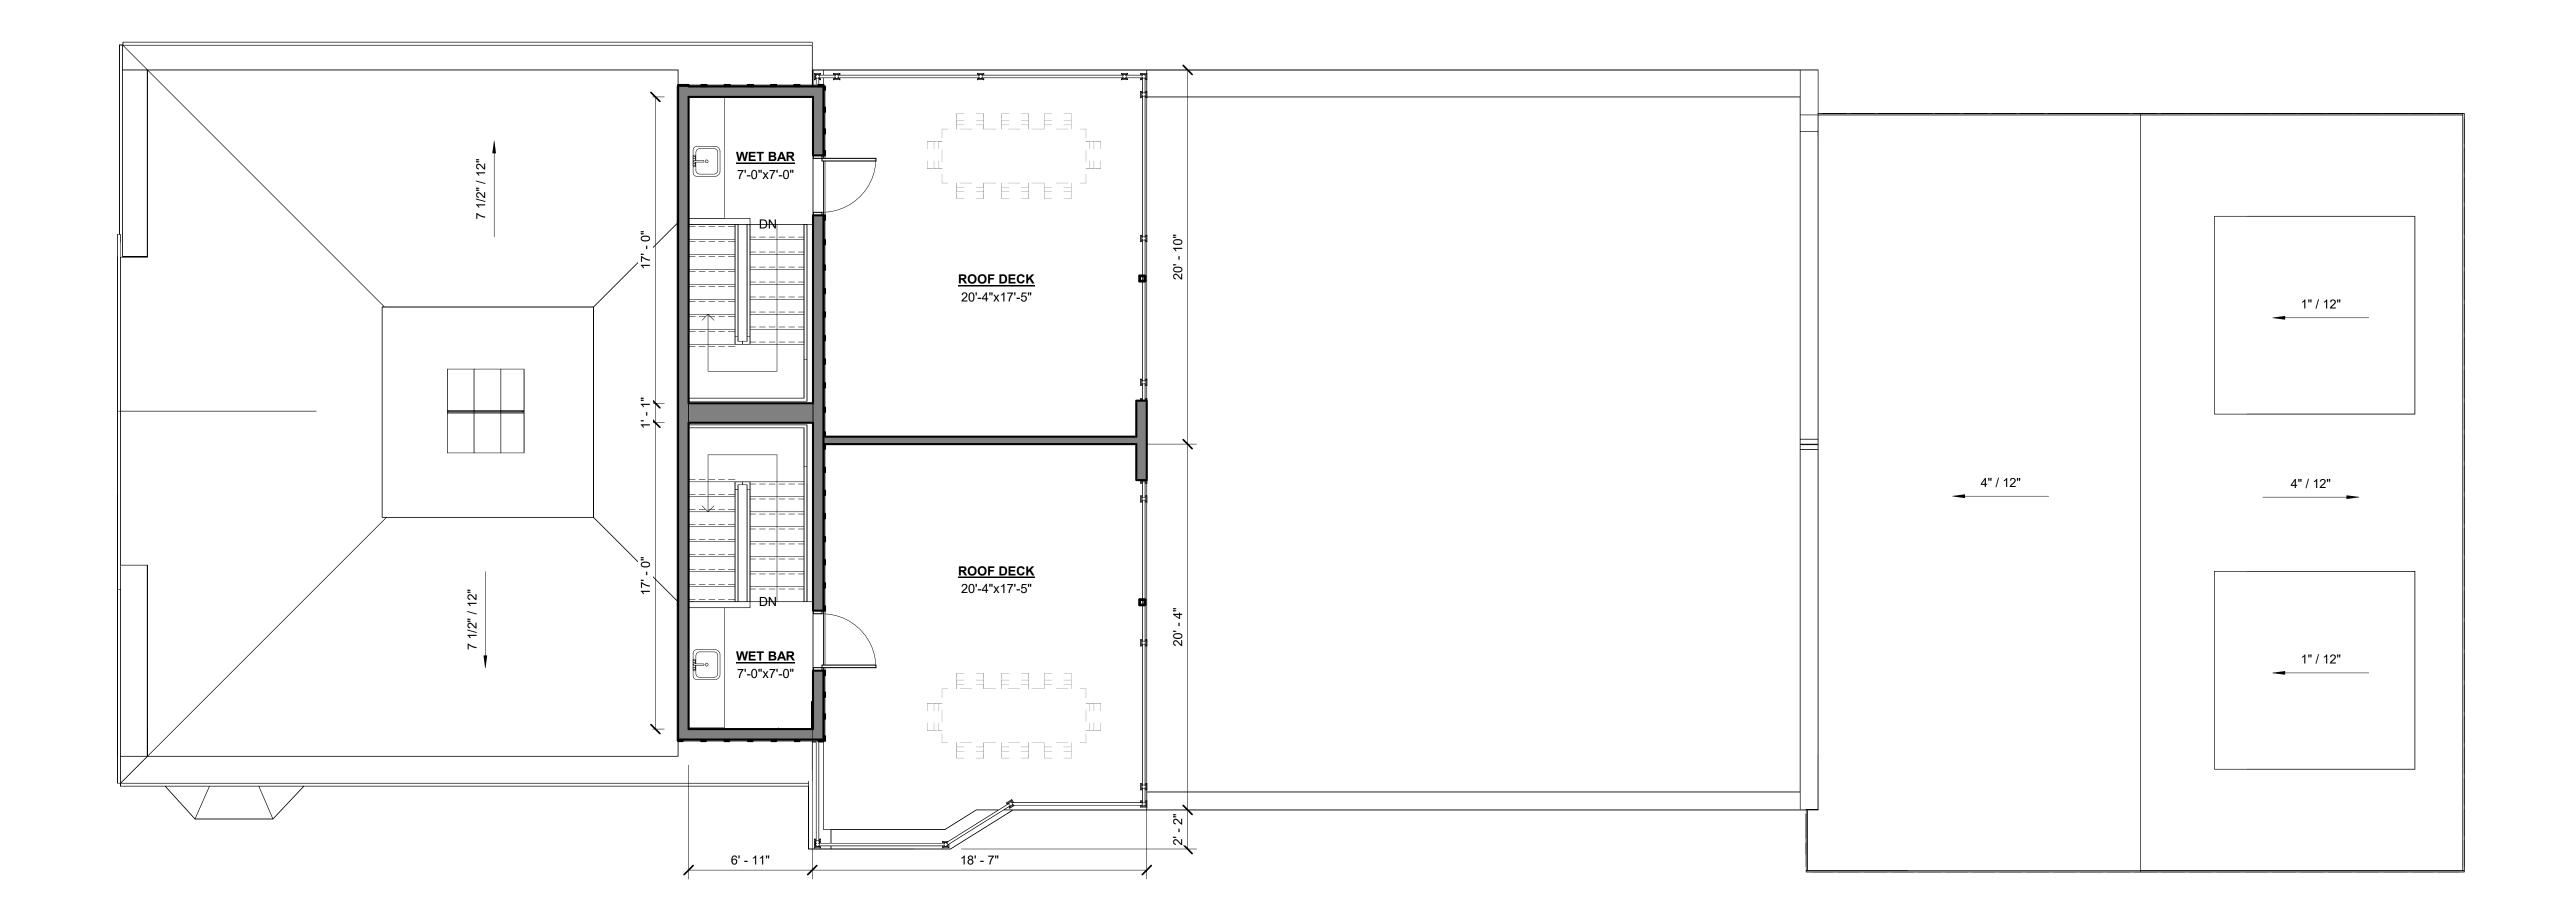

OR CONS

ARCHITECT:

CONSULTANT:

Project:

Issued for :

REVIEW

04/12/2024

MULTI-FAMILY RENOVATION 64 EDMUND PL. DETROIT, MI 48201

2761 E. JEFFERSON SUITE 302

DETROIT, MI 48207

P. 313.450.4545 TIM.FLINTOFF@4545ARCHITECTURE.COM

Drawn by :

Author
Checked by :
Author

Sheet Title :
ROOF PLAN

Project No. : 2022017

Sheet No.:

41.4

ROOF
| SCALE: 3/16" = 1'-0"





**GENERAL ELEVATION/SECTION NOTES:** 

THIS DRAWING IS DIAGRAMMATIC AND SHOULD BE USED TO DETERMINE THE DESIGN INTENT. THE CONTRACTOR IS RESPONSIBLE FOR THE COMPLETE SET OF WORK AS INDICATED AND SHALL FIELD VERIFY ALL WORK, COORDINATE ALL DRAWINGS / NEW WORK AND SHALL NOTIFY ARCHITECT IMMEDIATELY OF ANY DISCREPANCIES IN THE DOCUMENTS BEFORE PROCEEDING. FAILURE TO DO SO WILL RESULT IN THE CONTRACTOR TAKING FULL RESPONSIBILITY AND LIABILITY FOR SAID DISCREPANCIES.

ALL DIMENSIONS ARE SHOWN FROM FINISH FACE TO FINISH FACE OF PARTITION UNLESS OTHERWISE NOTED.

ALL WORK SHALL BE DONE IN ACCORDANCE WITH ALL LOCAL, STATE, COUNTY CODE REGULATIONS, O.S.H.A., AND THE AMERICAN WITH DISABILITIES ACT (ADA). REFER TO THE CODE PLAN FOR MORE

REFER TO SIDING MANUFACTURER INSTALLATION INSTRUCTIONS AND STANDARD DETAILS

CONTRACTOR TO VERIFY/COORDINATE CODE REQUIRED WINDOW EGRESS REQUIREMENTS

**ELEVATION KEY NOTES:** 

(TYPICAL THIS SHEET ONLY)

1 SINGLE-HUNG WINDOW. BASIS OF DESIGN: ANDERSON 100 SERIES, BLACK

2 ROUND COLUMN, 1-'0" DIAM.

WOOD RAILING, MIN. 42" TALL, PAINTED BLACK

WOOD PORCH, WRAPPED, PAINTED BLACK

(5) EXISTING ROOF TO BE REPAIRED AS REQ'D USING IN-KIND MATERIALS

6 DECORATIVE WOOD RAILING, PAINTED BLACK

ROOF ICE AND WATER SHIELD ON 3/4" WOOD SHEATHING ON WOOD ROOF JOISTS

8 WOOD FASCIA, BLACK

9 EXISTING BRICK TO BE REPAIRED AS REQ'D USING IN-KIND MATERIALS

10 DECORATIVE RAFTER TAIL ON 10" FRIEZE BOARD, BLACK

11 JAMES HARDIE BOARD AND BATTEN SIDING WITH 3" COLOR-MATCHED TRIM AT ALL CORNERS AND EDGES. FINAL COLOR TBD.

ALUMINUM RAILING, MIN. 42" TALL BLACK.

BASIS OF DESIGN: TREY SIGNATURE SERIE BASIS OF DESIGN: TREX SIGNATURE SERIES

13 PORCH AND STAIR WITH BRICK CLADDING

14 BRICK, TBD.

(15) STAINED WOOD TRELLIS

16 CASEMENT WINDOW BASIS OF DESIGN: AND BASIS OF DESIGN: ANDERSON 100 SERIES, BLACK

(17) ASPHALT SHINGLE ROOF

7'-0" x 8'-0" OVERHEAD GARAGE DOOR, BLACK

SLIDING GLASS DOOR. BASIS OF DESIGN: ANDERSON 100 SERIES, BLACK

ARCHITECT:

4545 architecture


SUITE 302 DETROIT, MI 48207 P. 313.450.4545 TIM.FLINTOFF@4545ARCHITECTURE.COM

2761 E. JEFFERSON

CONSULTANT:

Project:

**MULTI-FAMILY** RENOVATION 64 EDMUND PL. DETROIT, MI 48201

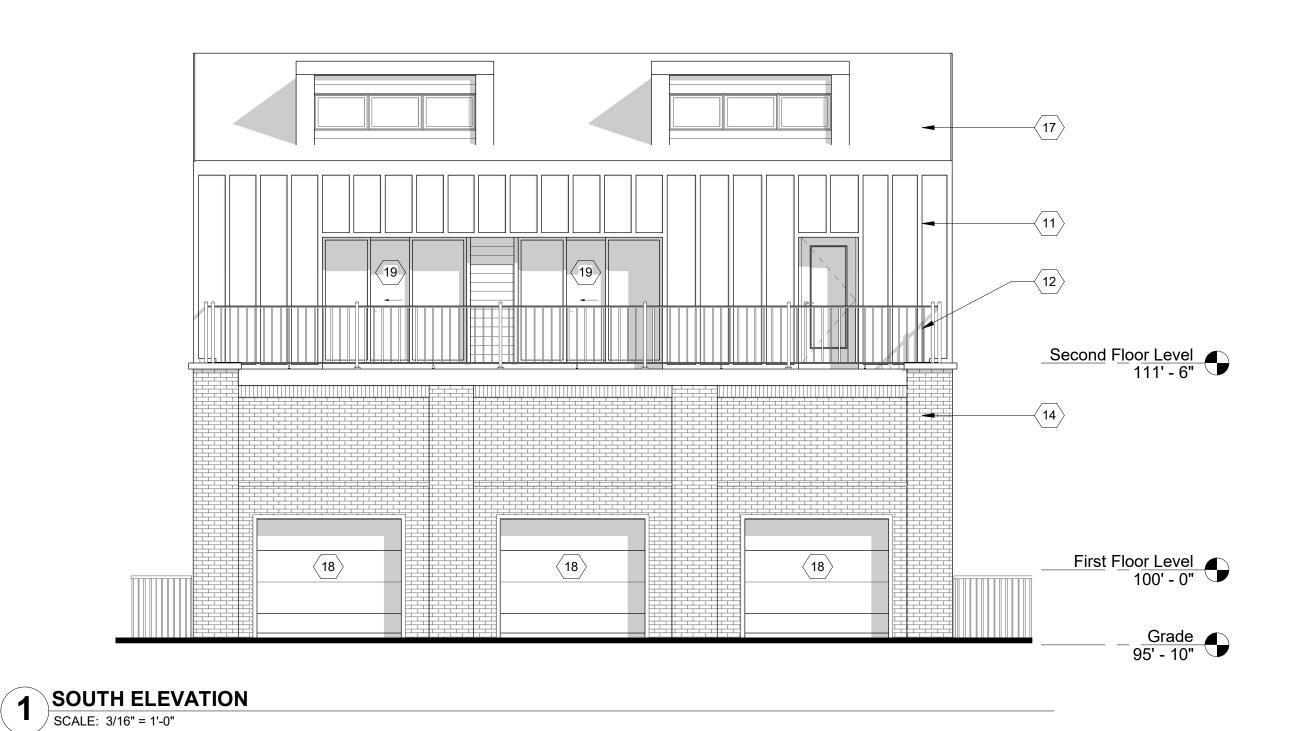

 $\langle 16 \rangle$ 

(17)—

(11)—

(12)-

**GENERAL ELEVATION/SECTION NOTES:** 

THIS DRAWING IS DIAGRAMMATIC AND SHOULD BE USED TO DETERMINE THE DESIGN INTENT. THE CONTRACTOR IS RESPONSIBLE FOR THE COMPLETE SET OF WORK AS INDICATED AND SHALL FIELD THE DOCUMENTS BEFORE PROCEEDING. FAILURE TO DO SO WILL RESULT IN THE CONTRACTOR TAKING FULL RESPONSIBILITY AND LIABILITY FOR SAID DISCREPANCIES.

DISABILITIES ACT (ADA). REFER TO THE CODE PLAN FOR MORE

REFER TO SIDING MANUFACTURER INSTALLATION INSTRUCTIONS AND STANDARD DETAILS

CONTRACTOR TO VERIFY/COORDINATE CODE REQUIRED WINDOW EGRESS REQUIREMENTS

(TYPICAL THIS SHEET ONLY)

1 SINGLE-HUNG WINDOW.

2 ROUND COLUMN, 1-'0" DIAM.

(3) WOOD RAILING, MIN. 42" TALL, PAINTED BLACK

WOOD PORCH, WRAPPED, PAINTED BLACK

5 EXISTING ROOF TO BE REPAIRED AS REQ'D USING IN-KIND MATERIALS

6 DECORATIVE WOOD RAILING, PAINTED BLACK

ROOF ICE AND WATER SHIELD ON 3/4" WOOD

8 WOOD FASCIA, BLACK

10 DECORATIVE RAFTER TAIL ON 10" FRIEZE BOARD, BLACK

BASIS OF DESIGN: TREX SIGNATURE SERIES

16 CASEMENT WINDOW BASIS OF DESIGN: AND BASIS OF DESIGN: ANDERSON 100 SERIES, BLACK

 $\langle 17 \rangle$  ASPHALT SHINGLE ROOF

7'-0" x 8'-0" OVERHEAD GARAGE DOOR, BLACK

Issued for : REVIEW 04/12/2024 Roof Level 132' - 3" Second Floor Level 111' - 6" Drawn by : Author Checked by: Author Sheet Title: First Floor Level **EXTERIOR ELEVATIONS** <u>Grade</u> 95' - 10" Project No. :

ARCHITECT:

4545 architecture

TIM.FLINTOFF@4545ARCHITECTURE.COM

2761 E. JEFFERSON SUITE 302

DETROIT, MI 48207

P. 313.450.4545

Project:

**MULTI-FAMILY** 

RENOVATION

64 EDMUND PL.

DETROIT, MI 48201

CONSULTANT:

2 EAST ELEVATION
SCALE: 3/16" = 1'-0"

VERIFY ALL WORK, COORDINATE ALL DRAWINGS / NEW WORK AND SHALL NOTIFY ARCHITECT IMMEDIATELY OF ANY DISCREPANCIES IN ALL DIMENSIONS ARE SHOWN FROM FINISH FACE TO FINISH FACE OF PARTITION UNLESS OTHERWISE NOTED. ALL WORK SHALL BE DONE IN ACCORDANCE WITH ALL LOCAL, STATE, COUNTY CODE REGULATIONS, O.S.H.A., AND THE AMERICAN WITH

**ELEVATION KEY NOTES:** 

BASIS OF DESIGN: ANDERSON 100 SERIES, BLACK

SHEATHING ON WOOD ROOF JOISTS

9 EXISTING BRICK TO BE REPAIRED AS REQ'D USING IN-KIND MATERIALS

11 JAMES HARDIE BOARD AND BATTEN SIDING WITH 3" COLOR-MATCHED TRIM AT ALL CORNERS AND EDGES. FINAL COLOR TBD.

ALUMINUM RAILING, MIN. 42" TALL BLACK.

13 PORCH AND STAIR WITH BRICK CLADDING

BRICK, TBD.

(15) STAINED WOOD TRELLIS

SLIDING GLASS DOOR. BASIS OF DESIGN: ANDERSON 100 SERIES, BLACK

Sheet No.: