DHDC 23-8393

APPROVAL DOCUMENT - POST AT WORK LOCATION

CITY OF DETROIT HISTORIC DISTRICT COMMISSION 2 WOODWARD, SUITE 808 DETROIT, MICHIGAN 48226

07/24/2024

NOTICE TO PROCEED

Robert J. Kraemer, Principal Kraemer Design Group 1420 Broadway Detroit, MI 48226

RE: Application Number 23-8393; 1322, 1326, 1332-1336 Broadway; Broadway Avenue Local Historic District

Project Scope: Demolish building at 1332-1336 Broadway, partial demolition at rear and rehabilitation of historic front facades at 1322 & 1326 Broadway, erect new multi-family building

Dear Applicant,


At the Regular Meeting that was held on June 14, 2023, the Detroit Historic District Commission ("DHDC") reviewed the above-referenced application. Pursuant to Section 5(1)/5(6) of the Michigan Local Historic District Act, as amended, being MCL 399.205 (1) and (6), and Sections 21-2-73, 75 and 78 of the 2019 Detroit City Code; and subsequent to staff's certification of the satisfaction of conditions stated therein and by the DHDC, the DHDC hereby issues a Notice to Proceed ("NTP") for the following work, with an effective date of July 24, 2024, as the work does not meet the Secretary of the Interior's Standards for Rehabilitation and the district's Elements of Design, but is without substantial detriment to the public welfare and without substantial derogation from the intents and purposes of Article II, Chapter 21, and where one or more of the conditions of Section 21-2-75 have been met:


Per the attached drawings and documents, demolish building at 1332-1336 Broadway, partial demolition at rear and rehabilitation of historic front facades at 1322 & 1326 Broadway, erect new multi-family building.

Please retain this NTP for your files and post it at the subject property until work is complete. It is important to note that approval by the DHDC does not waive the applicant's responsibility to comply with any other applicable ordinances or statutes. If you have any questions regarding the foregoing, please contact staff at 313-224-1762 or hdc@detroitmi.gov.

For the Commission:

Garrick Landsberg, Director

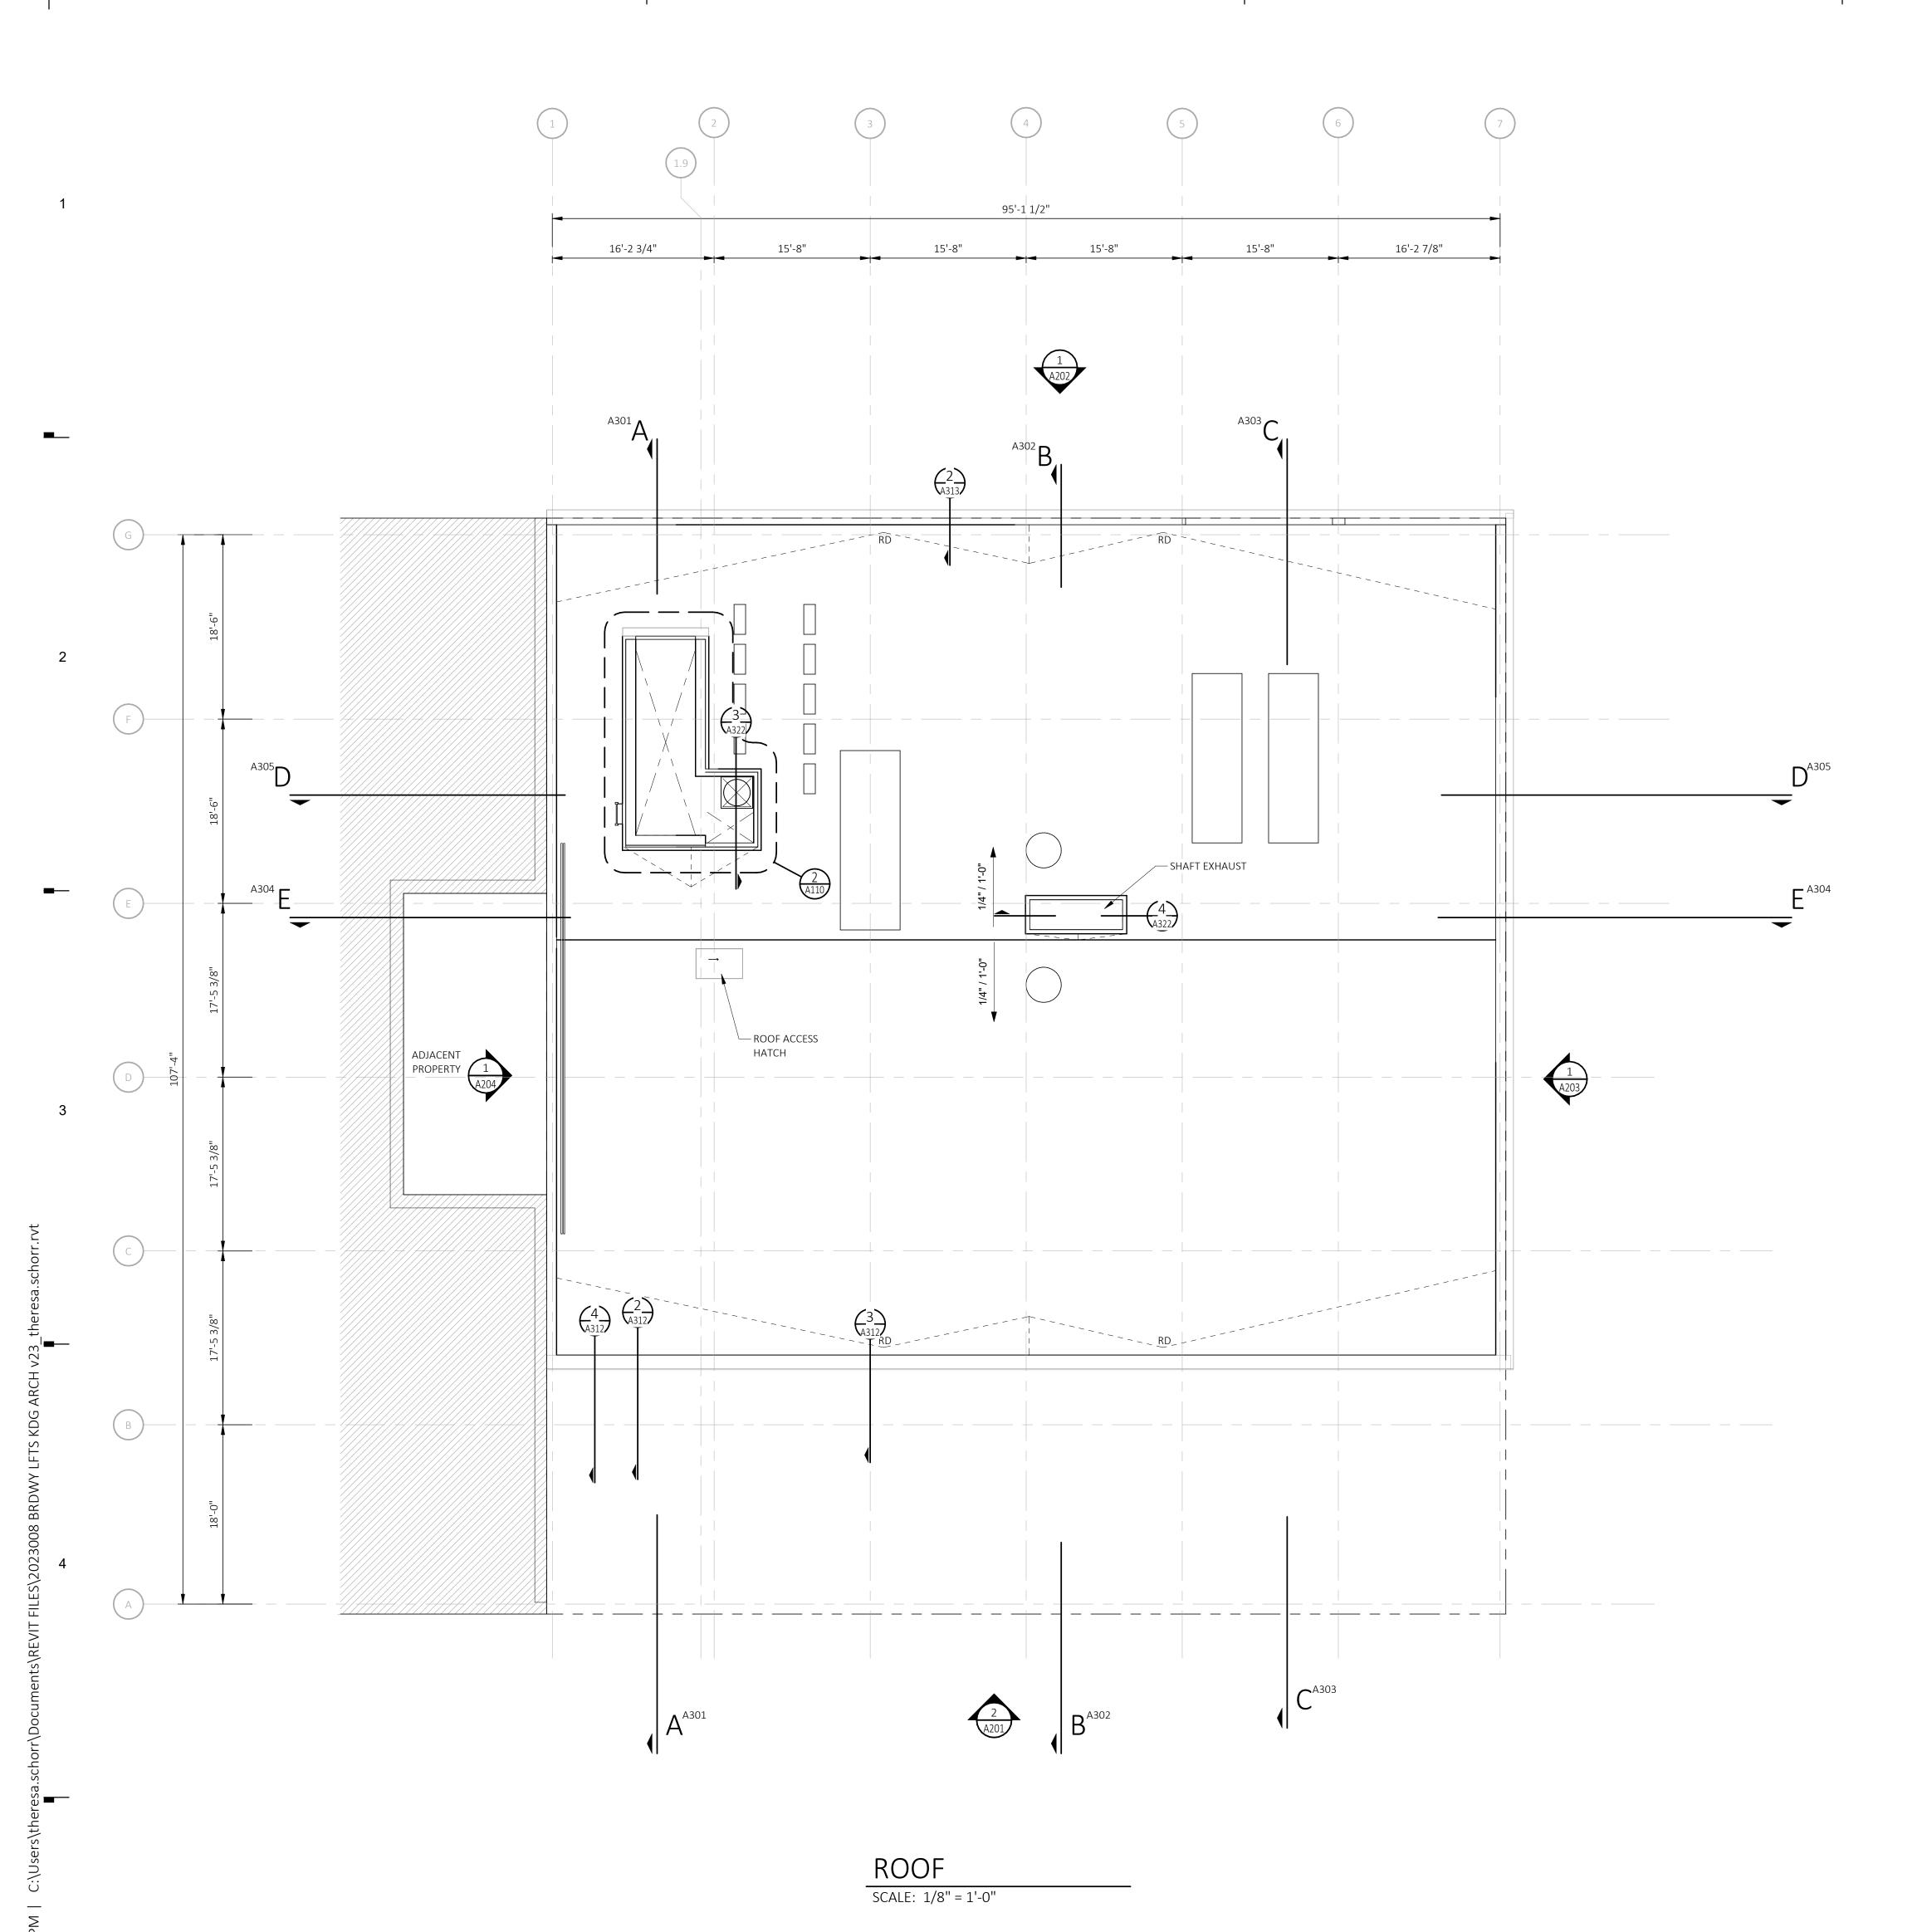

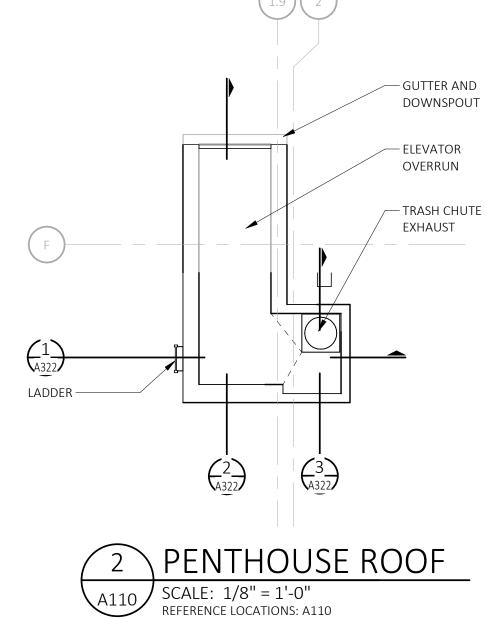

ROOFING GENERAL NOTES

- A CONTRACTOR SHALL REVIEW AND COORDINATE WITH ARCHITECTURAL, MEP, AND STRUCTURAL PLANS TO ASCERTAIN EXACT CONDITIONS AND COMPONENTS RELATED TO THE WORK DESCRIBED BY THESE DOCUMENTS. ALL WORK SHALL BE IN ACCORDANCE WITH ACCEPTED MANUFACTURER'S PRINTED INSTRUCTIONS AND NRCA STANDARDS.
- B DIMENSIONS, DETAILS, EQUIPMENT SIZE AND LOCATION SHOWN ON THESE ROOF PLAN AND ROOF DETAILS ARE FOR INFORMATION AND REFERENCE ONLY. EXACT SIZE, LOCATION, TYPE OF MATERIAL AND TYPE OF CONSTRUCTION ARE THE RESPONSIBILITY OF THE CONTRACTOR TO CONFIRM AND COORDINATE.
- C REFER TO NOMENCLATURE FOR TYPE OF ROOF SYSTEM. AREAS ARE MARKED WITH DESIGNATED LETTER, SEE ROOF PLAN AND NOMENCLATURE.
- D MINIMUM SLOPE ALLOWABLE ON THE ROOF SHALL BE NO LESS THAN 1/4" PER FOOT. CRICKET THE UP-SLOPE SIDE OF ALL SQUARE CURBS AND PROJECTIONS OVER 20" IN WIDTH.
- E CONTRACTOR TO ENSURE RUNOFF PITCHES AWAY FROM ROOF EXPANSION JOINTS AND ROOF AREA SEAMS. ELEVATE ROOF EXPANSION JOINTS A MINIMUM OF 8" ABOVE THE ROOF MEMBRANE.
- F ALL CRICKET AND TAPERED INSULATION SHALL BE INSTALLED WITH A FINISH 1/4" PER FOOT MIN. SLOPE. CRICKET THE UP-SLOPE SIDE OF ALL SQUARE CURBS AND PROJECTIONS.
 G ALL PIPING, CONDUITS, ETC. SHALL BE A MIN. 10" ABOVE ROOF SURFACE. PROVIDE PORTABLE PIPE HANGERS WITH PROTECTION PADS.
- H PROVIDE 22 GAUGE STAINLESS STEEL, 2D FINISH, TREATED WOOD CURB AND BOX HOOD AT ALL GAS LINE AND WATER LINE ROOF PENETRATIONS. SEE A321 FOR TYPICAL ROOF DETAILS.
 I ISOLATE ALL HEAT PIPES/FLUES AS RECOMMENDED & OUTLINED IN THE NRCA MANUAL FOR ISOLATED STACK FLASHING. REFER TO MEP DRAWINGS FOR SIZE AND LOCATION OF DECK
- J PROVIDE WALKWAY PROTECTION PADS AROUND ALL ROOF HATCHES, MECHANICAL UNITS, AT ROOF TOP ACCESS DOORS, AND LADDERS (TOP & BOTTOM).
- K CONTRACTOR SHALL REFER TO A321 FOR TYPICAL ROOF DETAILS IN ADDITION TO DETAILS SPECIFICALLY NOTED ON PLANS

PENETRATIONS AND ROOFTOP EQUIPMENT.

- SPECIFICALLY NOTED ON PLANS.

 L CONTRACTOR TO ENSURE ALL ROOFTOP PENETRATIONS (EQUIPMENT, SOIL STACKS, ETC.) ARE
- INSTALLED MIN. 2'-0" FROM OTHER DECK PENETRATIONS, RISE WALLS, AND ROOF EDGE.

 M THROUGH WALL BASE FLASHING MIN. HEIGHT 10" AND MAX. HEIGHT 20" FROM FINISH DECK. DO
 NOT STEP THROUGH WALL FLASHING CLOSER THAN 5'-0" FROM CORNERS.

N LOCATE PERIMETER DRAINS MAX. 6'-0" FROM EDGE TYPICAL UNLESS SHOWN OTHERWISE.

- O CONTRACTOR SHALL EXAMINE AND ENSURE DRAIN LINES, GUTTERS AND DOWNSPOUTS ARE FREE OF DEBRIS AND BLOCKAGE, FLUSH WITH WATER TO ENSURE THAT DRAINS FLOW FREELY, WHERE APPLICABLE.
- P OVERFLOW DRAINS SHALL BE SET 2" HIGHER THAN MAIN ROOF DRAIN ELEVATIONS UNLESS NOTED OTHERWISE. OVERFLOW DRAINS SHALL NOT HAVE STRAINERS UNLESS REQUIRED BY
- Q AVOID THE USE OF PITCH PANS ON LOW-PITCH ROOFS EXCEPT WHERE NO OTHER SOLUTION CAN BE USED.
- R SECURE NAILERS AND CANT STRIPS TO ROOF DECK, NOT TO PARAPETS OR ADJACENT WALLS,
- S CONTRACTOR SHALL PROVIDE ALL EQUIPMENT CURBS AND STANDS NECESSARY FOR ROOFTOP EQUIPMENT.

Standard | Charleston, SC adway | Detroit MI 48226 | p313 965 3399 www.thekraemeredge.com

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Consultant



Owner

BROADWAY LOFTS
1326-1336 BROADWAY ST
DETROIT MI

Project



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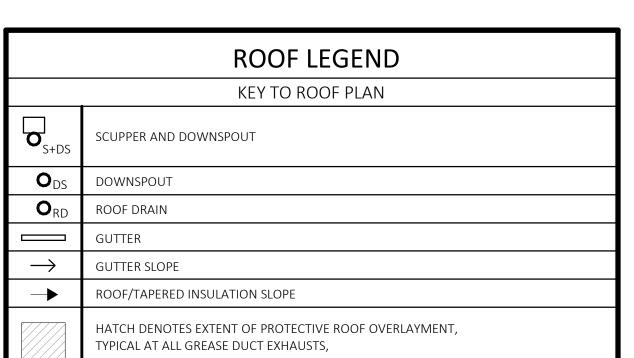
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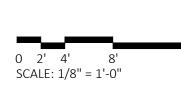
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Sheet Title
ROOF PLAN

Sheet Number

A110








REFER TO SPECIFICATIONS.

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SHEET METAL GENERAL NOTES:

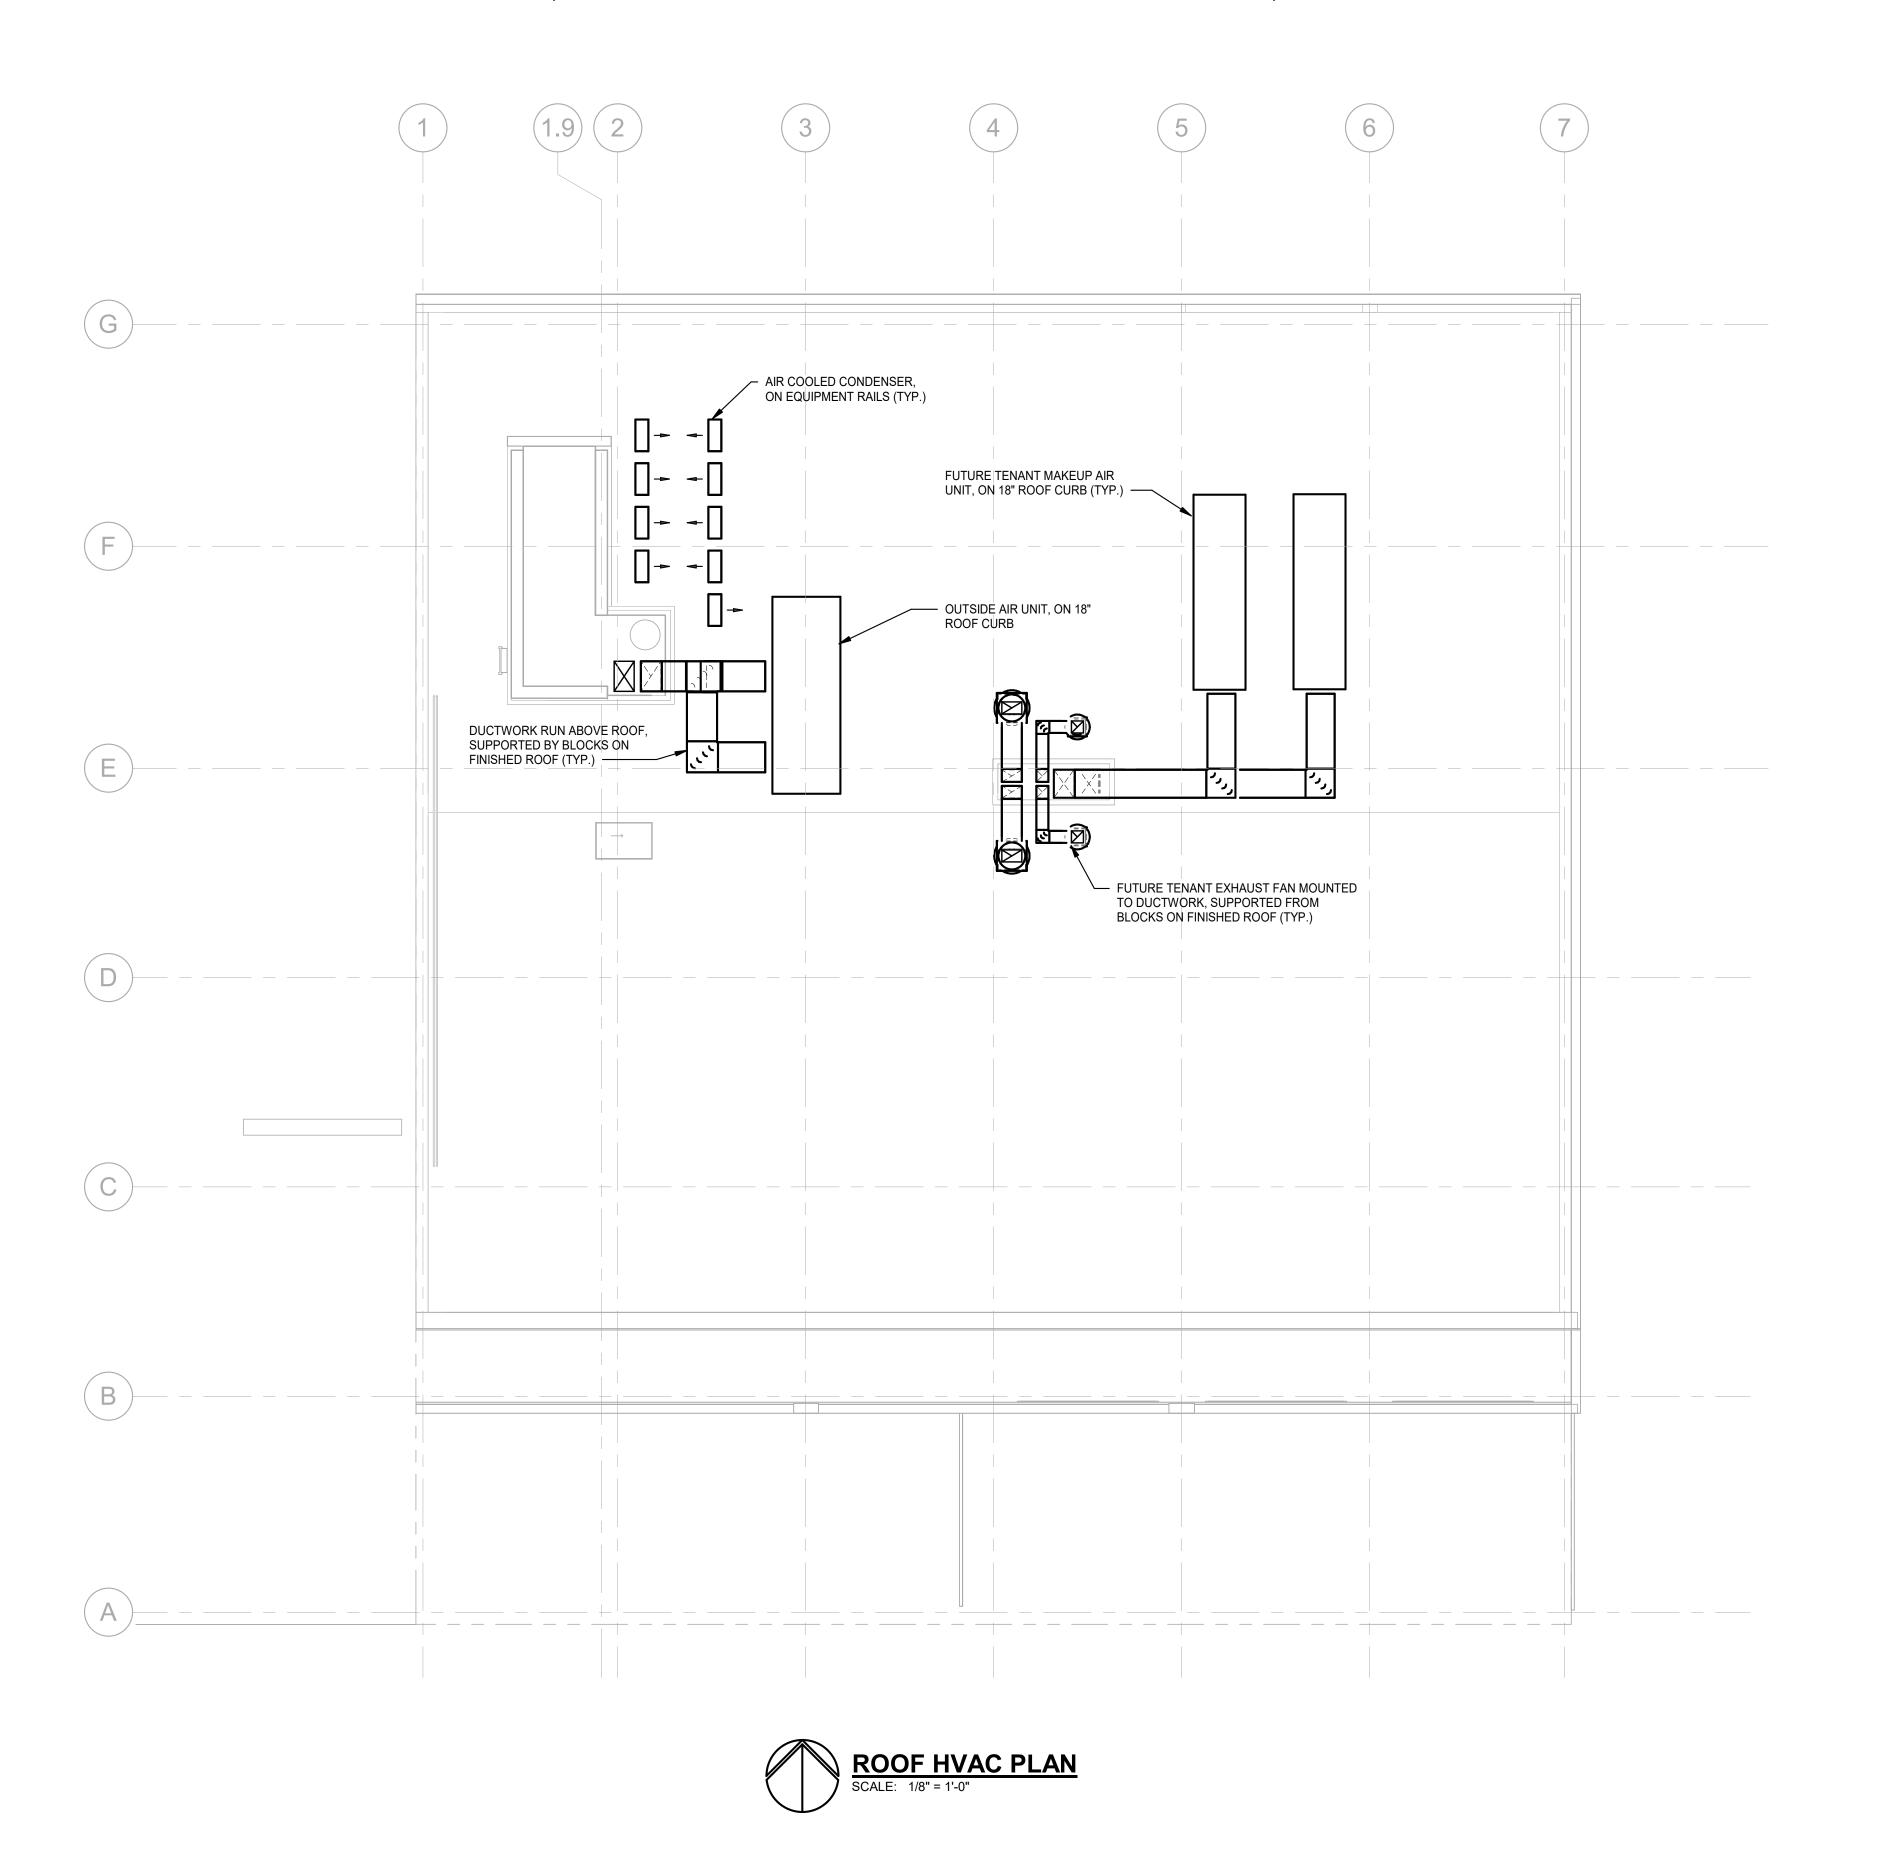- THESE DRAWINGS ARE DIAGRAMMATIC, AND REPRESENT THE GENERAL INTENT AND ARRANGEMENT OF SYSTEMS. THEY ARE NOT TO BE CONSIDERED FABRICATION/COORDINATION/SHOP DRAWINGS. COORDINATION WITH OTHER TRADES IS REQUIRED. PROVIDE THE ADDITIONAL FITTINGS AND OFFSETS THAT WILL BE REQUIRED TO COMPLETE EACH SYSTEM AND TO AVOID INTERFERENCES WITH ALL OTHER SYSTEMS INCLUDING THE STRUCTURE, PIPING SYSTEMS, ELECTRICAL CONDUITS, BUS DUCTS, CABLE TRAY, LIGHT FIXTURES, ETC. AND/OR OTHER SPACE CONSTRAINTS.
- 2 INSTALL SYSTEMS SUCH THAT REQUIRED CLEARANCE AND SERVICE ACCESS SPACE IS PROVIDED AROUND ALL MECHANICAL AND ELECTRICAL EQUIPMENT, AND AROUND ANY COMPONENTS WHICH REQUIRE SERVICE ACCESS.
- 3 PIPING AND DUCTWORK SHALL NOT BE INSTALLED ABOVE ELECTRICAL TRANSFORMERS, SWITCHBOARDS, PANELBOARDS OR MOTOR CONTROL CENTERS.
- 4 COORDINATE AND PROVIDE ACCESS DOORS WITHIN INACCESSIBLE CEILING, SHAFT, AND CHASE AREAS FOR ALL COMPONENTS WHICH REQUIRE SERVICE ACCESS. REFER TO ARCHITECTURAL DRAWINGS FOR CEILING TYPES.
- 5 PROVIDE SUPPLEMENTARY STEEL AS REQUIRED FOR THE PROPER SUPPORT OF ALL SYSTEMS.
- 6 REFER TO ARCHITECTURAL REFLECTED CEILING PLANS FOR DIMENSIONED LOCATION OF GRILLES, REGISTERS, AND DIFFUSERS.
- 7 REFER TO TEMPERATURE CONTROLS STANDARD MOUNTING HEIGHTS DETAIL FOR ELEVATIONS OF WALL MOUNTED TEMPERATURE CONTROL DEVICES.

CONSTRUCTION KEY NOTES:



Architect



Consultant



Owner

BROADWAY LOFTS
1326-1336 BROADWAY ST

Proje



Seal

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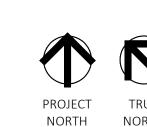
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vision Date

Date MONTH XX, 2021

Project Number Project Number

Sheet Title
ROOF HVAC PLAN





GENERAL NOTES

BRK-2 EXISTING BRICK

MTL-1B FLAT, FINISH: CLASSIC BRONZE

MTL-2A CORRUGATED, FINISH: CHAMPAGNE

MTL-2B CORRUGATED, FINISH: MEDIUM BRONZE

MTL-3A CORRUGATED PERFORATED, FINISH: CHAMPAGNE

MTL-1A FLAT, FINISH: CHAMPAGNE

MTL-3B CORRUGATED PERFORATED, FINISH: MEDIUM BRONZE

MTL-4A TRIM, FINISH: CHAMPAGNE MTL-4B TRIM, FINISH: CLASSIC BRONZE

EXTERIOR ELEVATION MATERIAL LEGEND BRK-1 BRICK TECH, FINISH: OBSIDIAN VELOUR

STN-1 HISTORIC STONE PANELS

TRC-1 EXISTING TERRA COTTA


STN-2 LIMESTONE

B REFER TO REFLECTED CEILING PLANS FOR EXTERIOR SOFFIT INFORMATION.

C REFER TO ROOF PLAN FOR PARAPET AND OVERHANG INFORMATION. BRK-3 BELDEN BRICK, FINISH: GRAPHITE BLACK VELOUR

D SEE ELECTRICAL DRAWINGS FOR ADDITIONAL LIGHTING REQUIREMENTS AND FIXTURE TYPES. E SEE ELEVATIONS AND STRUCTURAL DRAWINGS FOR LOCATIONS OF EXPANSION AND CONTROL JOINTS. CONTRACTOR SHALL PROVIDE ADDITIONAL INTERIOR CONTROL JOINTS AS REQUIRED TO COMPLY WITH MAXIMUM SPACING REQUIREMENTS IN SPECIFICATIONS AND NATIONAL MASONRY INSTITUTE. PROVIDE CONTROL JOINTS AT ALL MASONRY REENTRANT CORNERS. F PROVIDE BACKING AND/OR STRUCTURAL SUPPORT AS REQUIRED FOR SIGNAGE AND LIGHTING. G EXPOSED STRUCTURAL STEEL SHALL BE GALVANIZED AND PAINTED UNLESS NOTED OTHERWISE.

H APPLY SEALANT WHENEVER DISSIMILAR MATERIALS MEET.

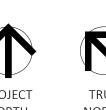






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OWNER REVIEW 50% DESIGN DVLPMNT 03-31-23

Revision PERMIT DATE

Project Number Sheet Title

EXTERIOR ELEVATIONS

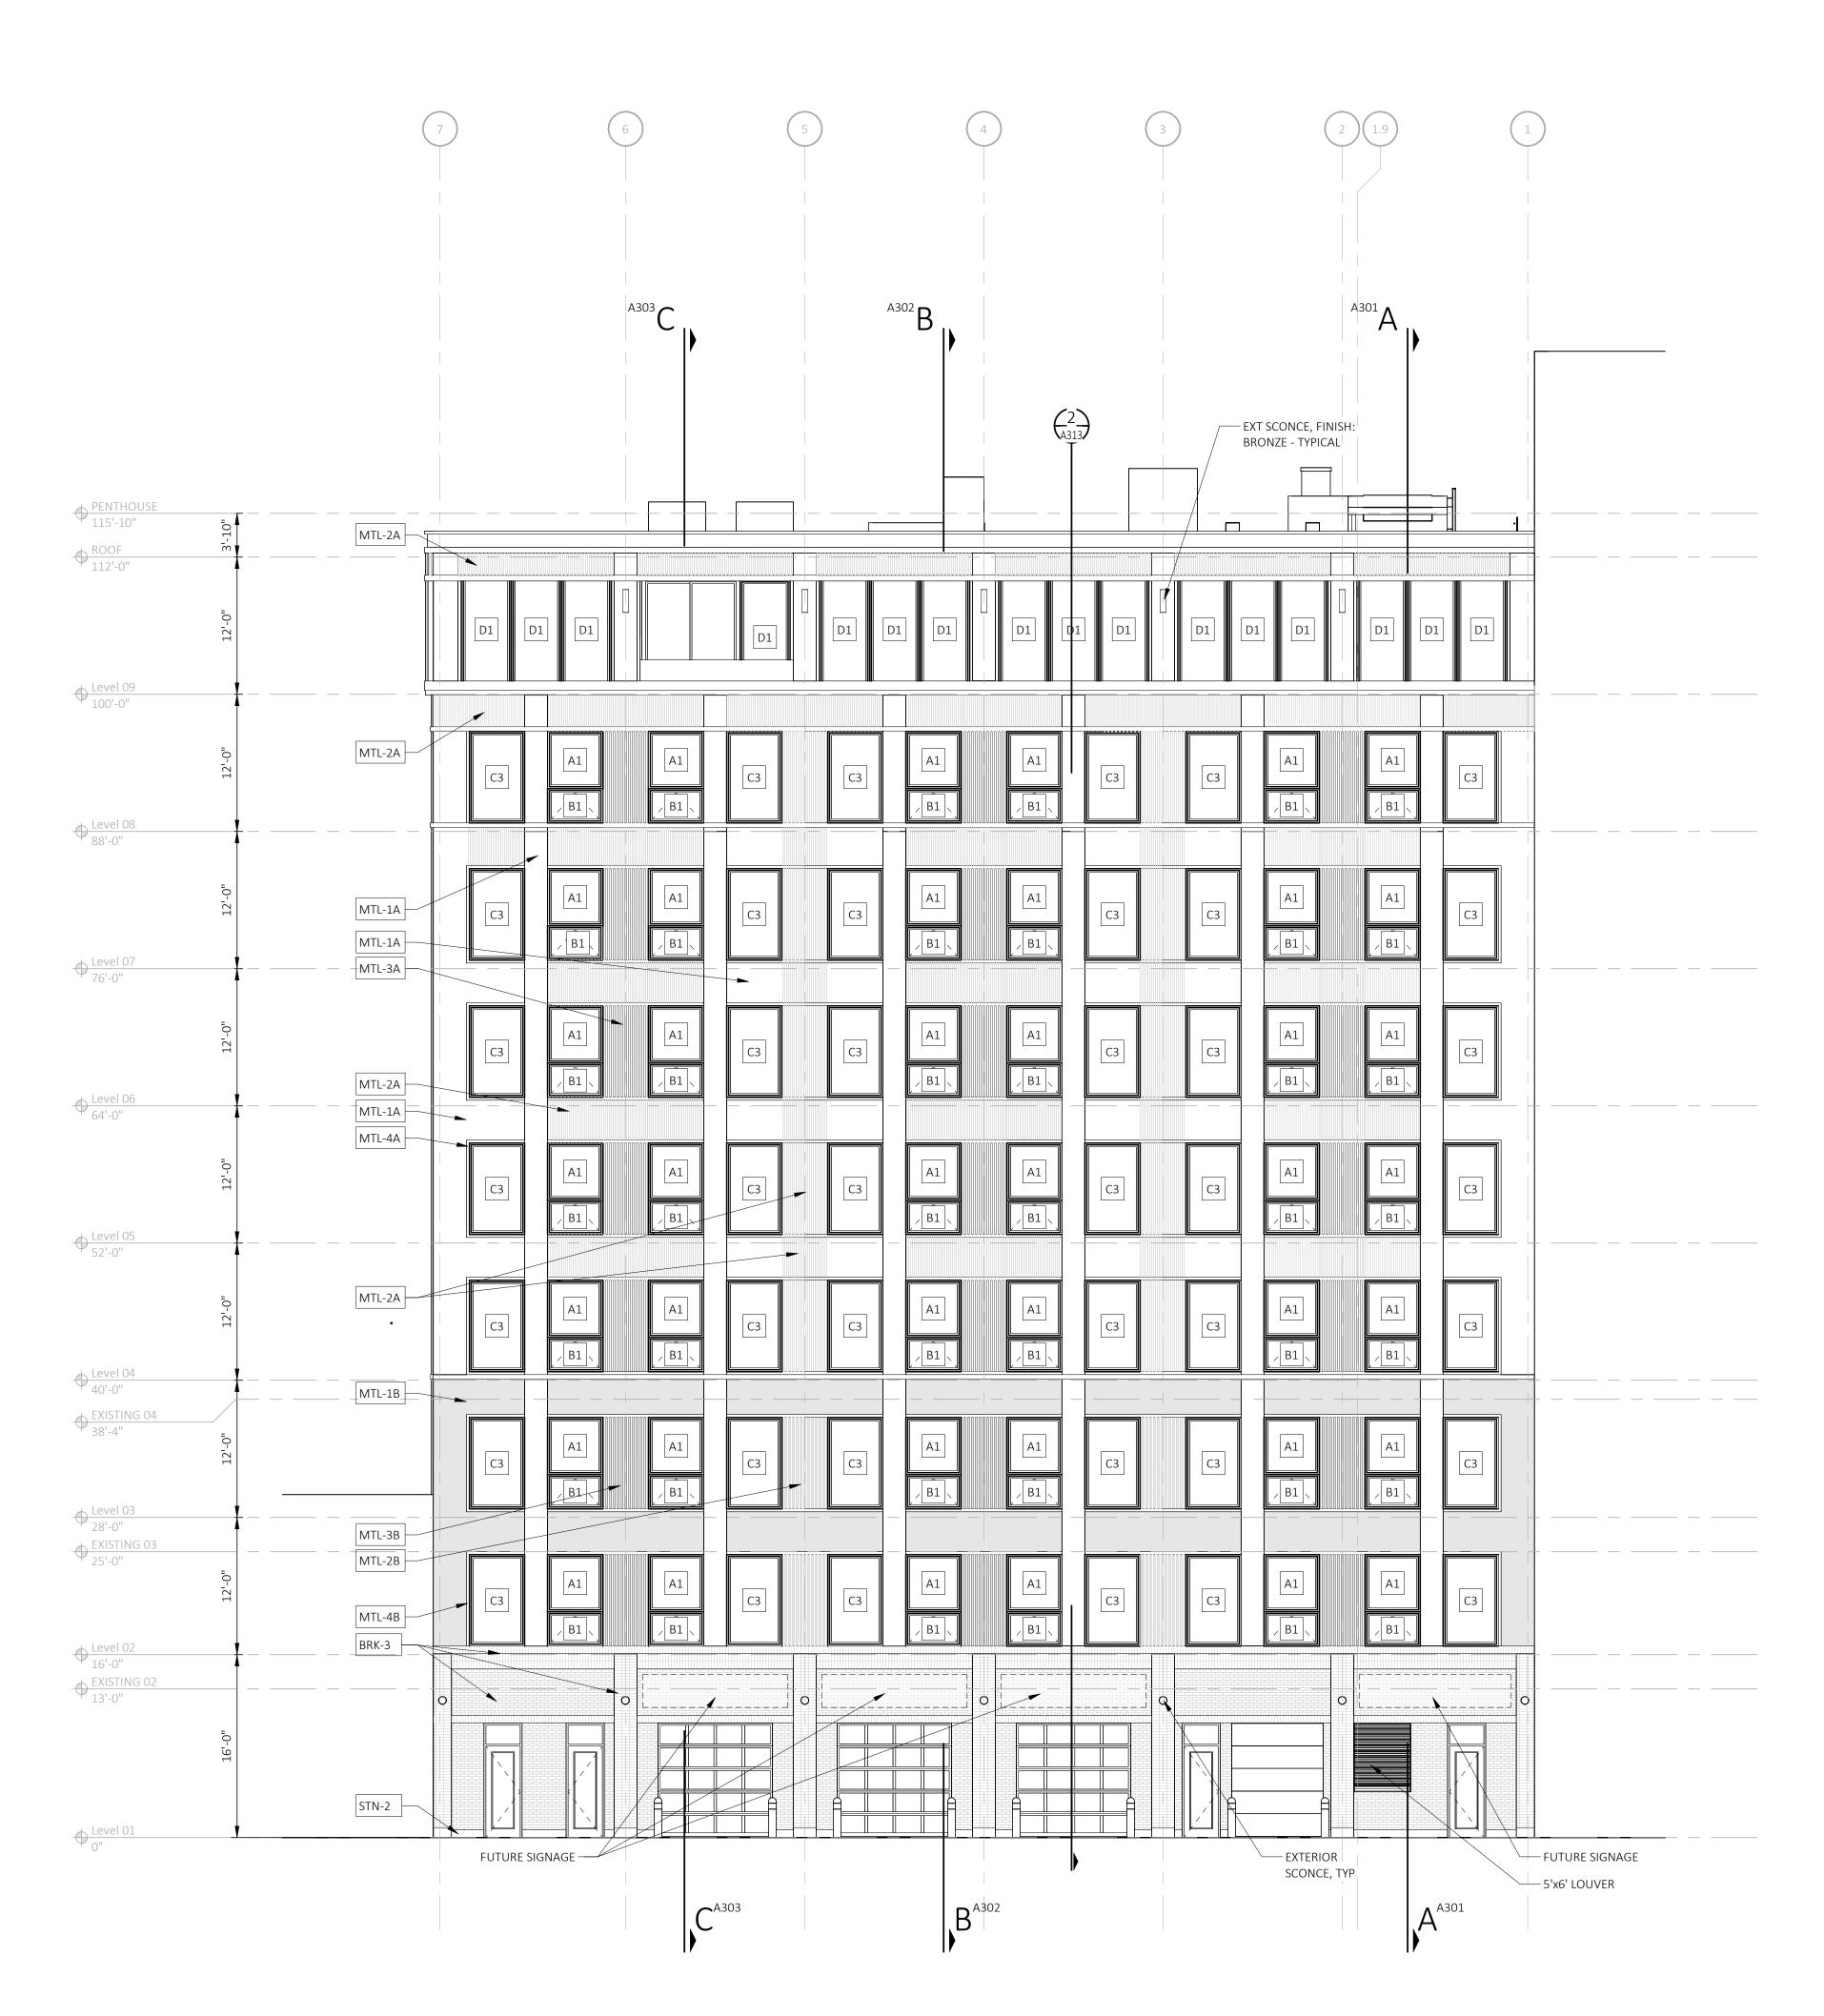

1 EL-NORTH ELEVATION

SCALE: 1/8" = 1'-0"
REFERENCE LOCATIONS: A101

GENERAL NOTES

- A REFER TO A600 SERIES FOR WINDOW AND DOOR SCHEDULE AND DETAILS.
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OWNER REVIEW

Sheet Title **EXTERIOR ELEVATIONS**

Sheet Number

EXTERIOR ELEVATION MATERIAL LEGEND

BRK-1 BRICK TECH, FINISH: OBSIDIAN VELOUR

BRK-2 EXISTING BRICK

STN-2 LIMESTONE

STN-1 HISTORIC STONE PANELS

TRC-1 EXISTING TERRA COTTA

- MTL-1A FLAT, FINISH: CHAMPAGNE
- MTL-1B FLAT, FINISH: CLASSIC BRONZE
- MTL-2A CORRUGATED, FINISH: CHAMPAGNE
- MTL-2B CORRUGATED, FINISH: MEDIUM BRONZE
- MTL-3A CORRUGATED PERFORATED, FINISH: CHAMPAGNE
- MTL-3B CORRUGATED PERFORATED, FINISH: MEDIUM BRONZE
- MTL-4A TRIM, FINISH: CHAMPAGNE
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BRK-3 BELDEN BRICK, FINISH: GRAPHITE BLACK VELOUR


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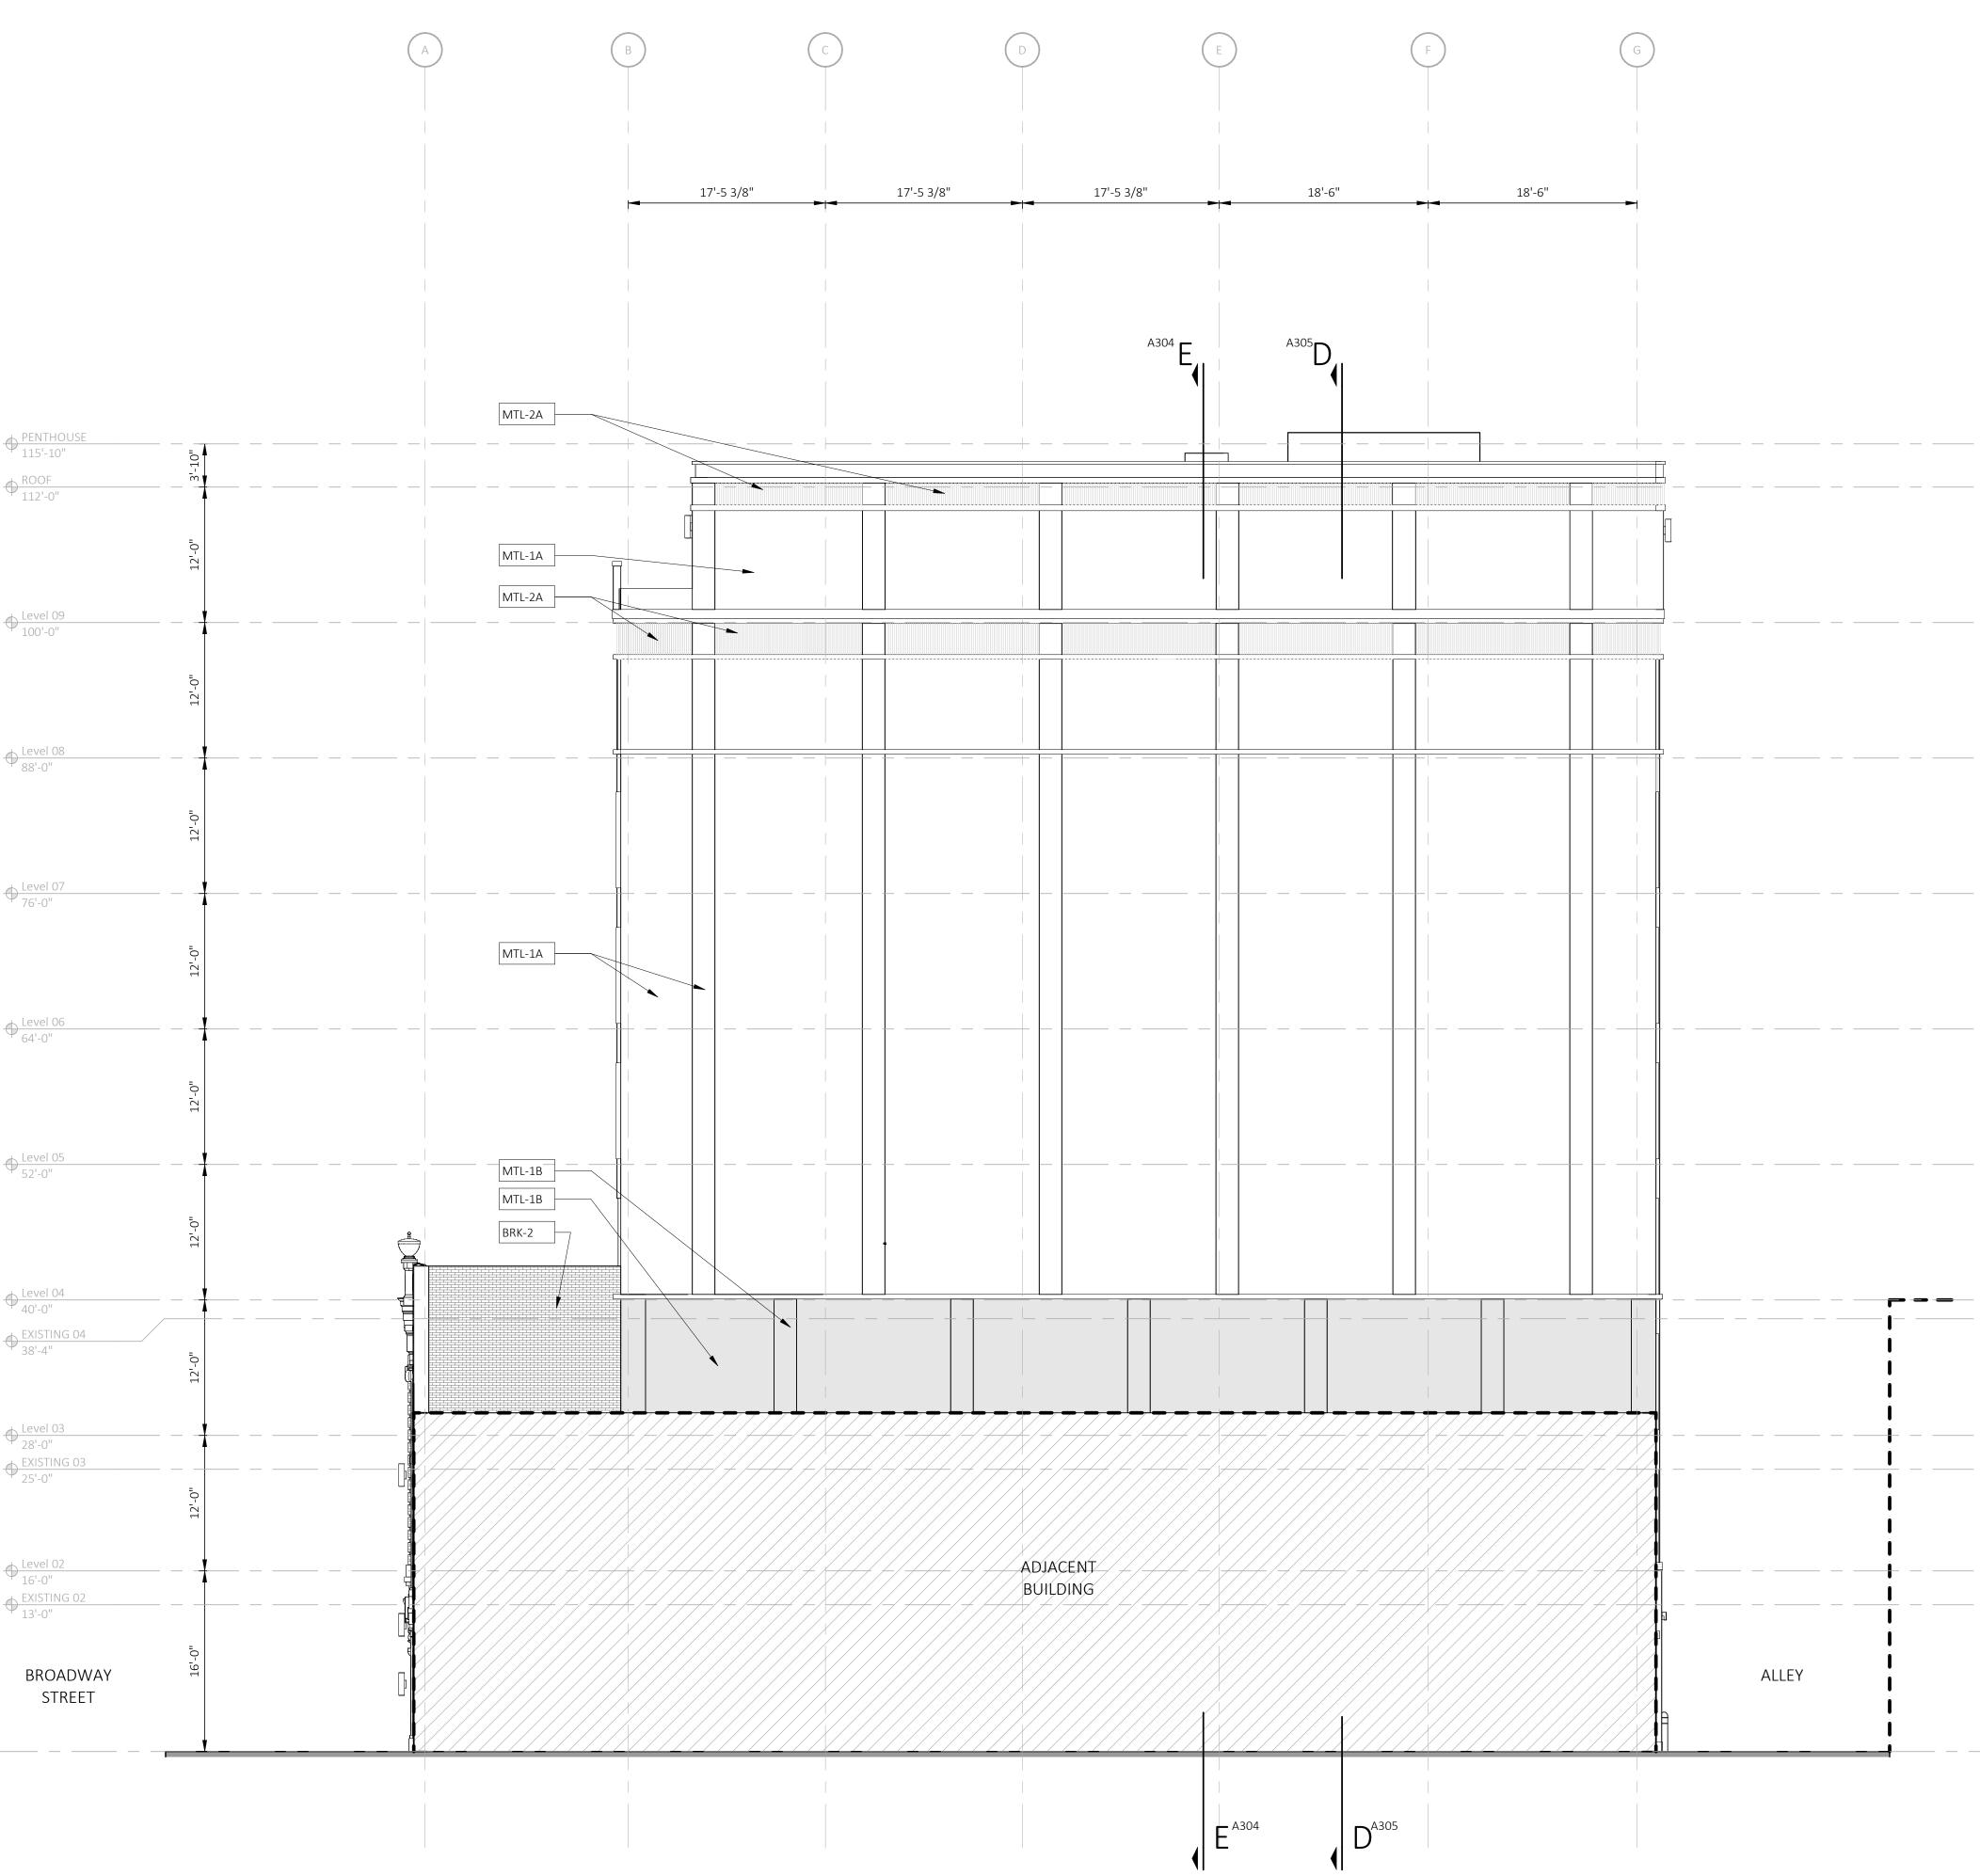
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1 EL-EAST ELEVATION A203 SCALE: 1/8" = 1'-0"
REFERENCE LOCATIONS: A101

EXTERIOR ELEVATION MATERIAL LEGEND

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MTL-3B CORRUGATED PERFORATED, FINISH: MEDIUM BRONZE

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STN-1 HISTORIC STONE PANELS


TRC-1 EXISTING TERRA COTTA

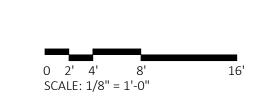STN-2 LIMESTONE

BRK-1 BRICK TECH, FINISH: OBSIDIAN VELOUR B REFER TO REFLECTED CEILING PLANS FOR EXTERIOR SOFFIT INFORMATION. BRK-2 EXISTING BRICK

GENERAL NOTES

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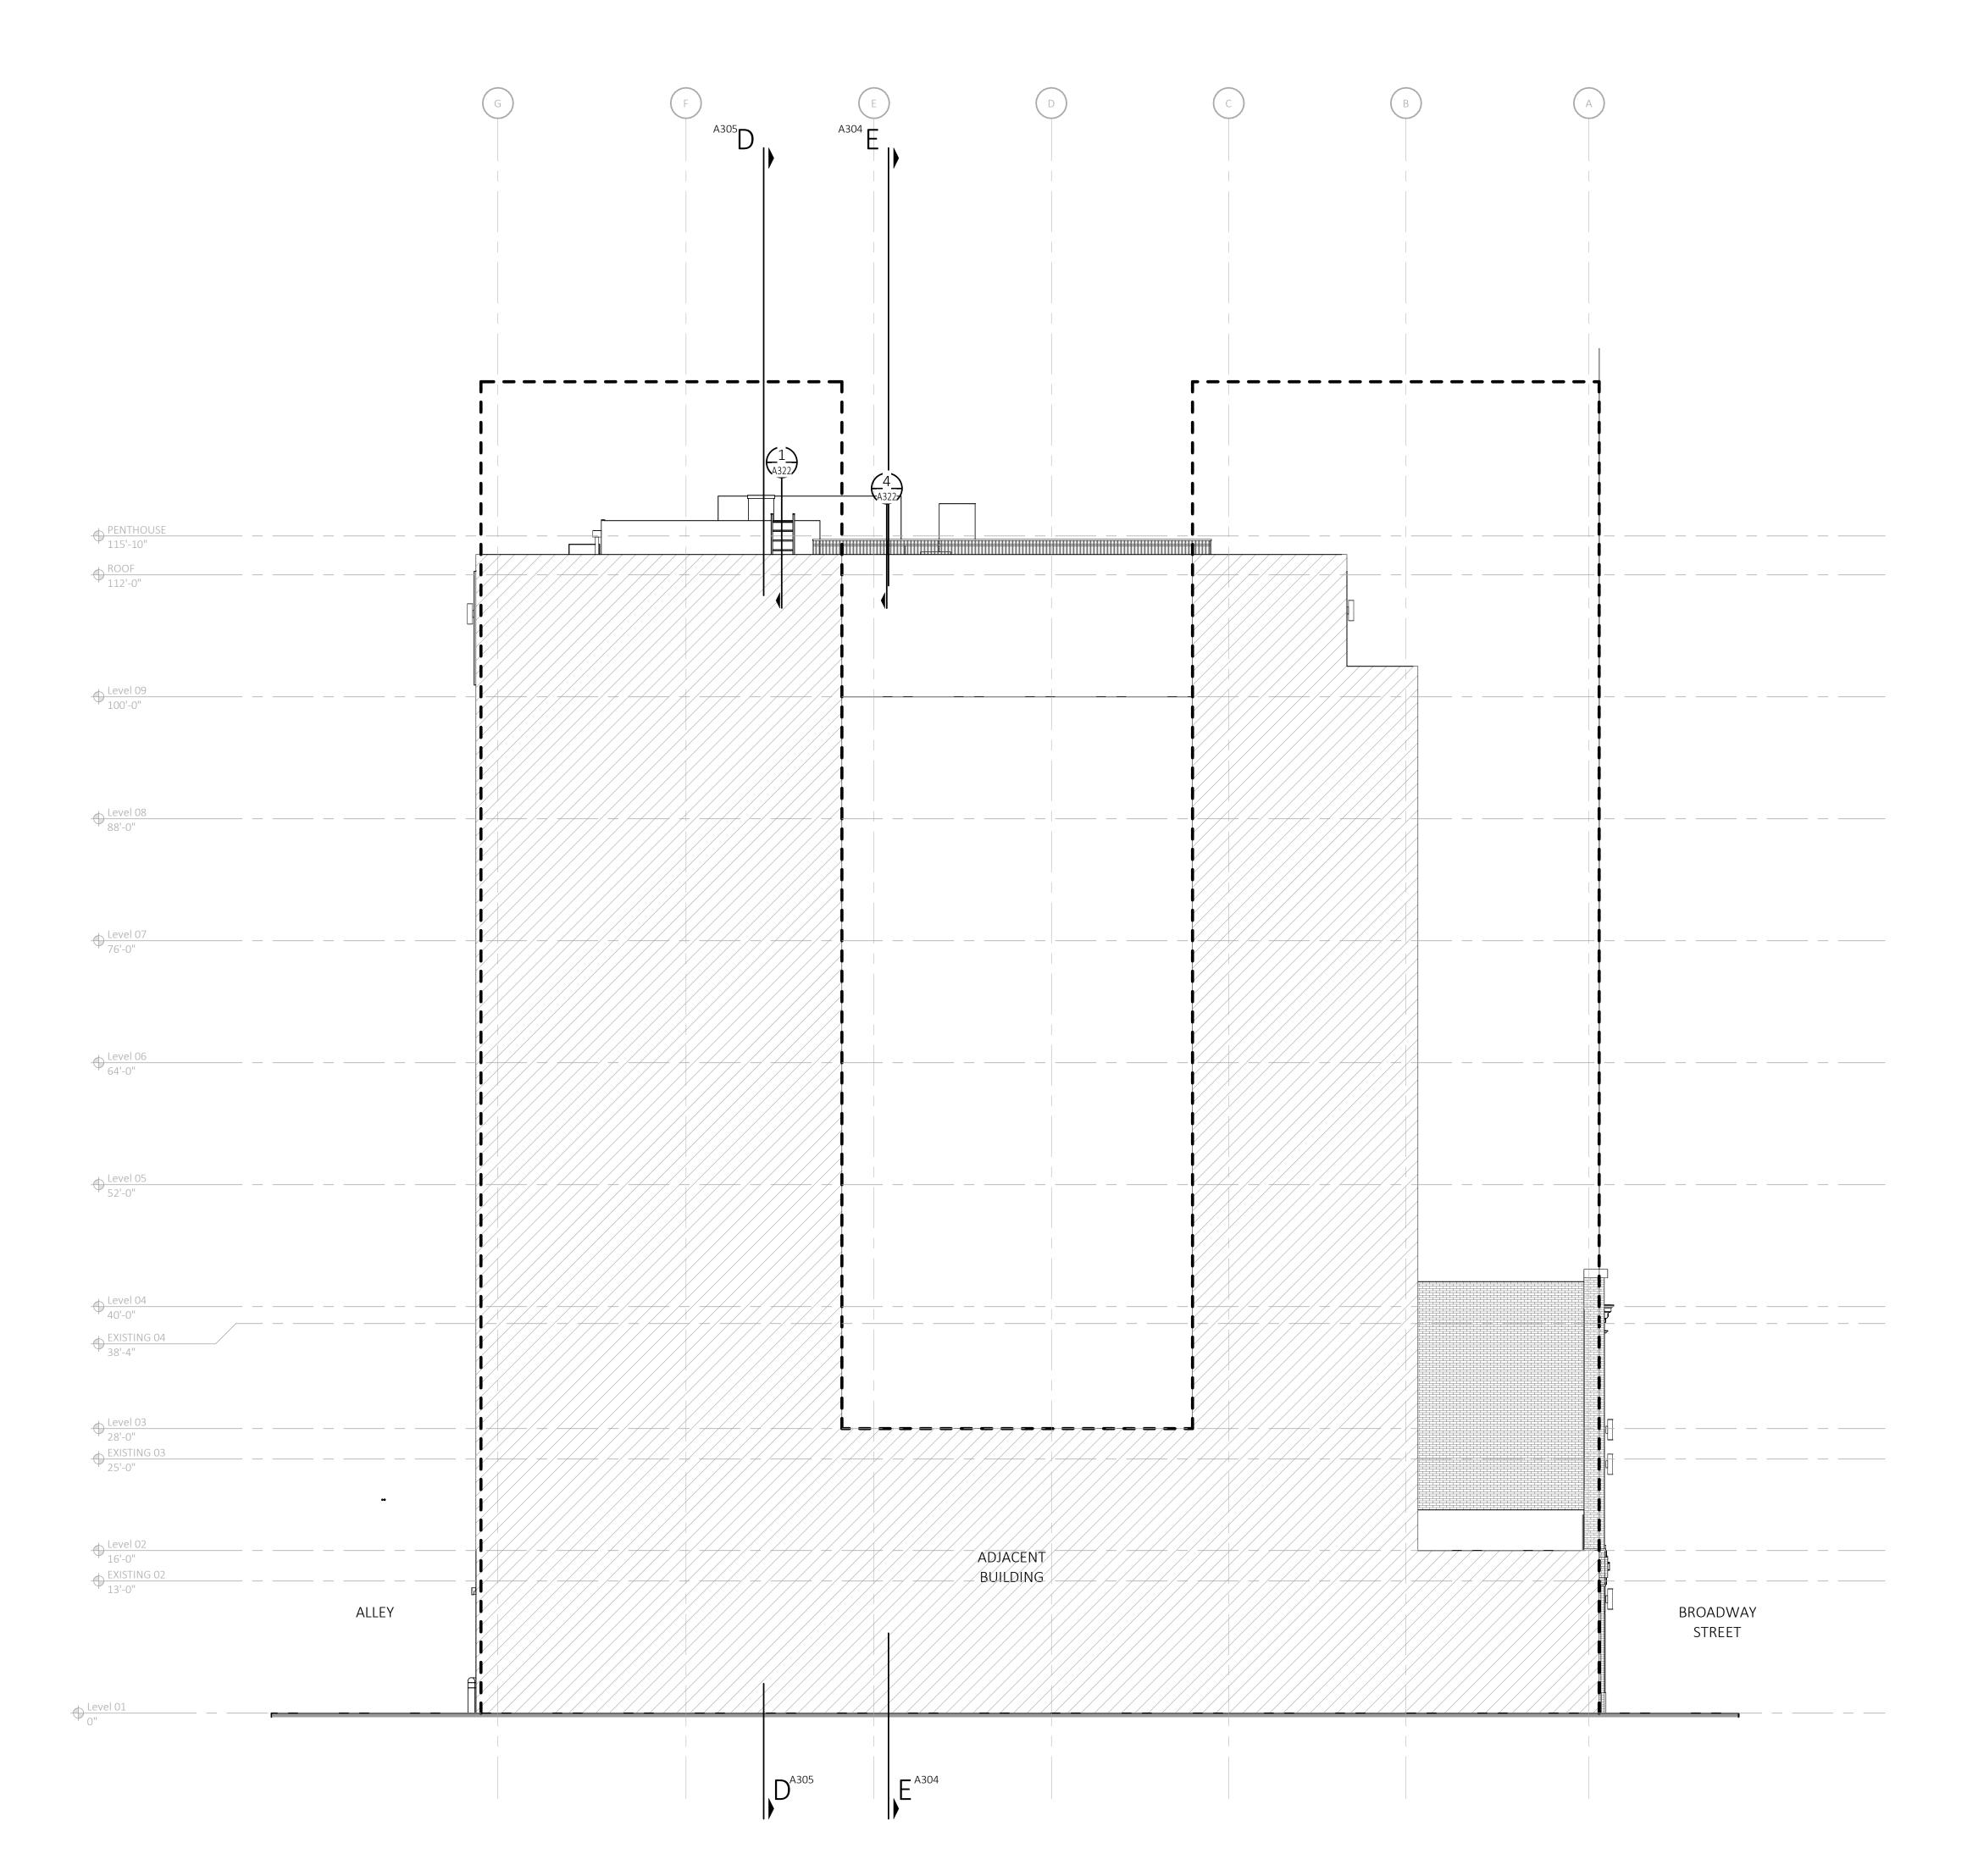
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PERMIT DATE

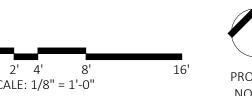Project Number

Sheet Title

EXTERIOR ELEVATIONS



1 EL-WEST ELEVATION

SCALE: 1/8" = 1'-0"
REFERENCE LOCATIONS: A101

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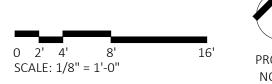
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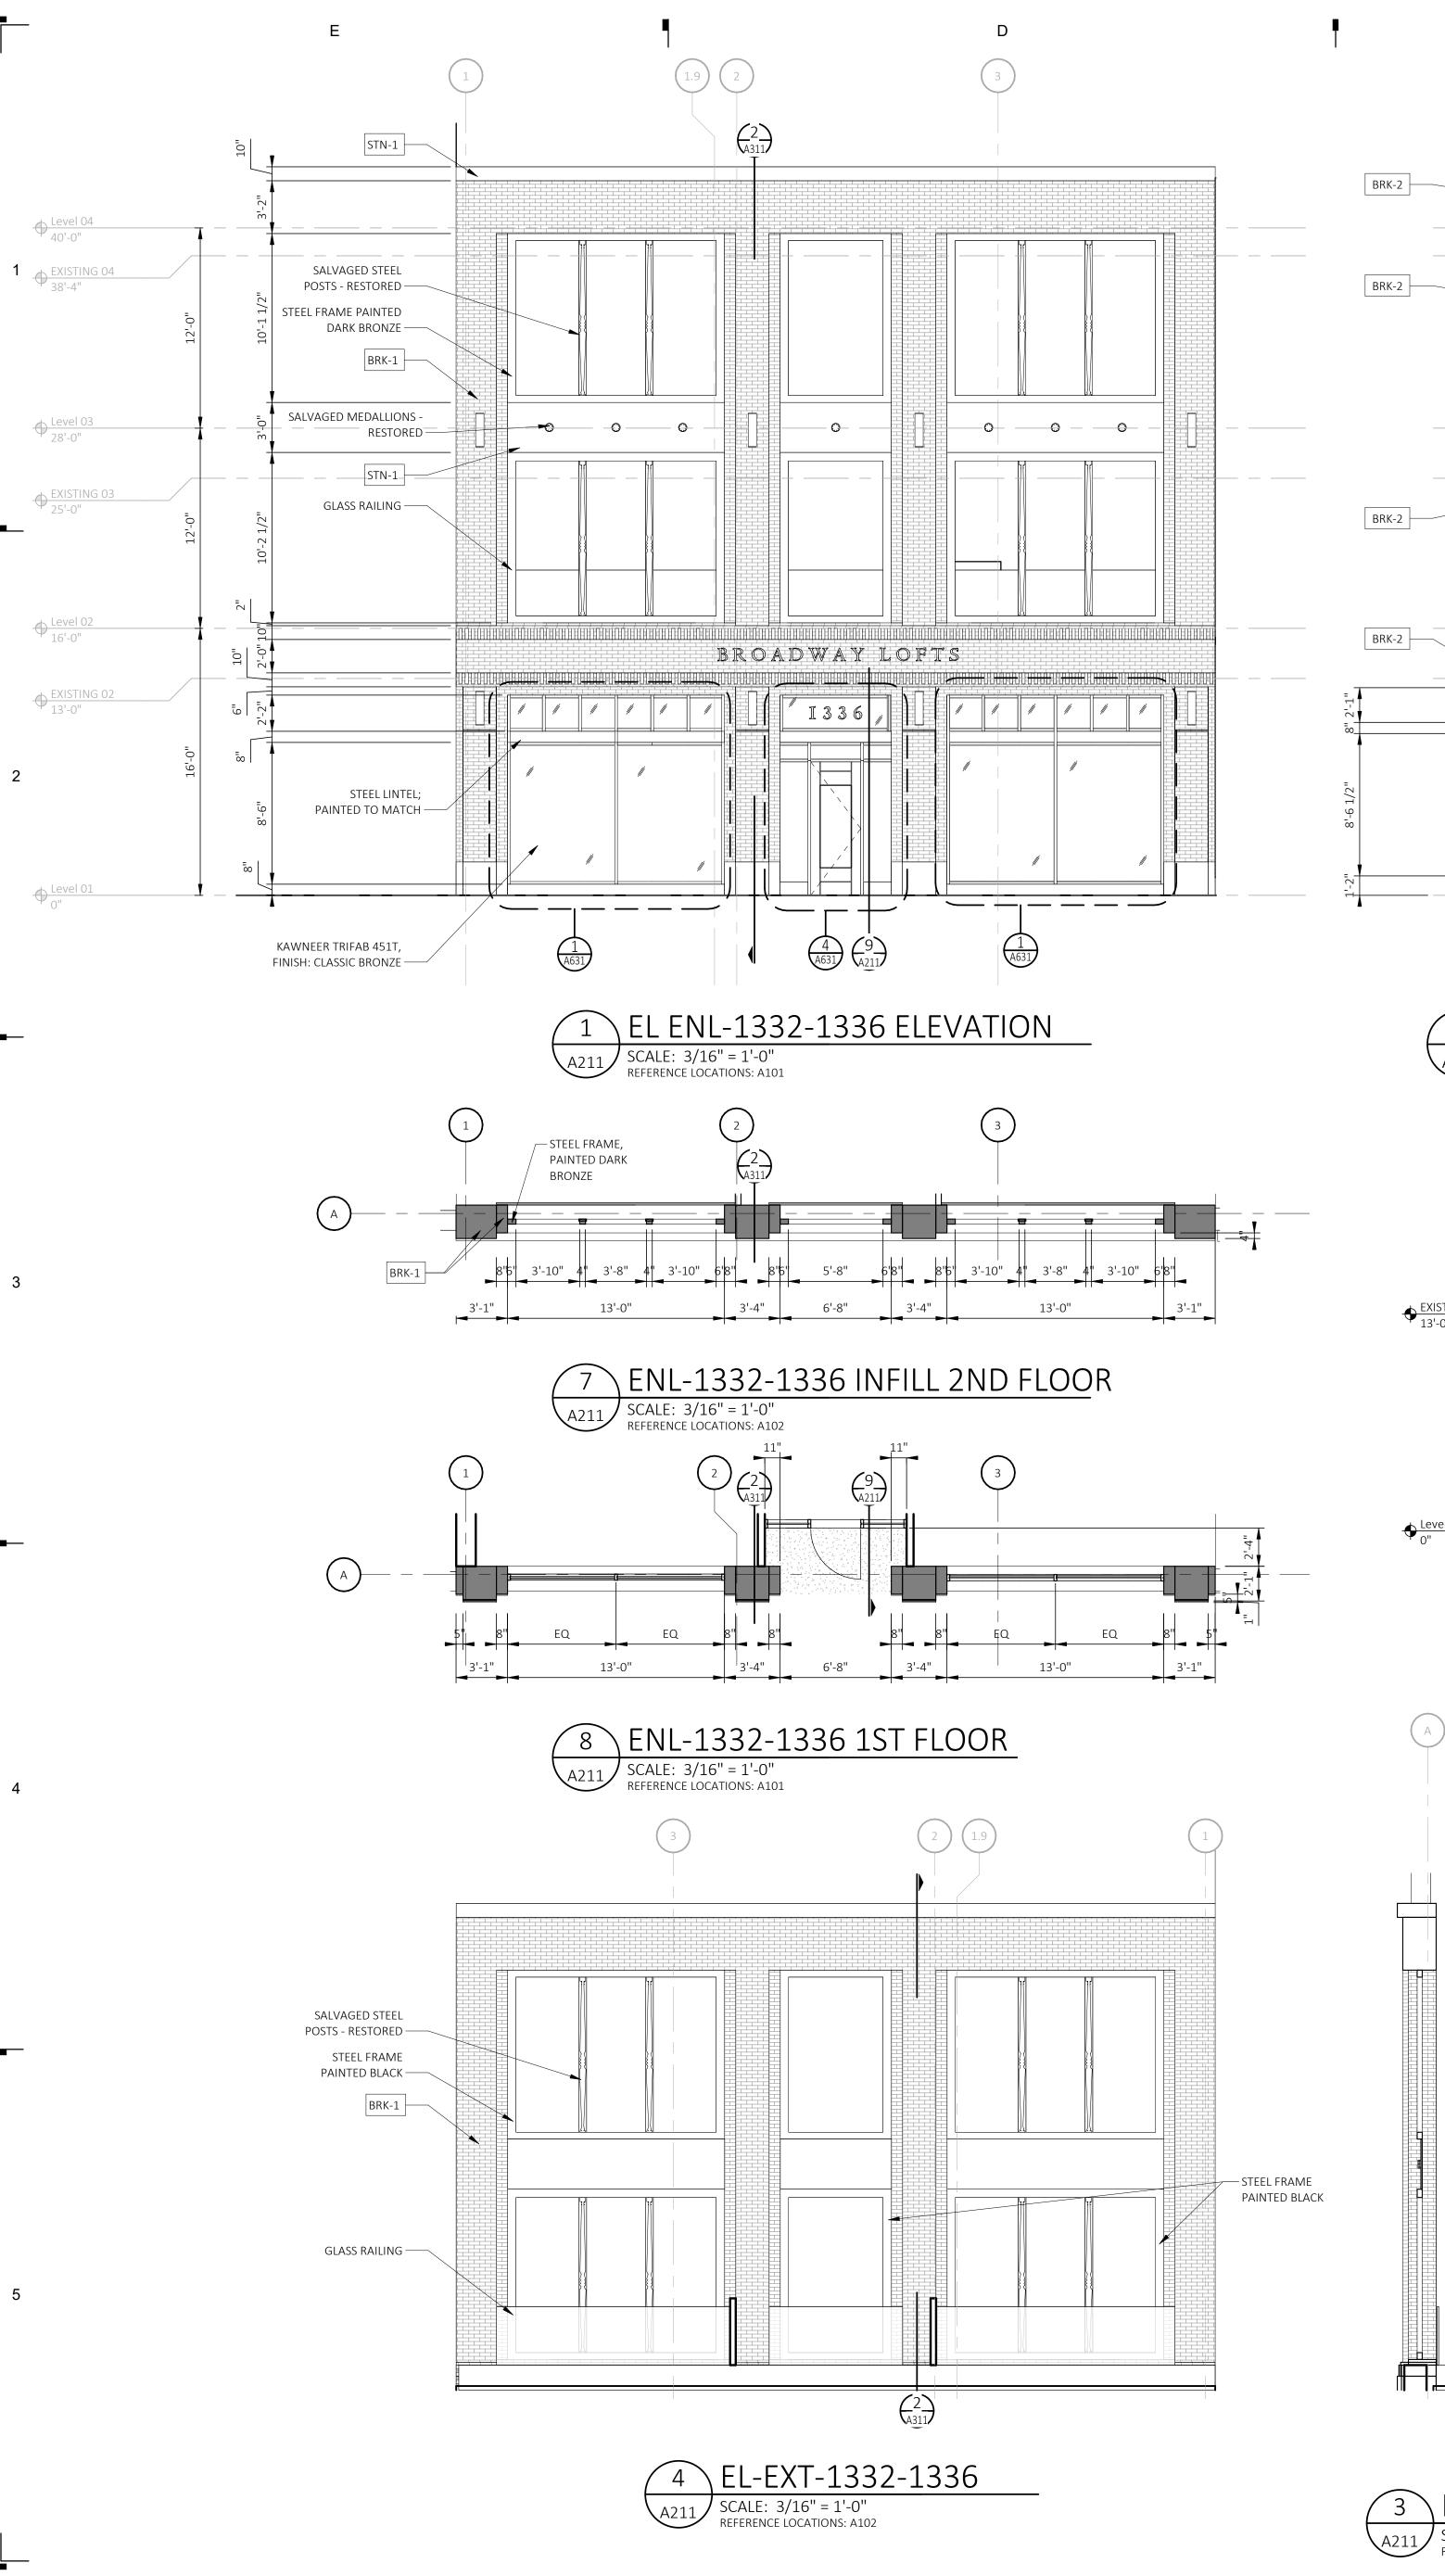
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EXTERIOR


ELEVATIONS










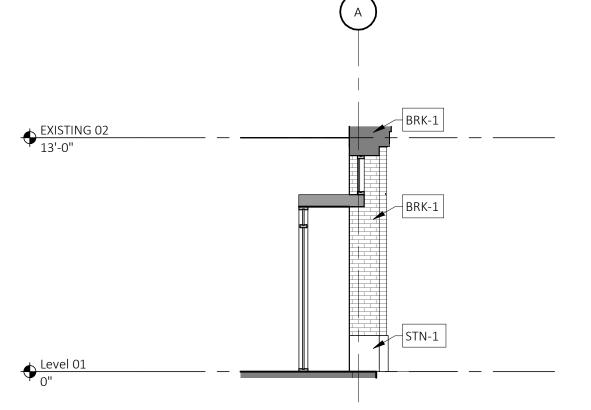

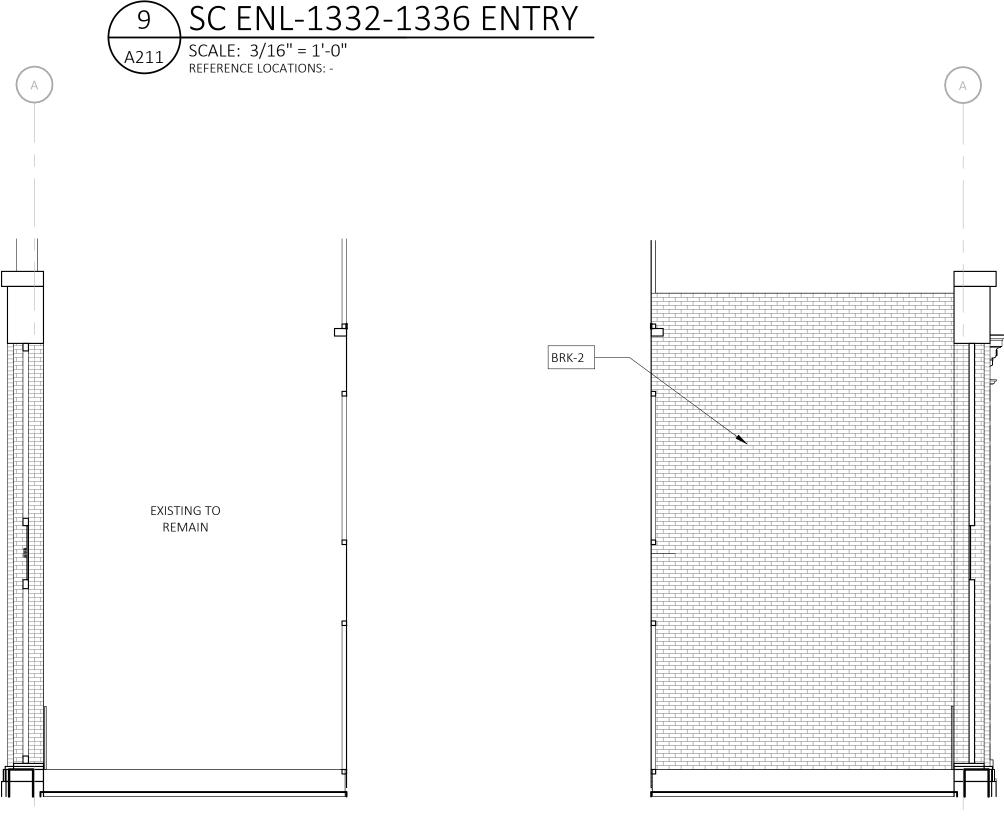







EXTERIOR ELEVATION MATERIAL LEGEND

MTL-1A FLAT, FINISH: CHAMPAGNE

MTL-1B FLAT, FINISH: CLASSIC BRONZE

MTL-2A CORRUGATED, FINISH: CHAMPAGNE

MTL-3A CORRUGATED PERFORATED, FINISH:

MTL-3B CORRUGATED PERFORATED, FINISH: MEDIUM BRONZE

CHAMPAGNE

MTL-4A TRIM, FINISH: CHAMPAGNE

MTL-4B TRIM, FINISH: CLASSIC BRONZE

MTL-2B CORRUGATED, FINISH: MEDIUM BRONZE



BRK-1 BRICK TECH, FINISH: OBSIDIAN VELOUR

BRK-3 BELDEN BRICK, FINISH: GRAPHITE BLACK VELOUR

BRK-2 EXISTING BRICK

STN-2 LIMESTONE

STN-1 HISTORIC STONE PANELS

TRC-1 EXISTING TERRA COTTA

GENERAL NOTES

- A REFER TO A600 SERIES FOR WINDOW AND DOOR SCHEDULE AND DETAILS. B REFER TO REFLECTED CEILING PLANS FOR EXTERIOR SOFFIT INFORMATION.
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- INSTITUTE. PROVIDE CONTROL JOINTS AT ALL MASONRY REENTRANT CORNERS. F PROVIDE BACKING AND/OR STRUCTURAL SUPPORT AS REQUIRED FOR SIGNAGE AND LIGHTING.
- G EXPOSED STRUCTURAL STEEL SHALL BE GALVANIZED AND PAINTED UNLESS NOTED OTHERWISE. H APPLY SEALANT WHENEVER DISSIMILAR MATERIALS MEET.

EXTERIOR RESTORATION NOTES

- A. MASONRY/STONE RESTORATION CONTRACTOR ("SUBCONTRACTOR") TO PROVIDE ALL LABOR, MATERIAL, EQUIPMENT, SUPERVISION, PERMITS AND ANY OTHER COSTS OR EXPENSES NECESSARY TO COMPLETE THE WORK. SUBCONTRACTOR JOB MOBILIZATION SHALL INCLUDE, BUT NOT BE LIMITED TO, ANY NECESSARY WORKSTATION AND JOB TRAILER, MAST CLIMBING PLATFORMS, AERIAL LIFTS, SWING STAGES, BARRICADES AND WALK THRU SCAFFOLD AS NEEDED.
- BUILDING RESTORATION TO INCLUDE ALL TERMS, CONDITIONS AND SPECIFICATIONS OF ORIGINAL CONTRACT AND ANY ADDITIONAL WORK NECESSARY TO MEET THE SECRETARY OF THE INTERIOR STANDARDS FOR THE REHABILITATION OF HISTORIC PROPERTIES. THIS INCLUDES ALL WORK NECESSARY OVER AND ABOVE THAT SPECIFIED IN THE ARCHITECTURAL DRAWINGS AND OTHER CONSTRUCTION DOCUMENTS, INCLUDING ALL NOTES REGARDLESS OF TIME AND MATERIAL NECESSARY TO EXECUTE THIS WORK. ANY AREAS INDICATED WITHIN DRAWINGS ARE ONLY SUGGESTIVE IN NATURE. MASON TO MEET WITH ARCHITECT AND OWNER TO CONFIRM THE SCOPE
- PARAPET FULL HEIGHT, FOR STRUCTURAL STABILITY PRIOR TO BID. REINSPECT AFTER INITIAL
- PARAPET TO GRADE. SEE MASONRY CLEANING SPECIFICATION SECTIONS FOR DETAILS ON
- E. CLEAN FACADE USING GENTLEST MEANS POSSIBLE TO ACHIEVE SATISFACTORY RESULTS WITHOUT CHANGING THE SURFACE OF THE MASONRY. PAY SPECIAL ATTENTION TO AREAS OF EXCESSIVE SOILING. CONTRACTOR SHALL CONDUCT TEST PATCHES TO ENSURE THE BEST AND MOST ECONOMICAL MEANS OF CLEANING. ALL MASONRY AND TERRA COTTA CLEANING SHALL MEET THE SECRETARY OF INTERIOR STANDARDS FOR REHABILITATION AS WELL AS ALL APPLICABLE
- F. SURFACES TO BE PRE-WET WITH CLEAN WATER. CLEANING SOLUTIONS TO NOT REMAIN ON SURFACES FOR MORE THAN 5 MINUTES FOLLOWED IMMEDIATELY BY LOW-PRESSURE FLOOD MASONRY / STONE UNIT AS CLOSE AS POSSIBLE TO ORIGINAL COLOR WITHOUT BURNING OR
- G CLEAN ALL STONE THAT IS TO REMAIN & LET WEATHER FOR TWO WEEKS BEFORE ANY REPLACEMENT OR PATCHING IS TO OCCUR - REPLACEMENT STONE & PATCHED AREAS TO MATCH
- H. 100% OF MORTAR JOINTS TO BE VISUALLY INSPECTED. ALL MORTAR JOINTS DETERIORATED IN EXCESS OF 3/8 INCH BEYOND FACE OF MASONRY/STONE UNIT, OR EVIDENCING UNSOUNDNESS OF CRACKING WHETHER STRUCTURAL OR OTHERWISE SHALL BE REMOVED TO A DEPTH OF 1/2" MINIMUM. WRITTEN APPROVAL BY OWNER SHALL BE REQUIRED PRIOR TO COMMENCEMENT OF
- K. NO ACCELERATORS OR OTHER ADMIXTURES SHALL BE USED WITHOUT PRIOR WRITTEN OWNER APPROVAL. ENCLOSURES AND HEAT SUFFICIENT TO PROTECT MORTAR FROM FREEZING PRIOR TO SET SHALL BE THE SOLE RESPONSIBILITY OF SUBCONTRACTOR.
- IF NECESSARY, RECOMMEND FURTHER REHABILITATION TO ENSURE STABILITY OF EXTERIOR WALL AND PARAPET CONSTRUCTION. SEE MASONRY RESTORATION SPECIFICATIONS FOR DETAILS ON APPROVED RESTORATION PROCEDURES, PRODUCTS, AND MANUFACTURERS, ALL MASONRY RESTORATION WORK SHALL MEET THE SECRETARY OF INTERIOR STANDARDS FOR REHABILITATION AS WELL AS ALL APPLICABLE NATIONAL PARK SERVICE TECHNICAL BRIEFS.
- M. ALL MASONRY/ STONE UNIT SHALL BE REPLACED WITH OWNER APPROVED MATERIAL WHEREIN SPALLING OR OTHER DETERIORATION ELIMINATED MORE THAN 5% OF THE MASONRY/ STONE UNIT (MEASURED BY ORIGINAL BRICK OR STONE FACE AREA).
- COAT RAW CLAY WITH APPROVED BREATHABLE SEALER TO MATCH COLOR OF EXISTING GLAZING.
- APPROVED MASONRY REPAIR MORTAR AS REQUIRED BY DEPTH OF DAMAGED AREA. COAT PATCHED AREA WITH APPROVED BREATHABLE SEALER TO MATCH COLOR OF EXISTING GLAZING.
- UNITS AND PROVIDE NEW TERRA COTTA UNITS TO MATCH EXISTING PROFILE, COLOR AND FINISH.
- PRODUCTS, AND MANUFACTURERS. ALL TERRA COTTA RESTORATION WORK SHALL MEET THE SECRETARY OF INTERIOR STANDARDS FOR REHABILITATION AS WELL AS ALL APPLICABLE NATIONAL PARK SERVICE TECHNICAL BRIEFS.

- C. RESTORATION CONTRACTOR SHALL INSPECT ALL EXISTING MASONRY, INCLUDING BOTH SIDES OF CLEANING OF MASONRY.
- D. ALL ELEVATIONS SHALL UNDERGO COMPLETE BRICK, STONE, AND TERRA COTTA CLEANING FROM APPROVED CLEANING PROCEDURES, PRODUCTS, AND MANUFACTURERS.
- NATIONAL PARK SERVICE TECHNICAL BRIEFS.
- RINSE, UNLESS NOTED OTHERWISE IN MASONRY CLEANING SPECIFICATION. CLEANING IS TO BRING
- EXIST 'CLEANED' COLOR
- REPAIR BY SATISFACTORY SUBMISSION OF MOCK-UP OF PROPOSED MORTAR JOINT.
- NEW MORTAR APPLIED TO ALL OPEN JOINTS SHALL BE OF NO GREATER STRENGTH THAN ORIGINAL MORTAR OR MASONRY UNITS. MORTAR COLOR, TEXTURE, CONSISTENCY AND JOINT PROFILE WILL MATCH EXISTING AS CLOSE AS POSSIBLE.
- J APPLY NEW, TWO COMPONENT URETHANE SEALANT AT ALL JOINTS WHERE DISSIMILAR JOINT PRIOR TO SEALANT APPLICATION.
- L. REPLACE/RESET LOOSE MASONRY UNITS AND REPOINT DAMAGED MORTAR JOINTS AS REQUIRED.
- N. INSPECT ALL TERRA COTTA UNITS FOR DAMAGE, SPALLING OR CRAZING.
- O. WHERE TERRA COTTA GLAZING HAS SPALLED AND THE CLAY SUBSTRATE IS IN GOOD CONDITION, P. WHERE TERRA COTTA UNITS HAVE SPALLED SIGNIFICANTLY, PATCH DAMAGED AREAS WITH
- Q. WHERE TERRA COTTA HAS DETERIORATED BEYOND REPAIR, REMOVE AFFECTED TERRA COTTA
- R. SEE TERRA COTTA RESTORATION SPECIFICATIONS FOR APPROVED RESTORATION PROCEDURES,

Consultant





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ELEVATIONS Sheet Number



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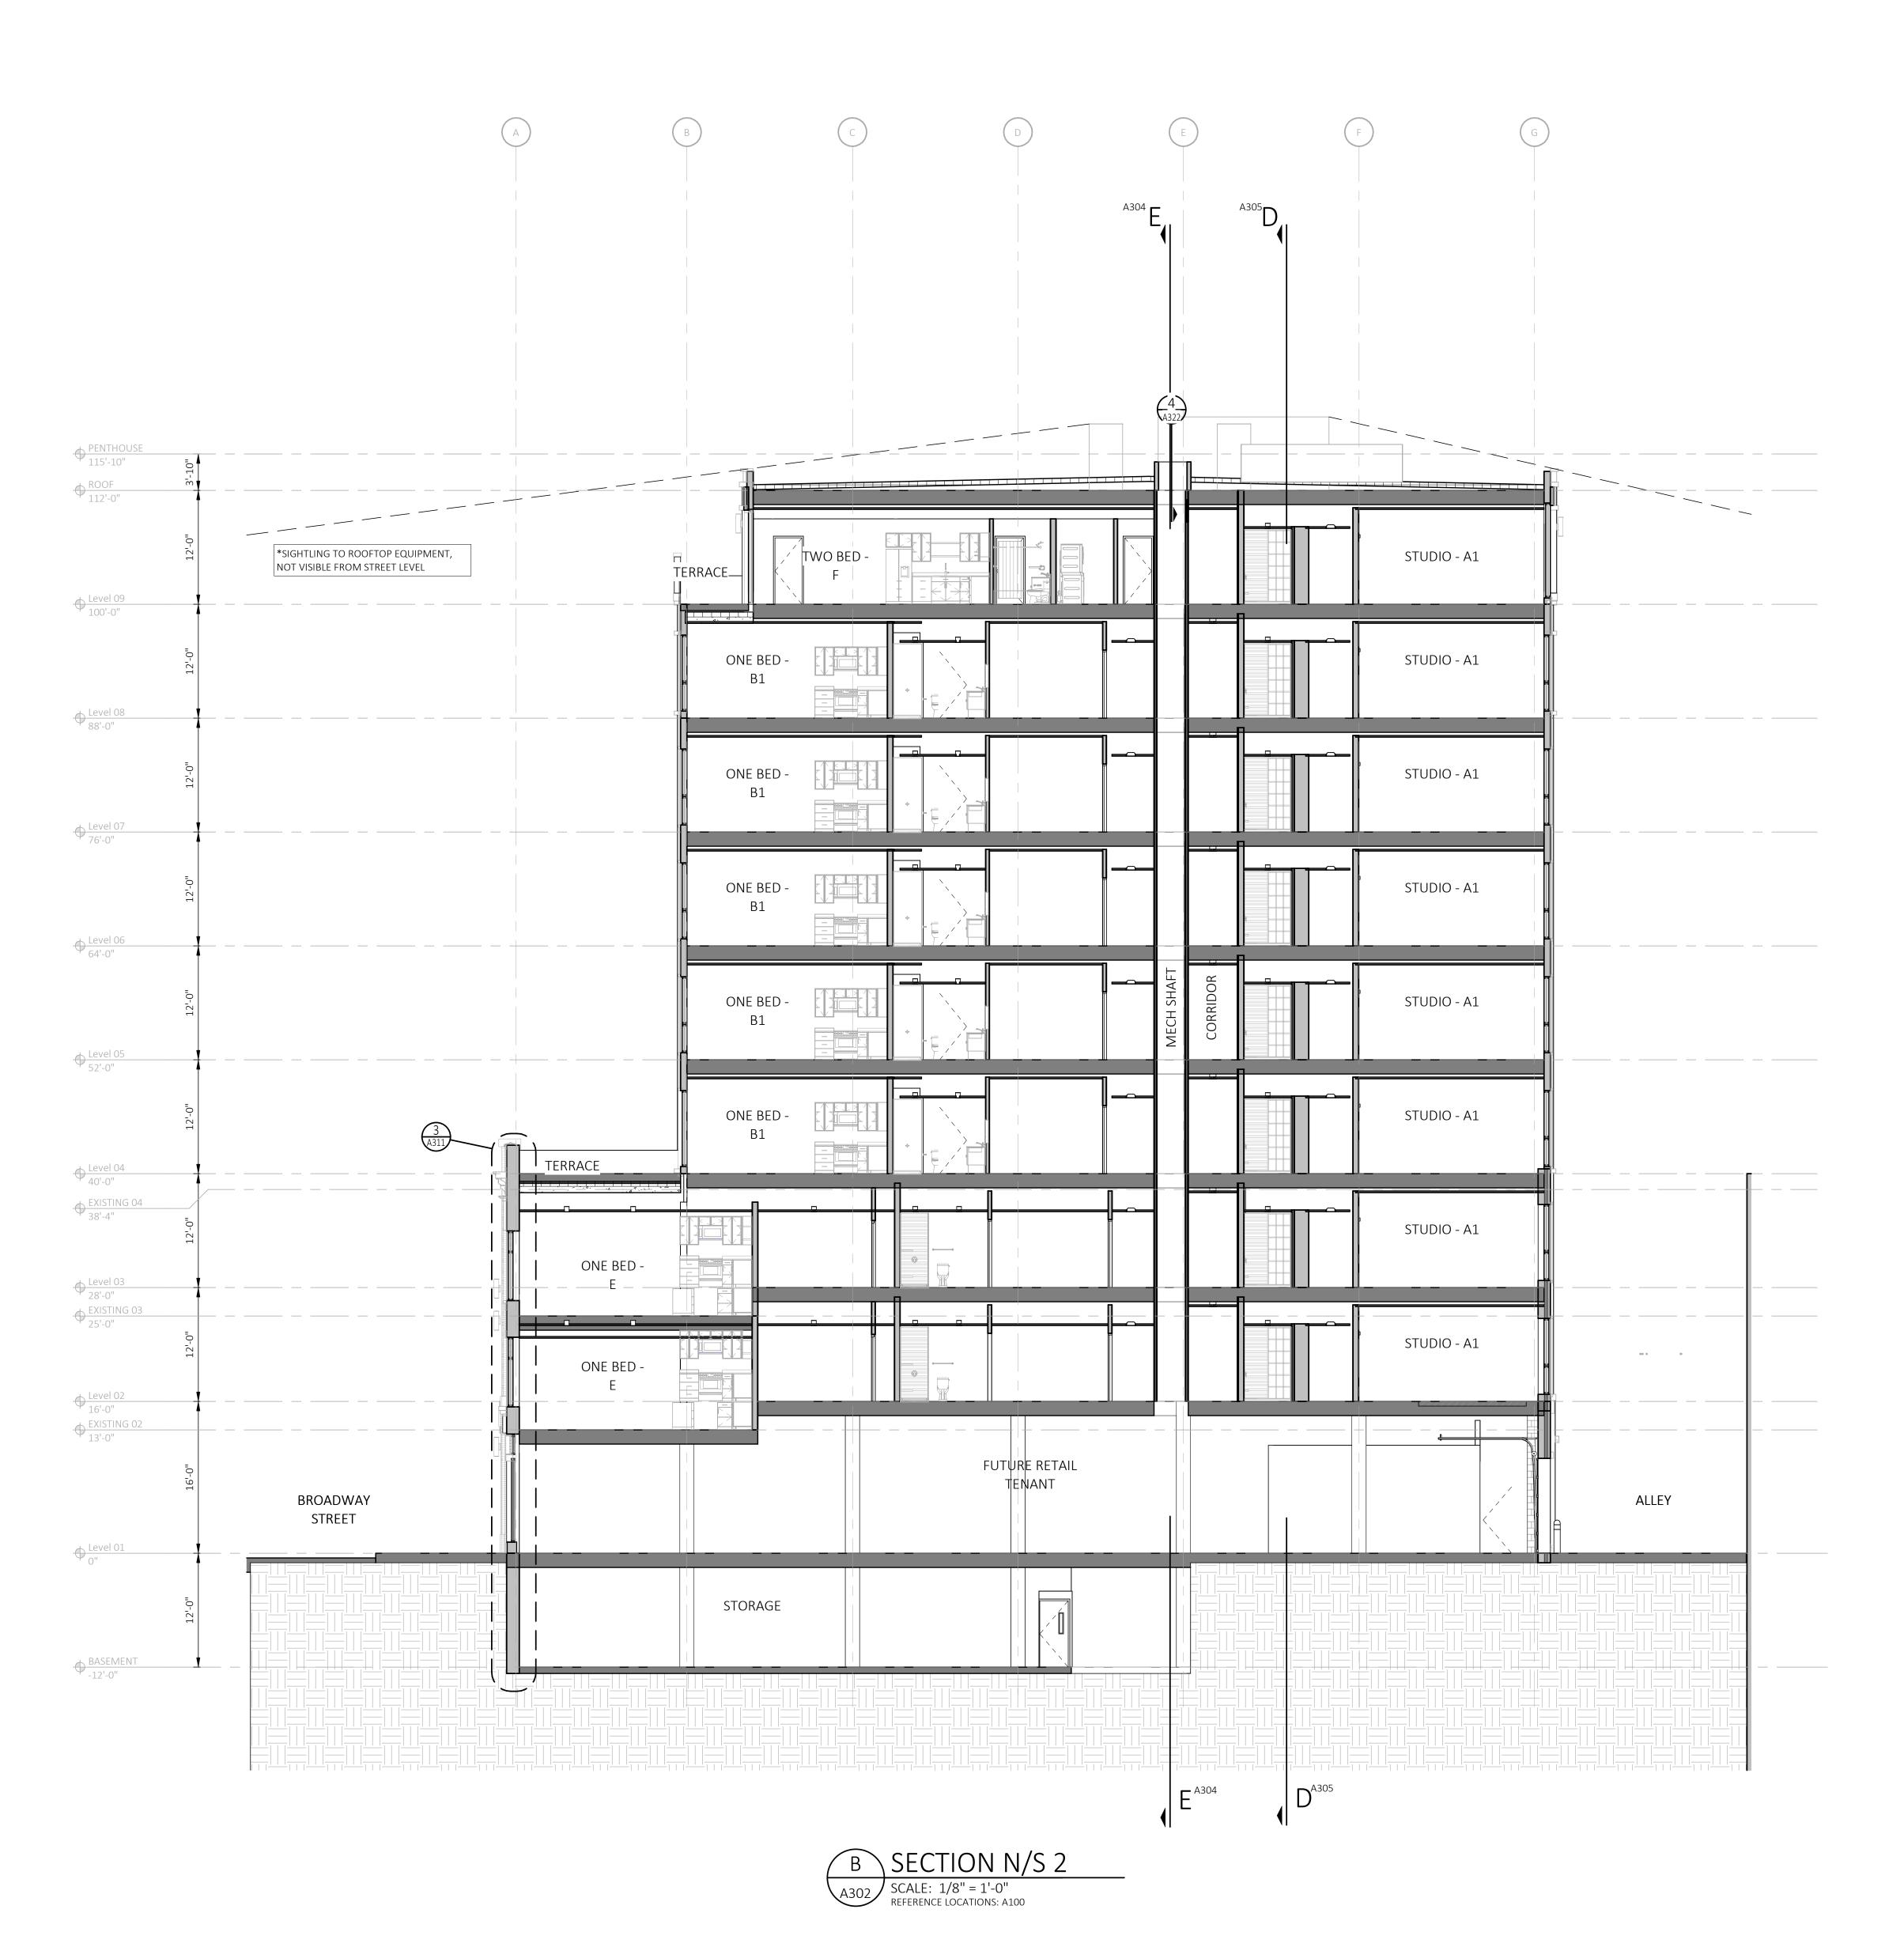
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Sheet Title
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SECTIONS

Sheet Number








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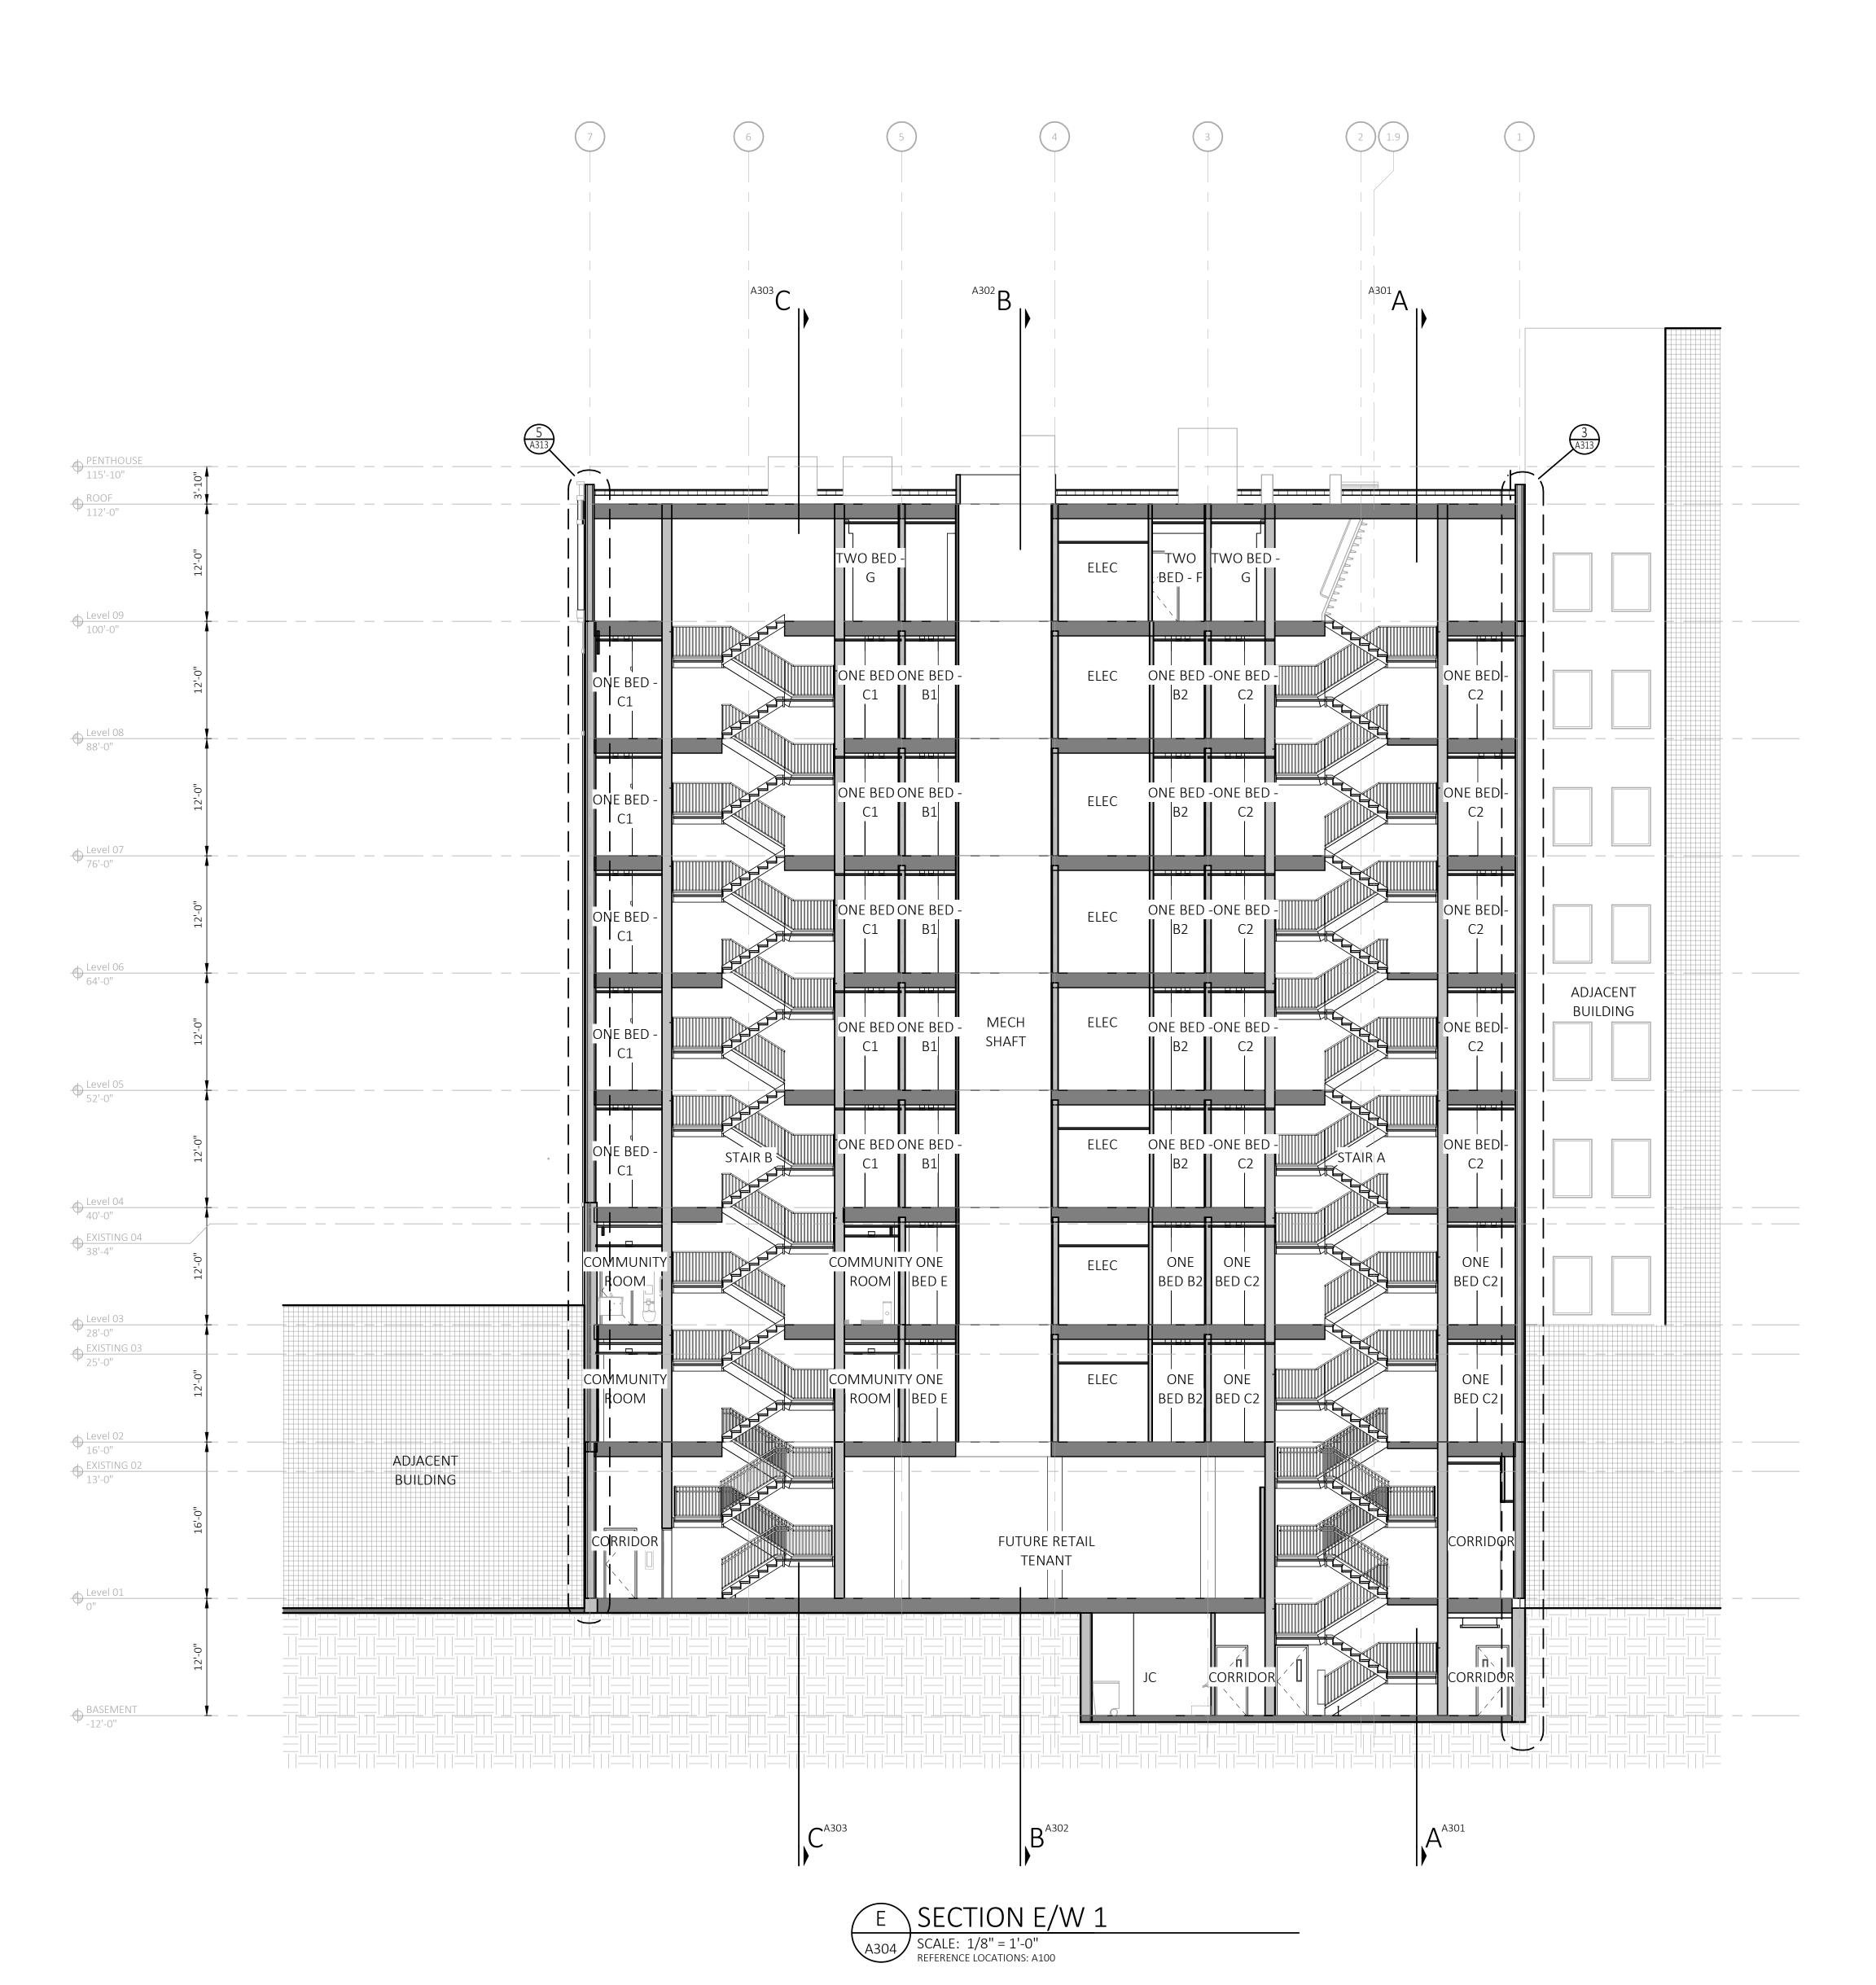
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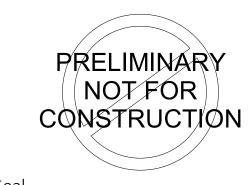
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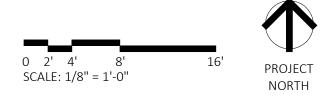
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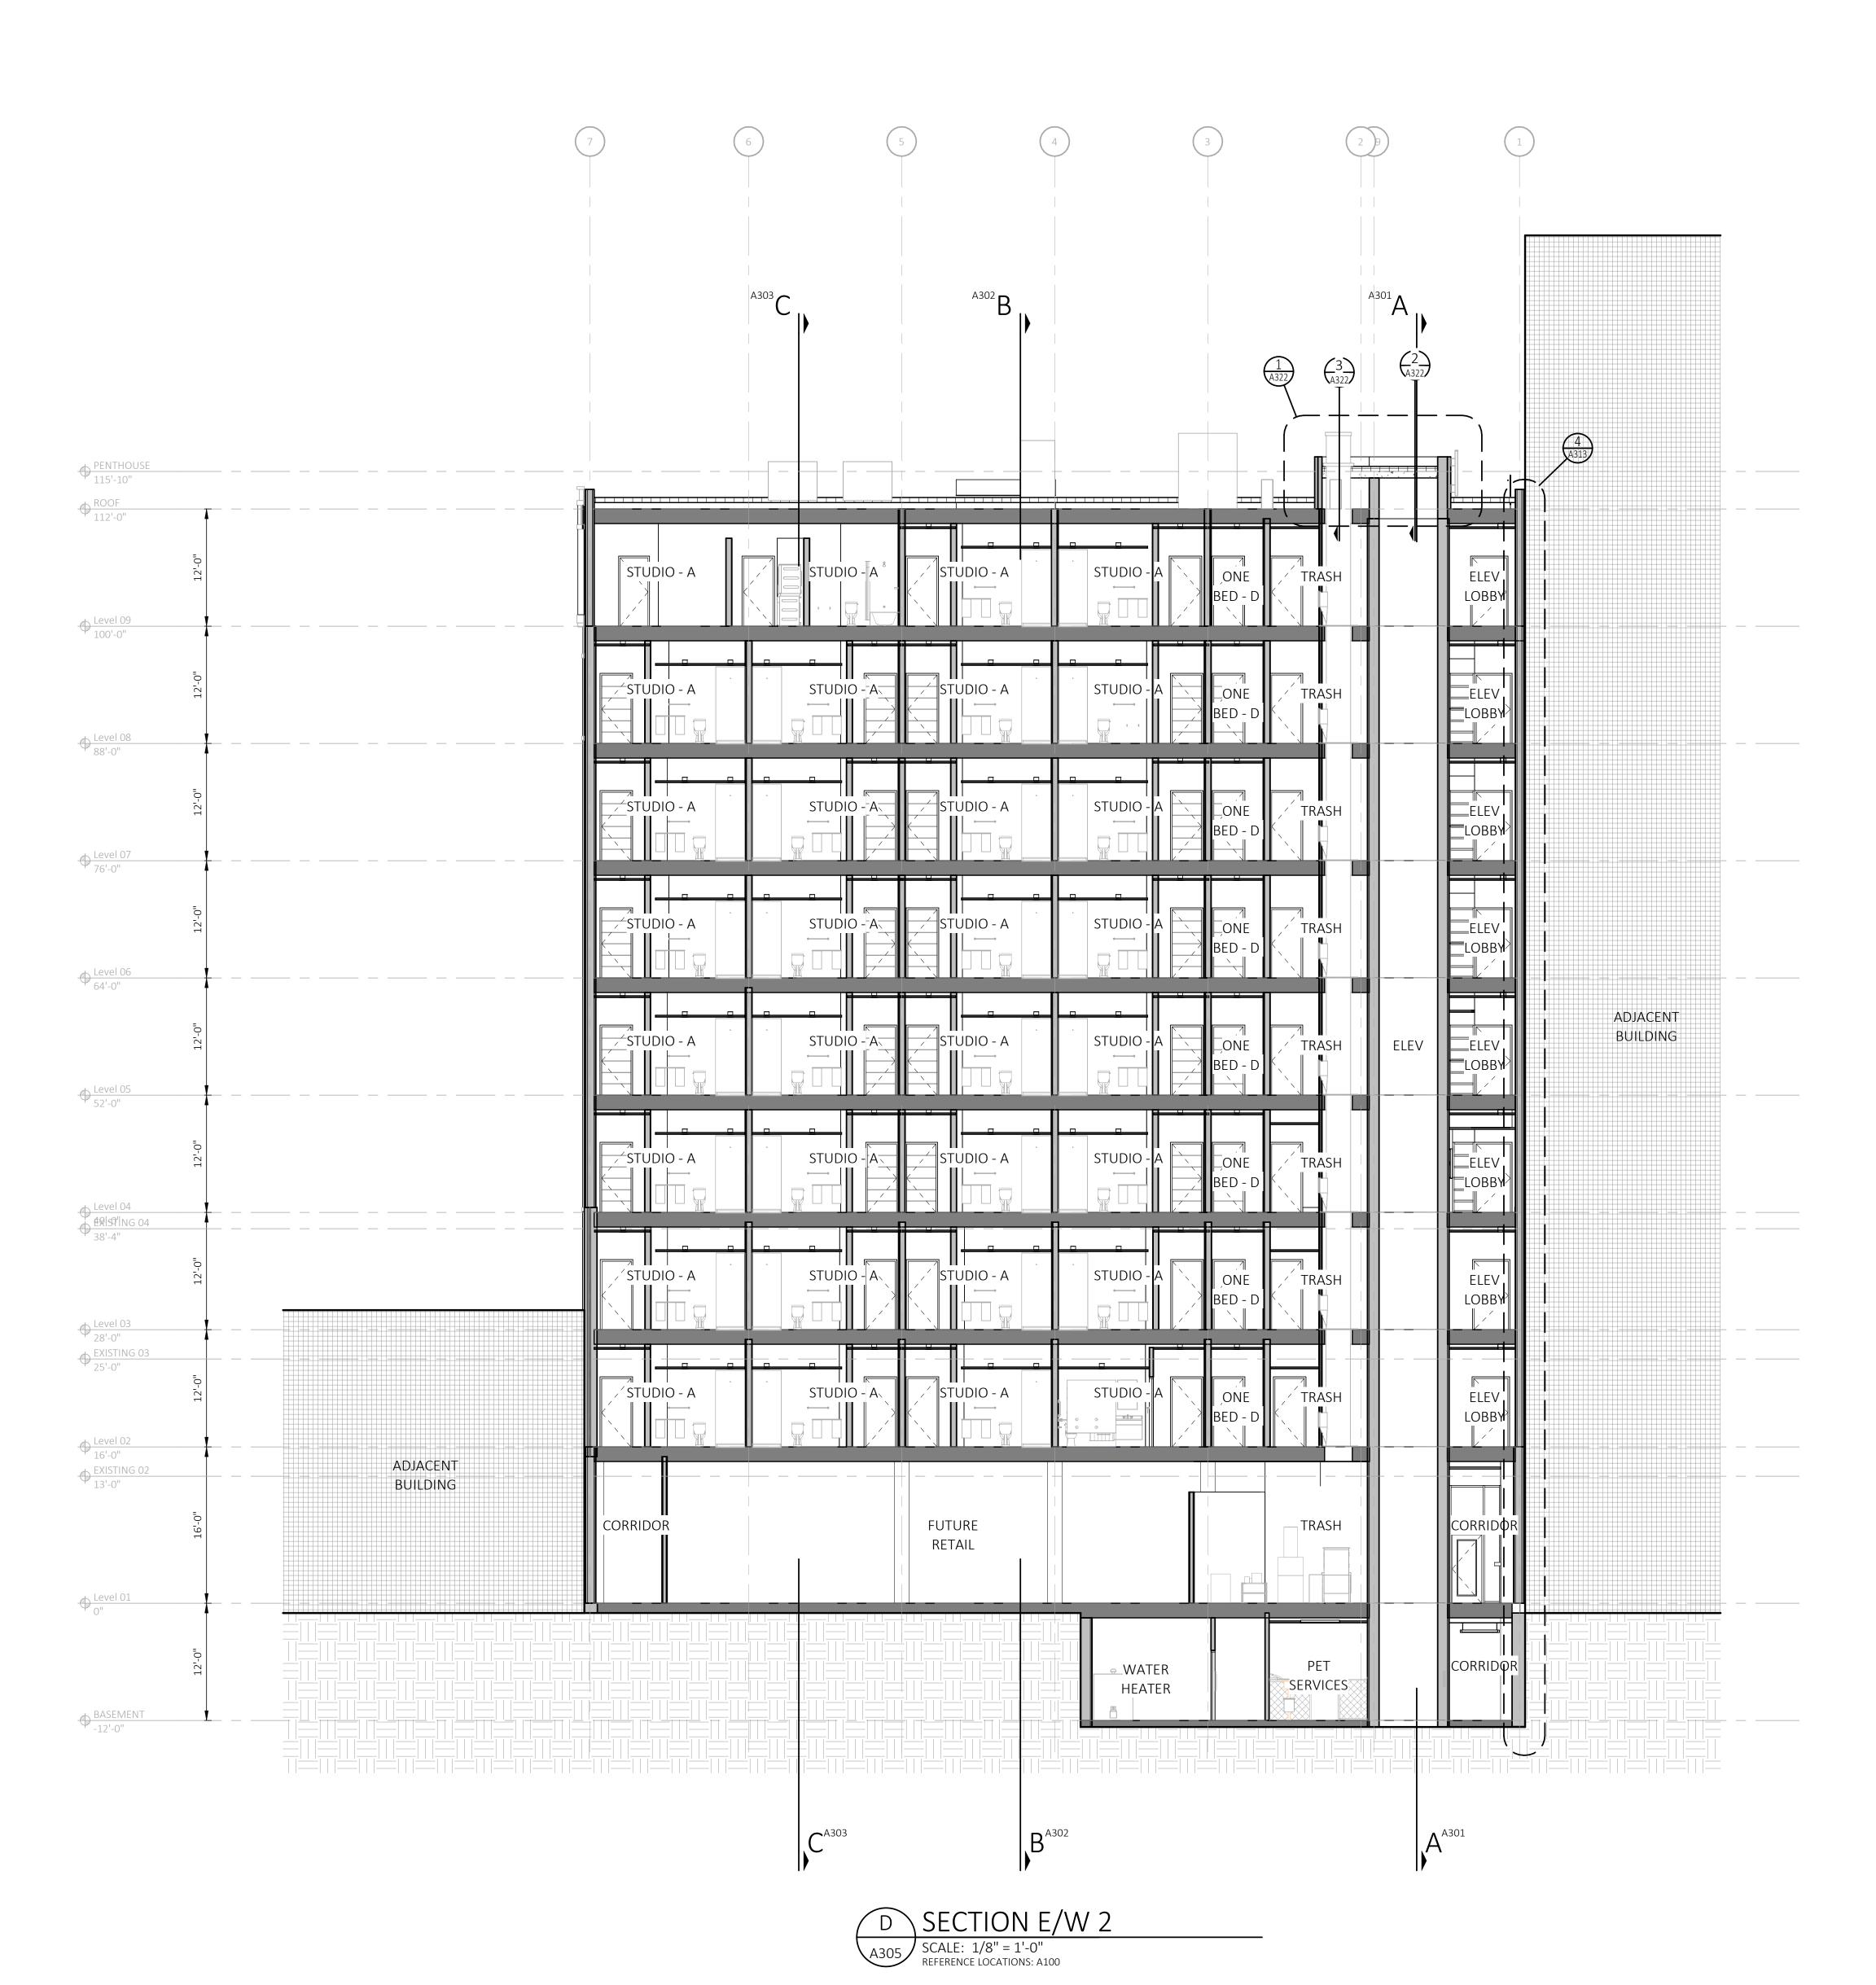
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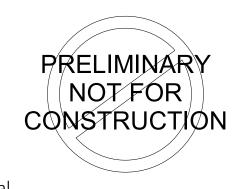
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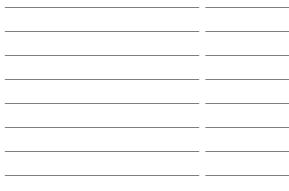
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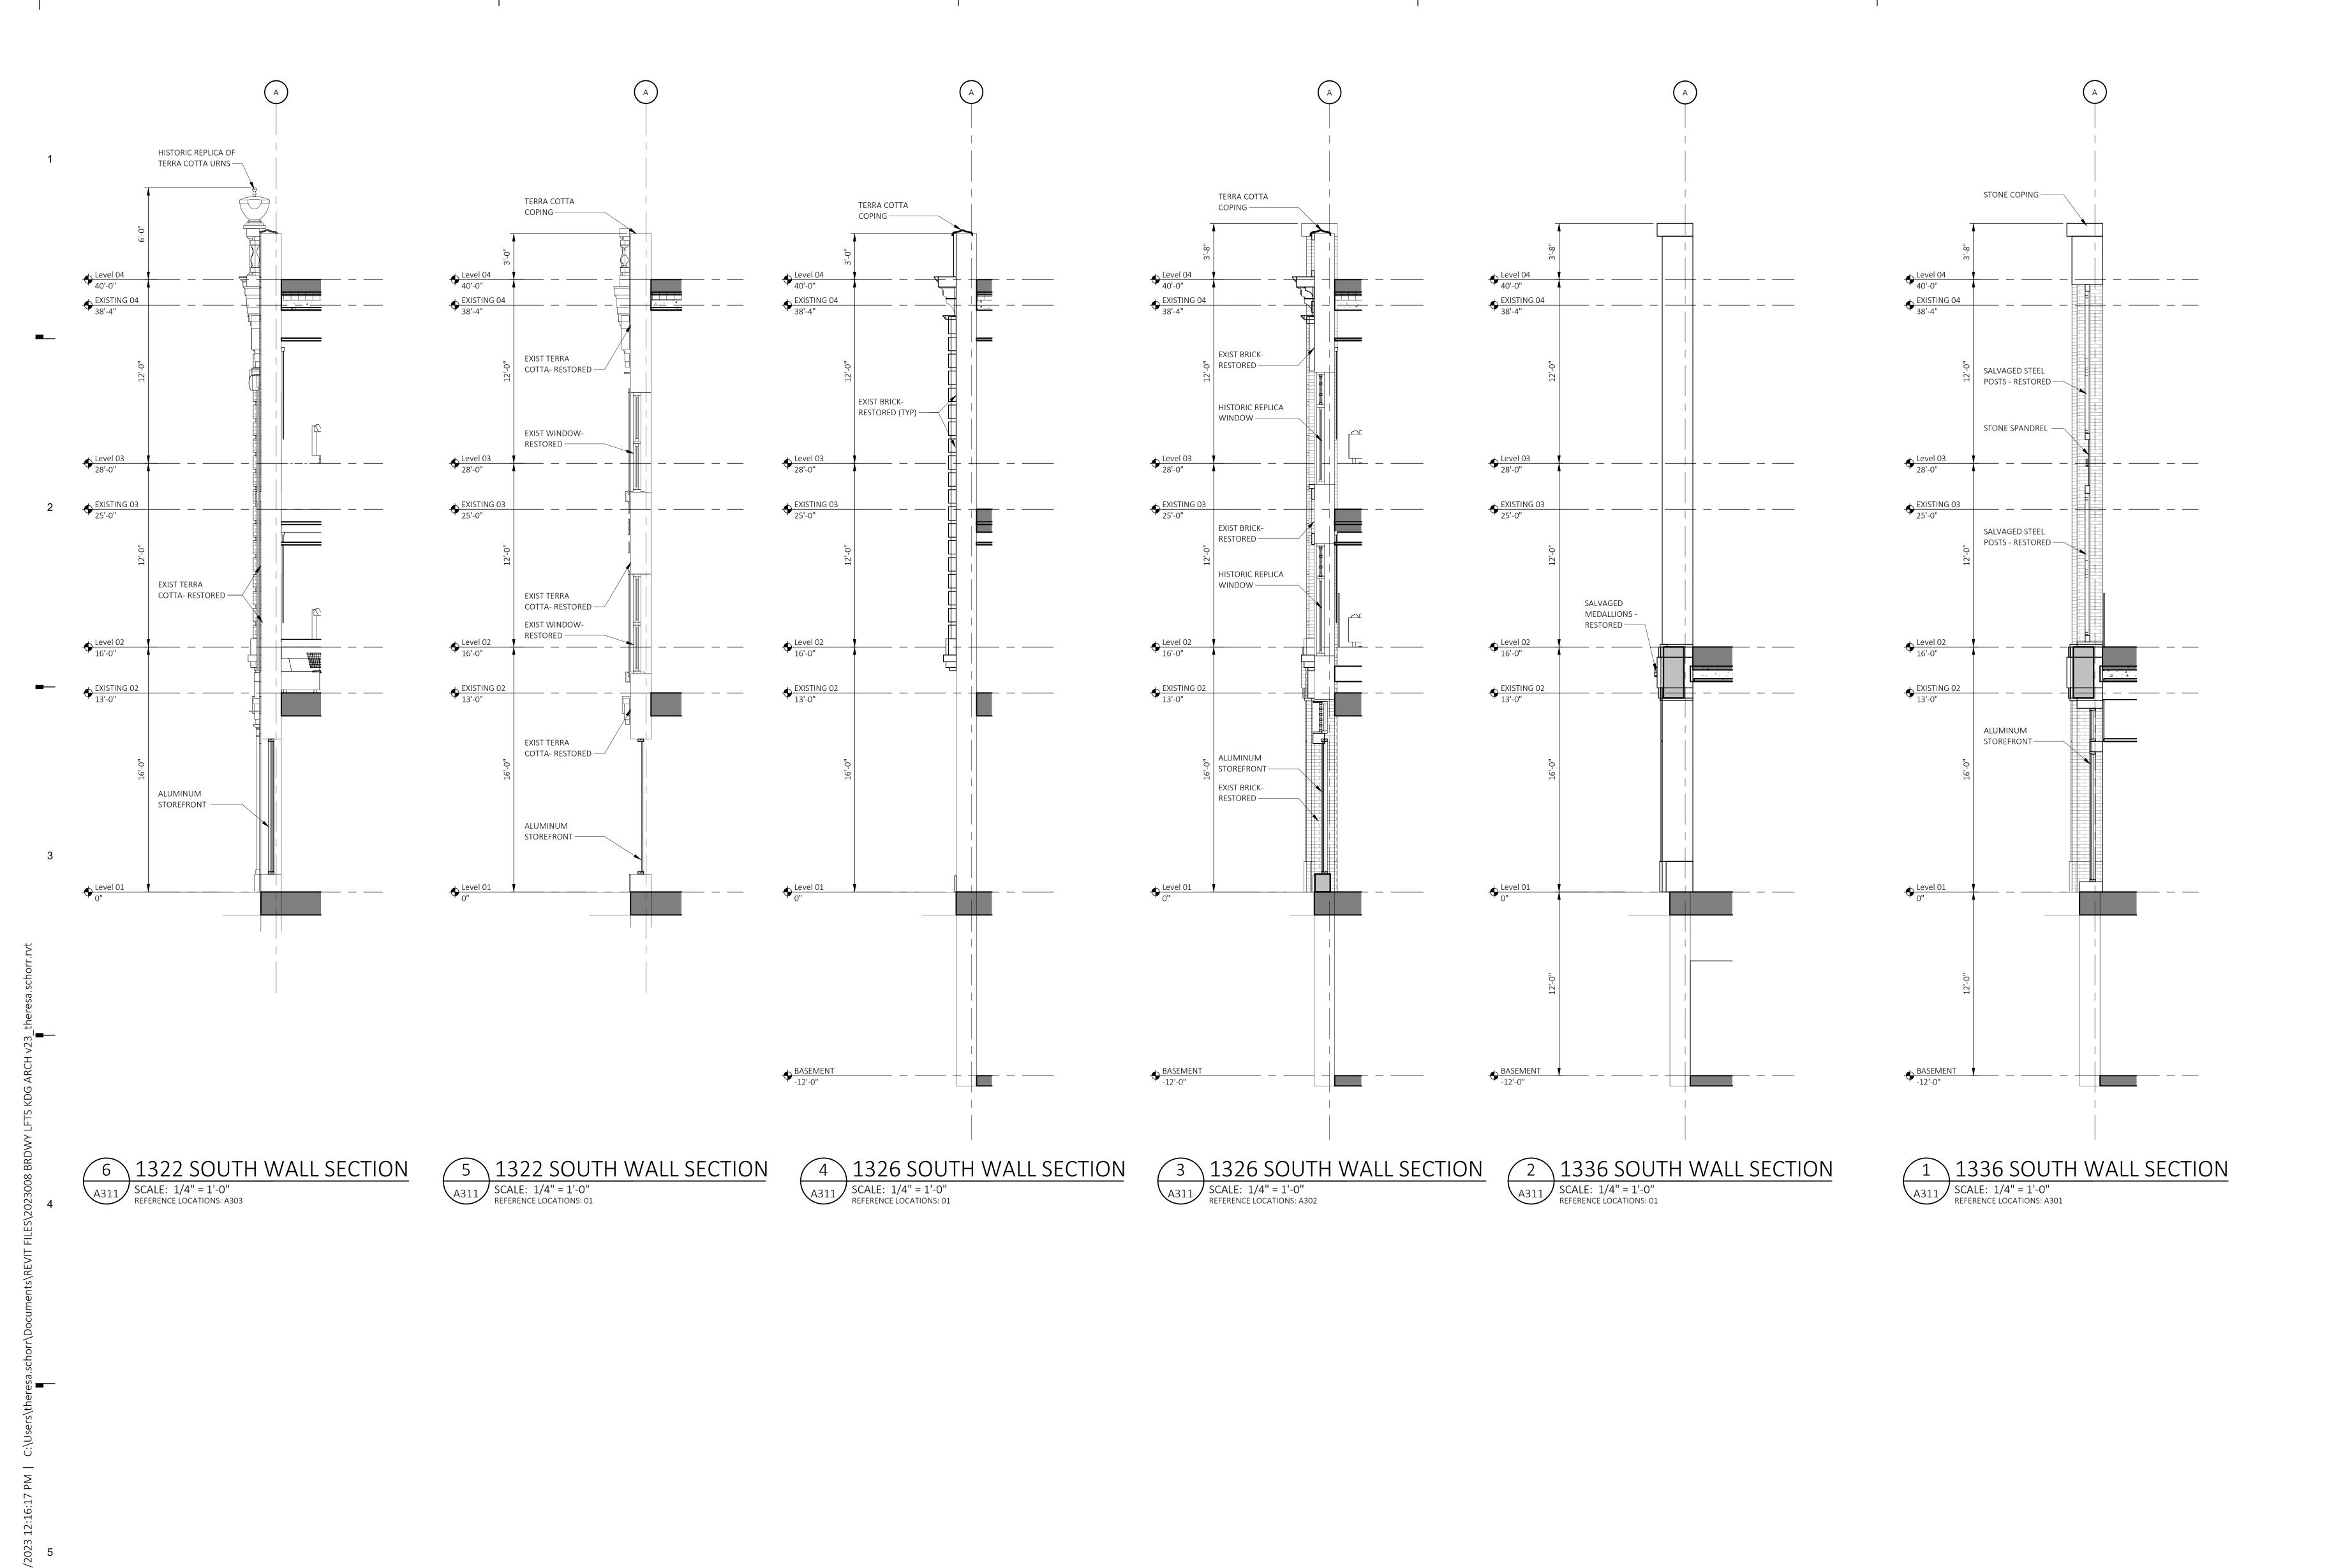
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Sheet Title
BUILDING
SECTIONS

Sheet Number

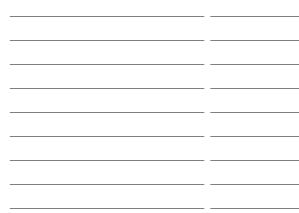



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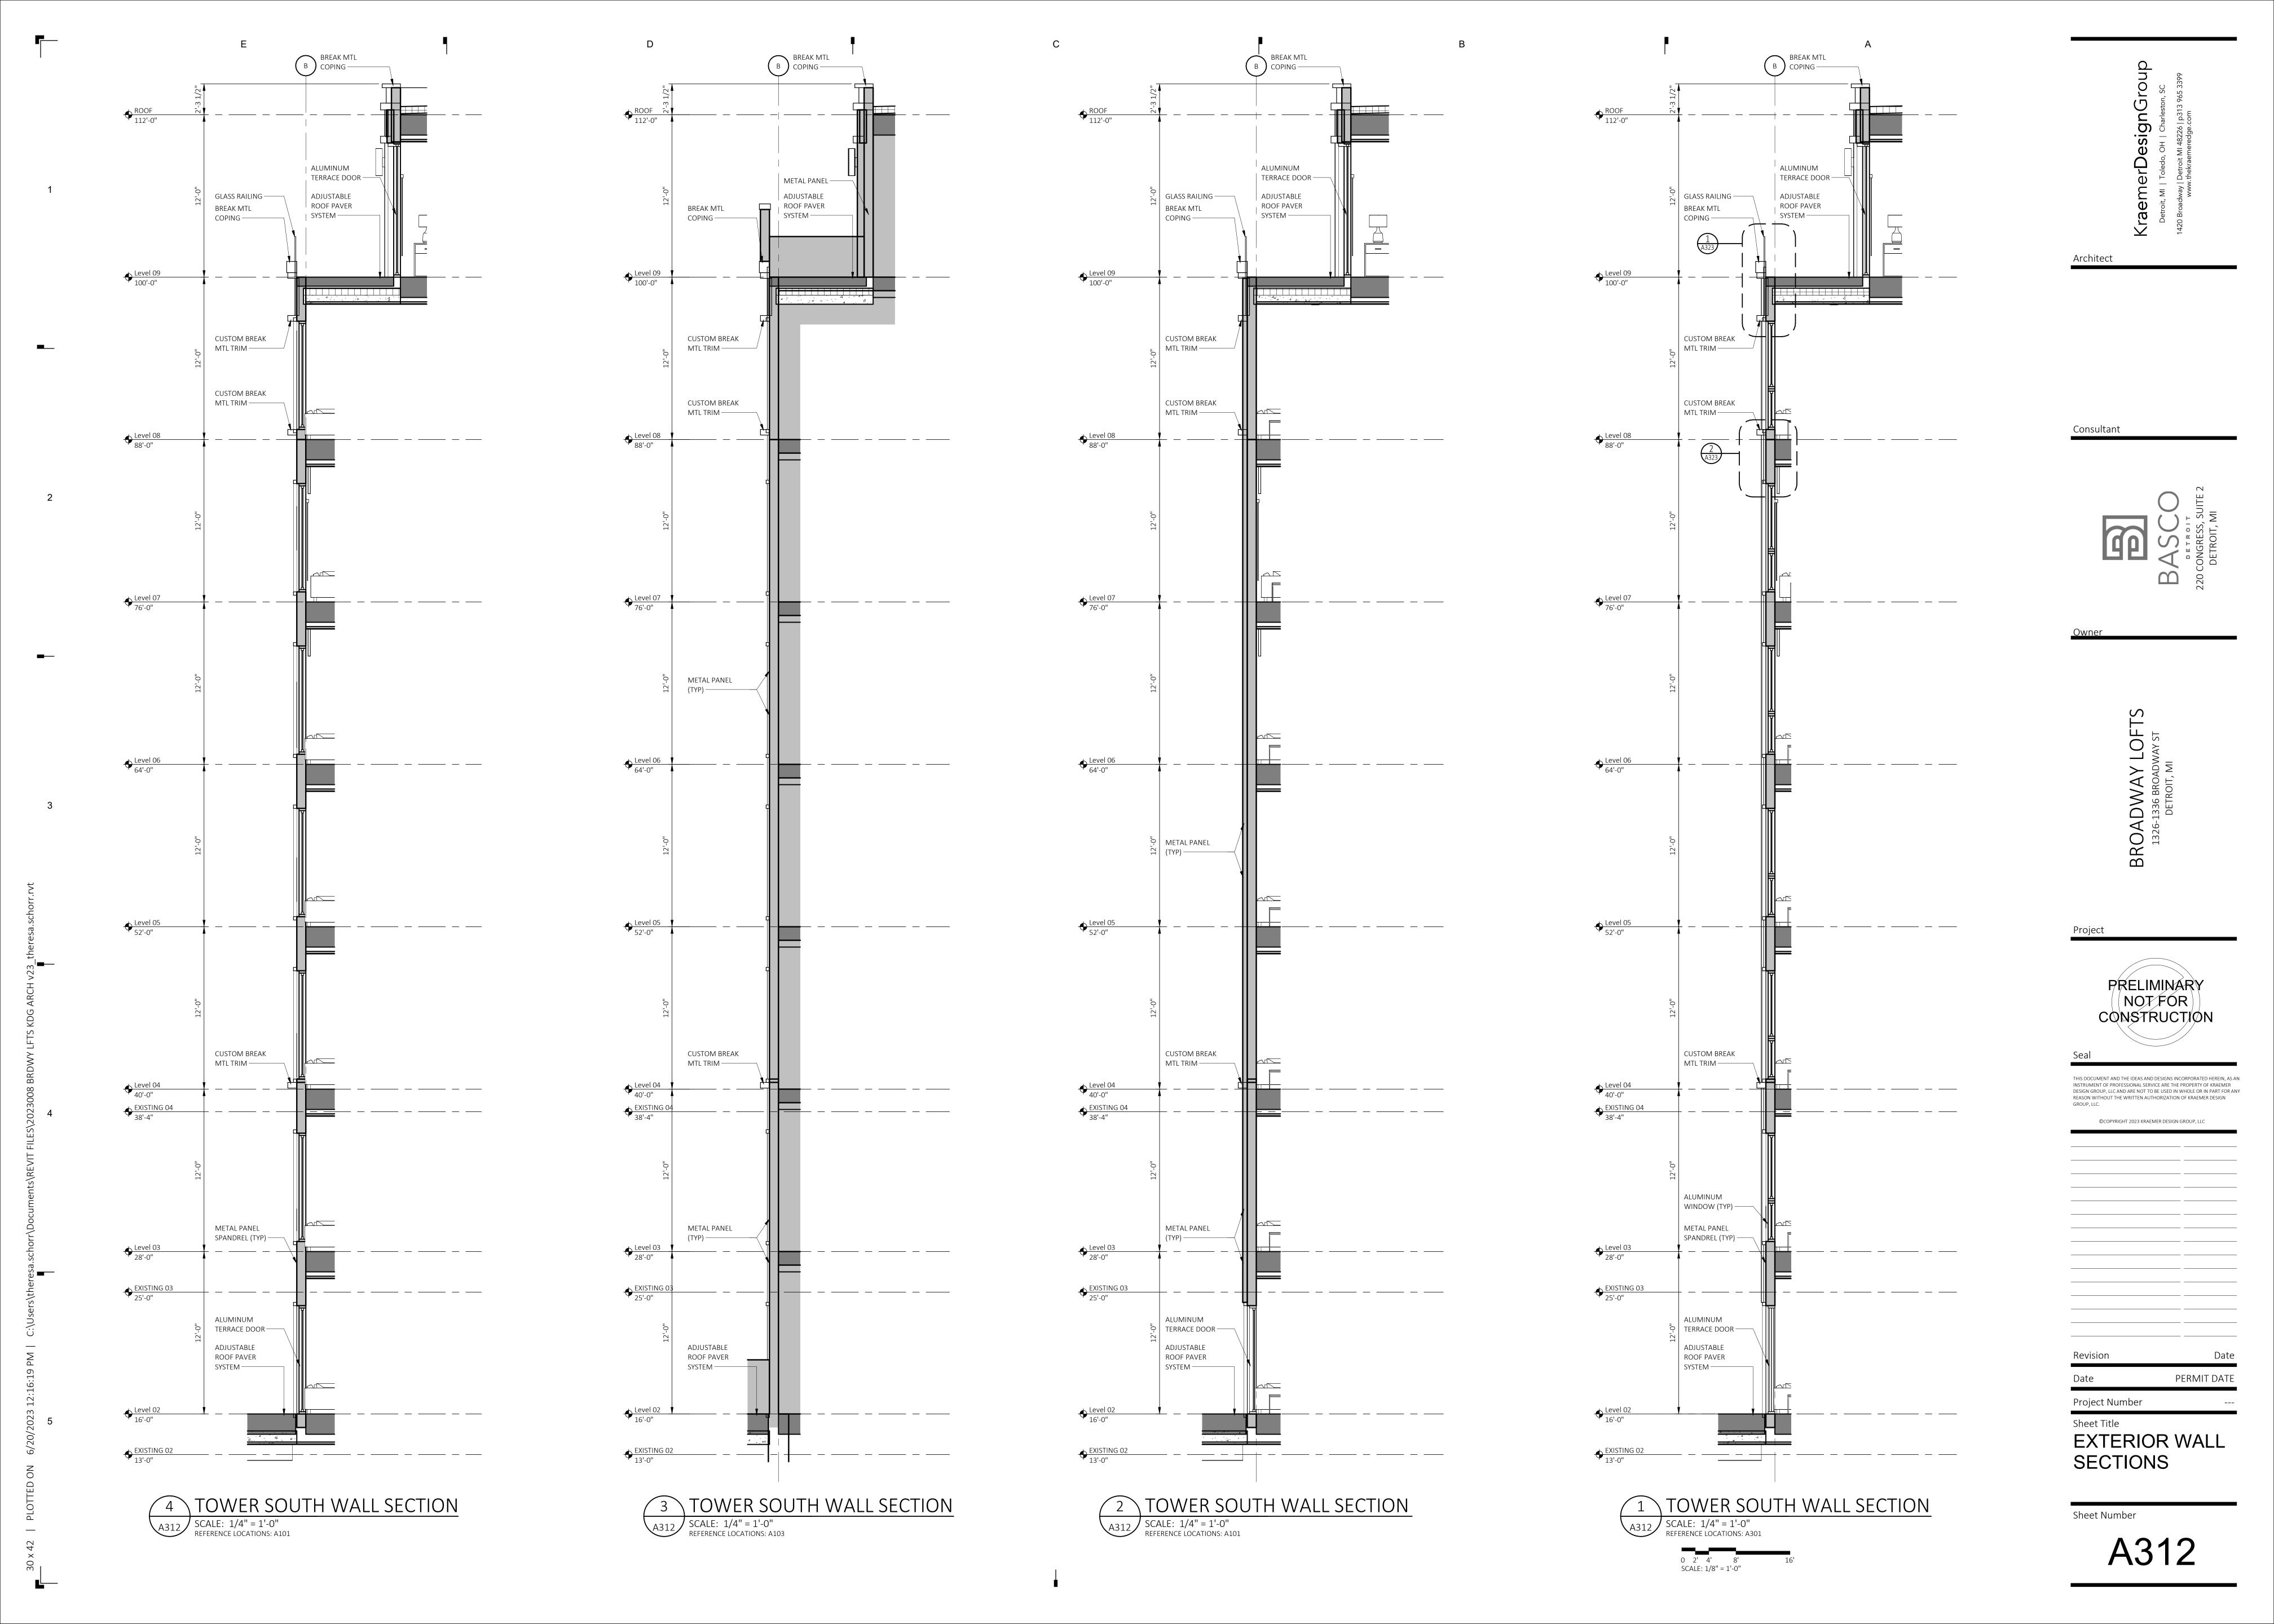
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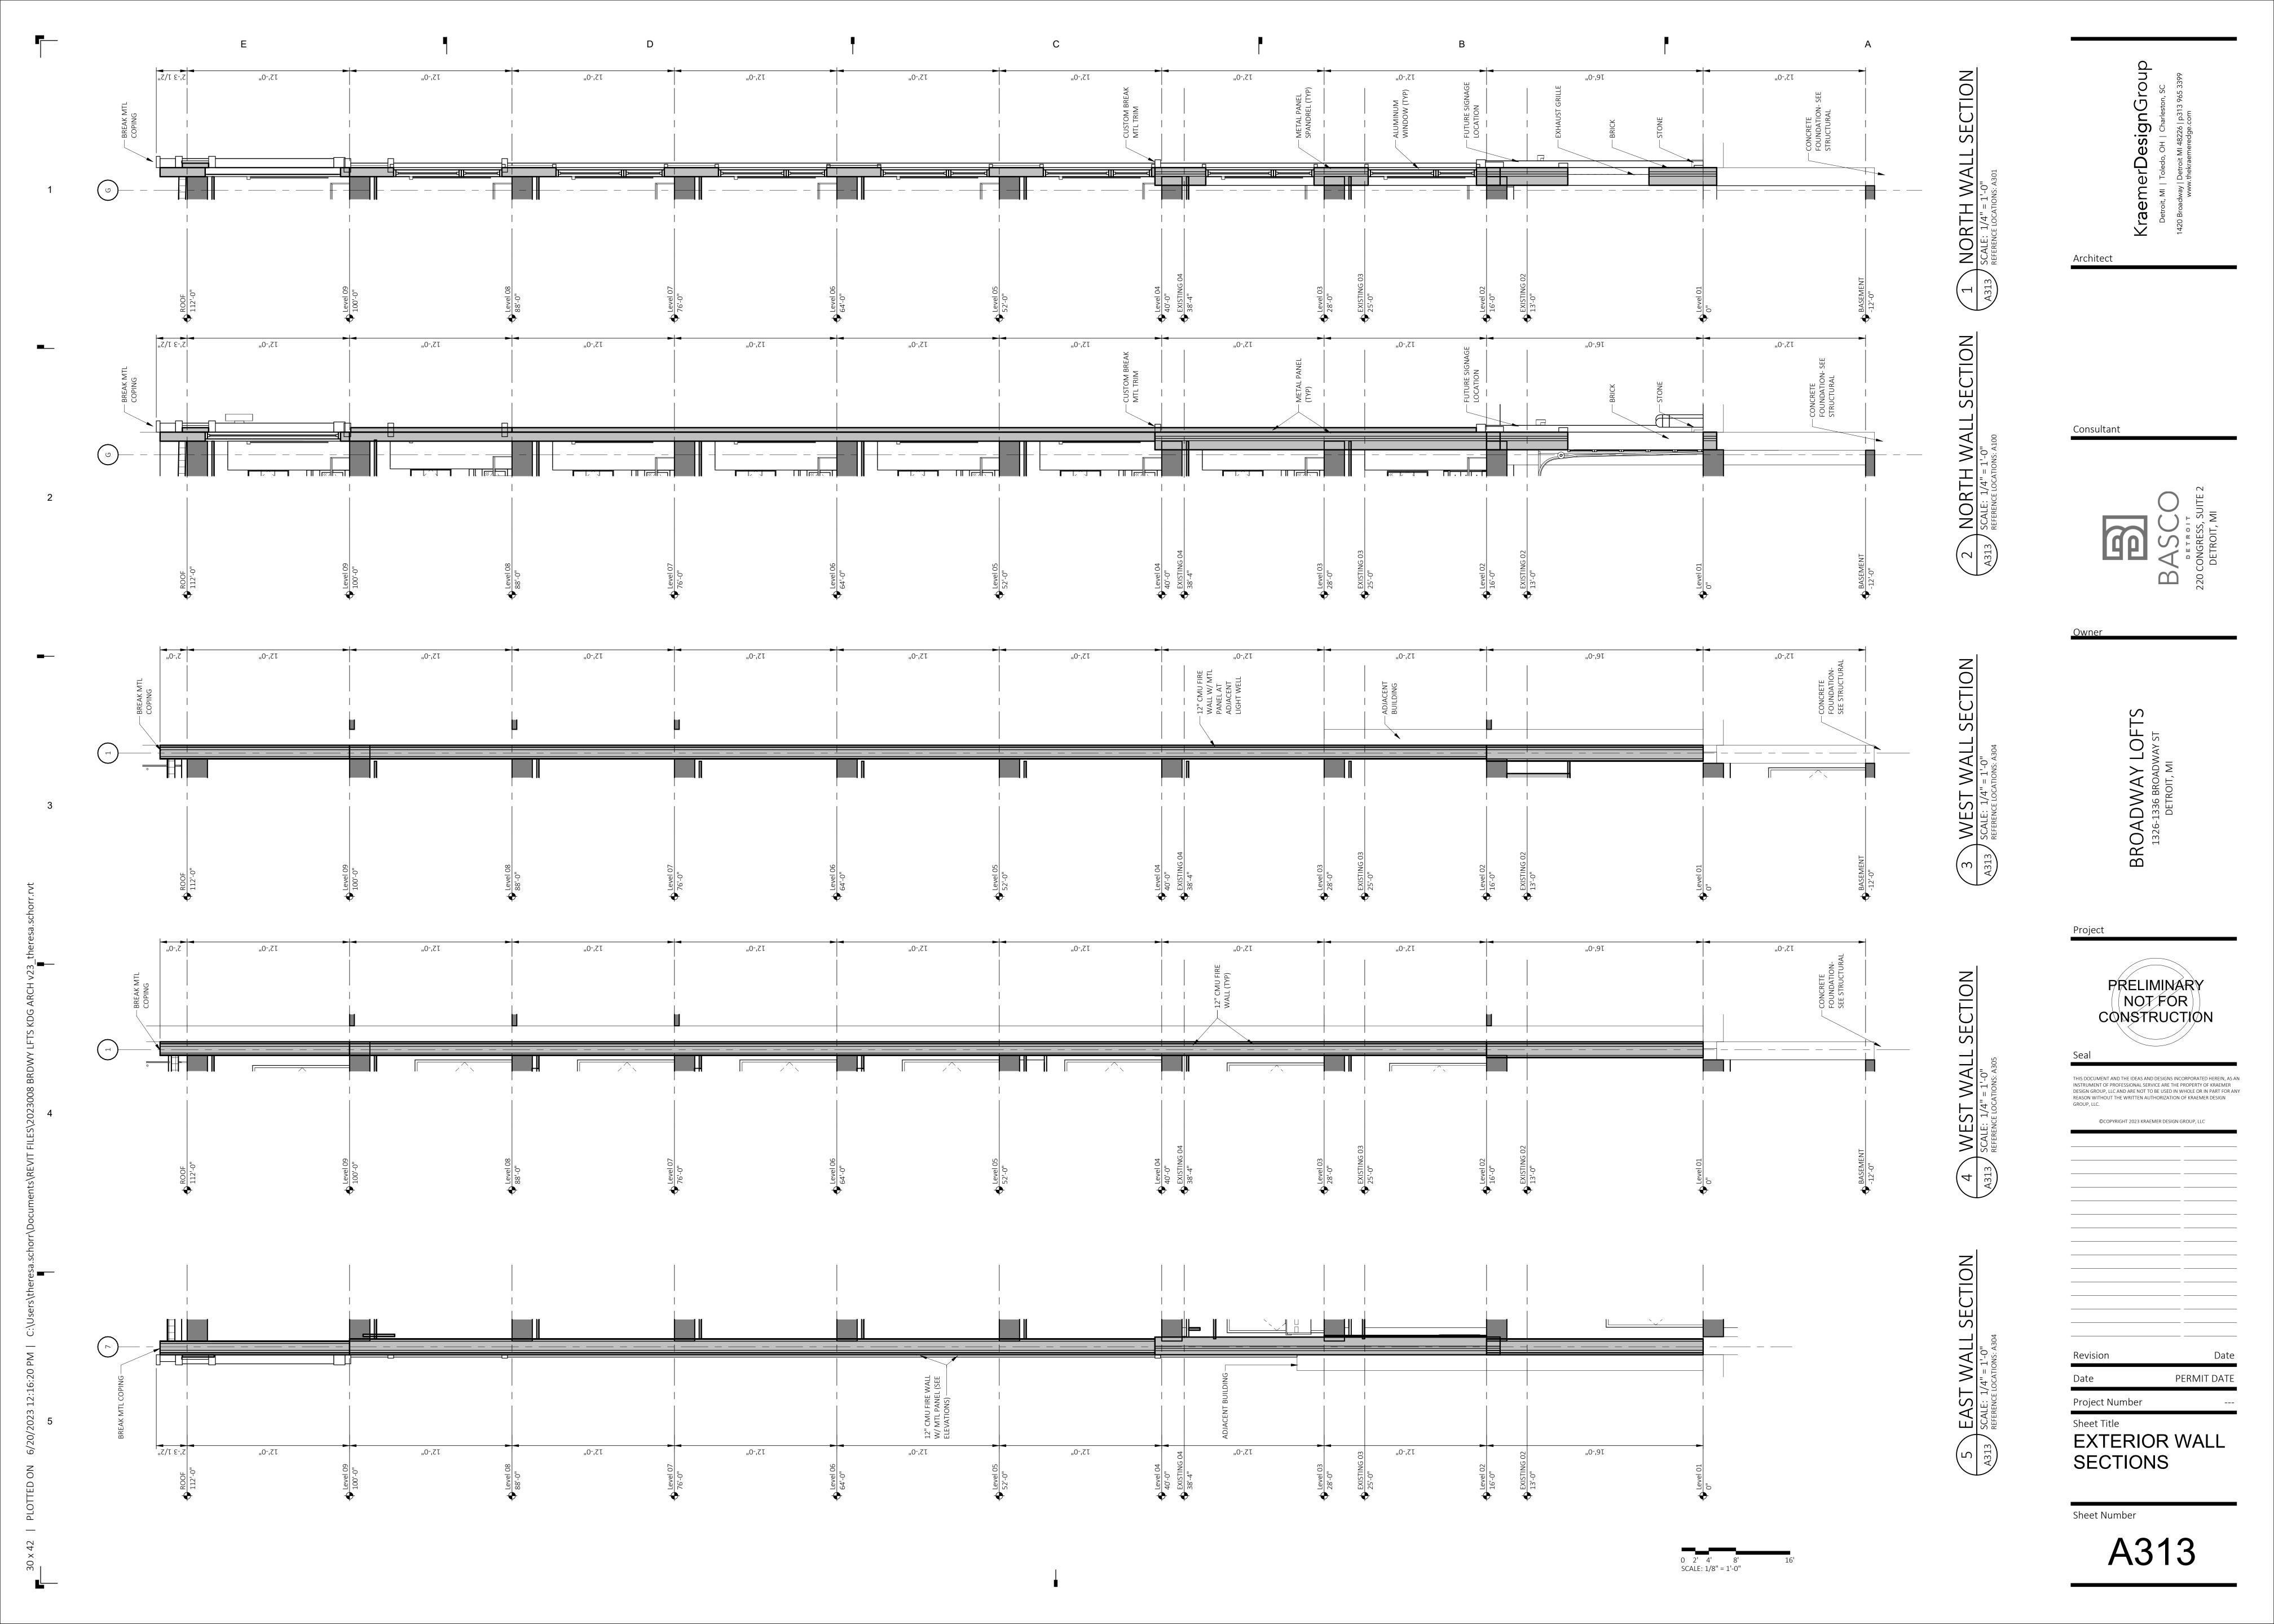
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Sheet Title
EXTERIOR WALL
SECTIONS

Sheet Number






BLOCKING — CONTINUOUS CLEAT COPING -— GLASS RAILING BLOCKING — —— 3" RIGID INSUALTION GYP SHEATHING ON CFMF — GYP SHEATHING FASCIA EXTENDER — ADJUSTABLE ROOF PAVER SYSTEM CUSTOM BREAK MTL TRIM — ELASTOMERIC MEMBRANE ROOFING ON TAPERED ROOF INSULATION MTL-2A

6" CFMF W/ BATT INSULATION — CONCRETE SLAB ON MTL DECKING — ENGINEERED FLOOR CASSETTE GYP SHEATHING -WEATHER BARRIER -3" RIGID INSULATION — VERTICAL SUBGIRT — HORIZONTAL SUBGIRT — BASE TRIM —— CUSTOM BREAK MTL TRIM — ALUMINUM WINDOW —

D




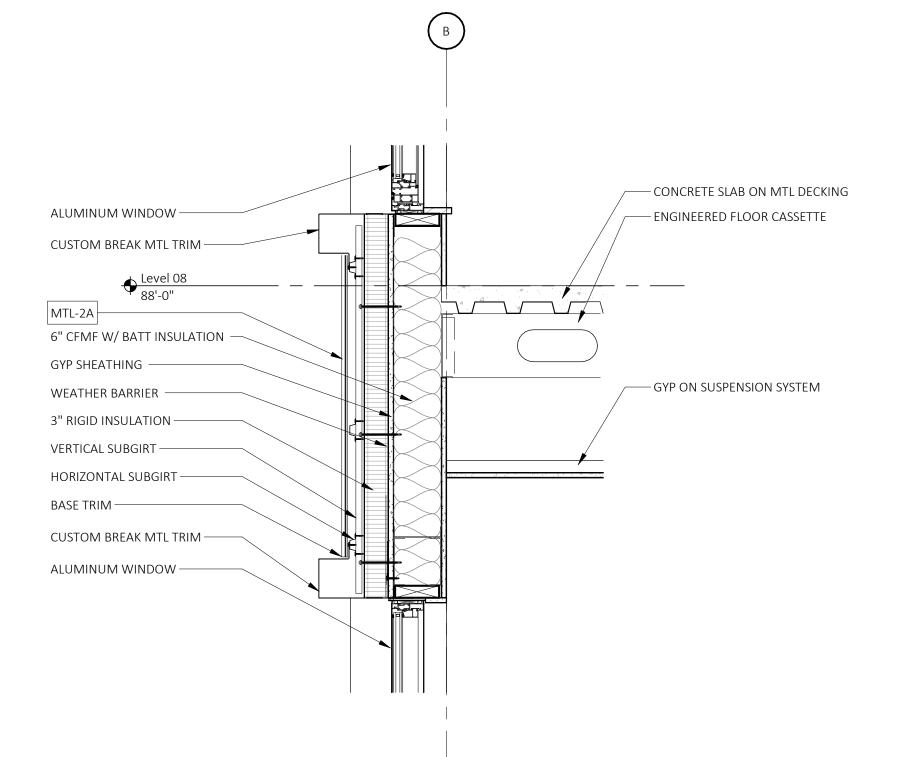

2 TOWER SOUTH WALL TYP SPANDREL A323 SCALE: 1" = 1'-0"
REFERENCE LOCATIONS: A312

Consultant



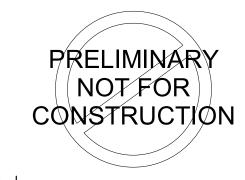

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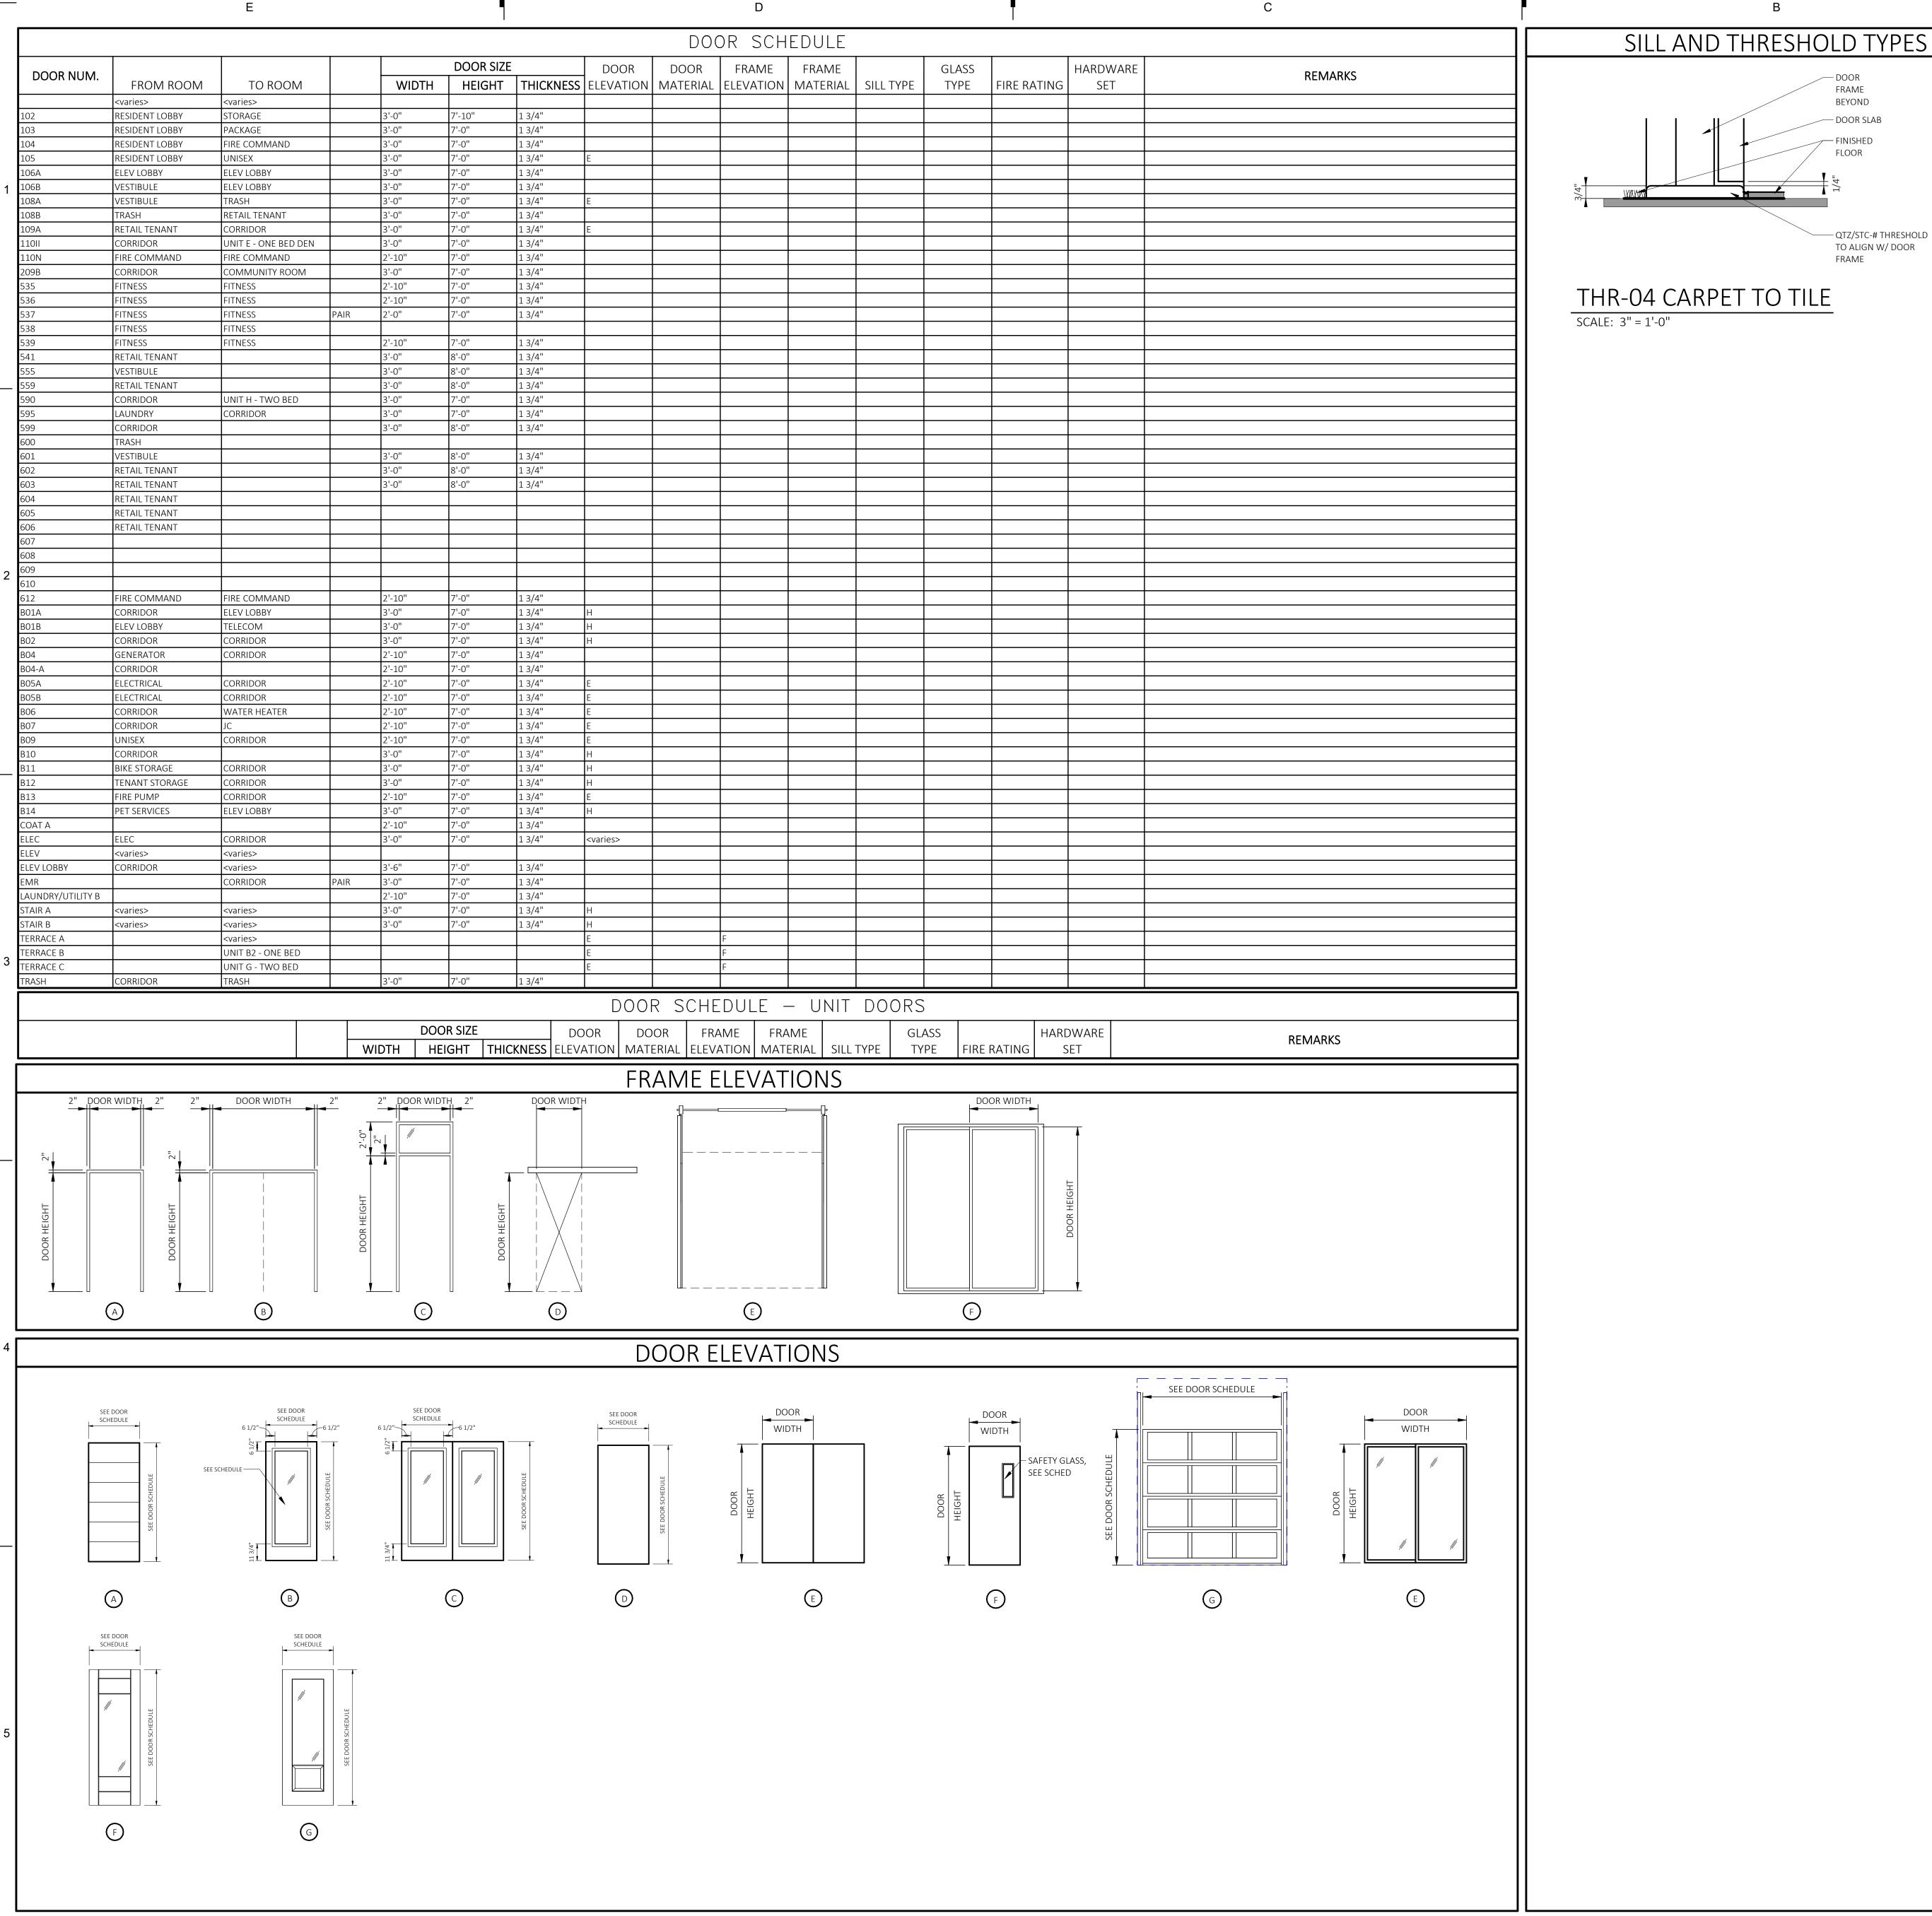
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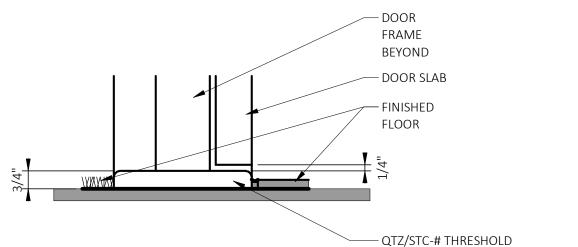
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Project Number

Sheet Title
EXTERIOR PLAN/
WALL DETAILS



GENERAL NOTES



- A DOOR SCHEDULE INDICATES NEW DOORS AND EXISTING DOORS REQUIRING MODIFICATION. CONTRACTOR SHALL COORDINATE THE KEYING OF NEW, REWORKED, AND EXISTING DOOR WITH OWNER'S REQUIREMENTS. ADDITIONAL DOORS DISCOVERED TO REQUIRE MODIFICATION SHALL BE PROMPTLY REPORTED TO ARCHITECT.
- B LOCATE DOOR FRAMES A MINIMUM OF 6" FROM INSIDE CORNER TO DOOR OPENING UNLESS OTHERWISE INDICATED.
- C UNDERCUT DOORS AS REQUIRED TO CLEAR FINISH FLOOR MATERIALS AND TO MAINTAIN FIRE RATING. D DOORS SHALL BE SINGLE SWING. (UNLESS OTHERWISE NOTED)
- E ETR = EXISTING TO REMAIN F SEE ROOM FINISH SCHEDULE FOR FIELD PAINTED/STAINED FINISHES, SEE SPECIFICATIONS FOR FACTORY
- G IN NON-SPRINKLED BUILDINGS, WHERE DOOR SCHEDULE INDICATES RATED DOOR, PROVIDE FIRE-RATED DOOR THAT ALLOWS HEAT TRANSMITTED TO UNEXPOSED SIDE TO EXCEED 650 DEGREES WHERE ASSEMBLY IS NOT ASSOCIATED WITH EXITS AND MEANS OF EGRESS E.G. CORRIDORS, STORAGE, AND BOILER ROOMS. PROVIDE TEMPERATURE-RATED DOORS THAT LIMIT HEAT TRANSMITTED TO 450 DEGREES IN MEANS OF EGRESS INSTALLATIONS E.G. A STAIR DOOR.
- PRE-HUNG WOOD DOOR FRAMES: SET PRE-HUNG WOOD DOOR FRAMES LEVEL AND SQUARE WITHIN DESIGNATION PARTITION. MAKE SPACING BETWEEN JAMBS AND DOOR CONSISTENT ON ALL SIDES. SET FRAME AND HINGES TO ALLOW SUFFICIENT HEIGHT FOR DESIGNATED FLOOR FINISH. MAKE DOOR JAMBS FLUSH WITH FINISHED WALL SURFACES ON BOTH SIDES OF PARTITION. IDEALLY PROJECT BEYOND FINISHED WALL SURFACE BY ABOUT 1/32 OF AN INCH. APPLY SPECIFIED WOOD CASING, COUNTER SINK WITH FASTENERS (NAILS) CONCEALED. SECURELY FASTEN PRE-HUNG FRAME TO WALL FRAMING TO AVOID VIBRATION. PROVIDE SHIMS AT EACH HINGE LOCATION. SPACING OF SHIMS NOT TO EXCEED 24 INCHES.

REMARKS

1 ADD NOTES HERE -- INSERTS DATA ROWS TO ADD MORE NOTES

DOOR MATERIAL LEGEND

CP MD COMPOSITE MOLDED MD SR MDF STILE AND RAIL WD FV WOOD FLUSH VENEER PL FS PLASTIC LAMINATE FLUSH SMOOTH PL FR PLASTIC FIBER REINFORCED

ST PF STEEL PRE-FINISHED ST FS STEEL FLUSH FLUSH SMOOTH ST FE STEEL FLUSH FLUSH EMBOSSED ST DS STEEL DECORATIVE FLUSH SMOOTH

ST DE STEEL DECORATIVE FLUSH EMBOSSED ST AC STEEL ACOUSTIC ST SR STEEL STILE AND RAIL SS FR STAINLESS STEEL SMOOTH

SS FD STAINLESS STEEL DECORATIVE AL PF ALUMINUM PRE-FINISHED AL FL ALUMINUM FLUSH AL SR ALUMINUM STILE AND RAIL

MIRR MIRROR DOOR

GLASS DOORS

GL FL GLASS FRAMELESS

PATIO DOORS CL SW CLAD SWING EXTERIOR CL SL CLAD SLIDING EXTERIOR AL SL ALUMINUM SLIDING EXTERIOR

PRE-HUNG WOOD ALUMINUM WOOD WELDED STEEL KNOCKDOWN STEEL PRE-FINISHED STEEL

GLASS TYPES

IG-1 INSULATED GLASS IG-3 INSULATED SAFETY GLASS CSG FIRELIGHT NT

RCG PYROSTOP FRG FIRE-RATED TEMPERED GLASS FG-1 MONOLITHIC SAFETY GLASS

SEE SPECIFICATIONS

esignGroup


Architect

Consultant



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DOOR/FRAME **ELEVATIONS AND** SCHEDULES

Sheet Number

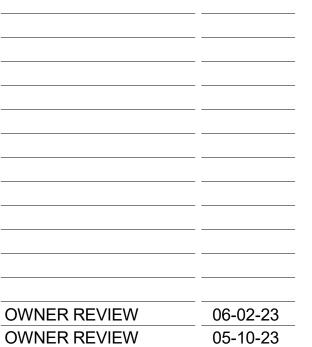TYPE HEIGHT WIDTH FRAME SASH GLASS REMARKS A1 5'-0" 4'-10" AL BRONZE IG-1 IG-1 B1 3'-0" 4'-10" AL BRONZE IG-1 IG-1 C1 8'-0" 3'-10 171/256" AL BRONZE IG-1 IG-1 C2 8'-0" 4'-0" AL BRONZE IG-1 IG-1 C3 8'-0" 4'-10" AL BRONZE IG-1 IG-1 D1 10'-0" 4'-4 1/2" AL BRONZE IG-1 IG-1 D2 10'-0" 4'-10" AL BRONZE IG-1 IG-1 E1 6'-6" 3'-4 1/4" AL BRONZE IG-1 IG-1	A600 - WINDOW SCHEDULE									
A1 5'-0" 4'-10" AL BRONZE IG-1 C1 8'-0" 4'-10" AL BRONZE IG-1 C2 8'-0" 4'-10" AL BRONZE IG-1 C3 8'-0" 4'-10" AL BRONZE IG-1 C1 10'-0" 4'-41/2" AL BRONZE IG-1 C2 10'-0" 4'-10" AL BRONZE IG-1 C3 6'-6" 3'-4 1/4" AL BRONZE IG-1 C4 16-1 C5 16-1 C6 16-1 C7 16-1 C8 16-1 C9 16-1				FRA	FRAME		SASH			
B1 3'-0" 4'-10" AL BRONZE IG-1 C1 8'-0" 3'-10 171/256" AL BRONZE IG-1 C2 8'-0" 4'-0" AL BRONZE IG-1 C3 8'-0" 4'-10" AL BRONZE IG-1 D1 10'-0" 4'-4 1/2" AL BRONZE IG-1 D2 10'-0" 4'-10" AL BRONZE IG-1 E1 6'-6" 3'-4 1/4" AL BRONZE IG-1	TYPE	HEIGHT	WIDTH	MATERIAL	FINISH	MATERIAL	FINISH	GLASS	REMARKS	
C1 8'-0" 3'-10 171/256" AL BRONZE IG-1 C2 8'-0" 4'-0" AL BRONZE IG-1 C3 8'-0" 4'-10" AL BRONZE IG-1 D1 10'-0" 4'-4 1/2" AL BRONZE IG-1 D2 10'-0" 4'-10" AL BRONZE IG-1 E1 6'-6" 3'-4 1/4" AL BRONZE IG-1	A1	5'-0"	4'-10"							
C2 8'-0" 4'-0" AL BRONZE IG-1 C3 8'-0" 4'-10" AL BRONZE IG-1 D1 10'-0" 4'-4 1/2" AL BRONZE IG-1 D2 10'-0" 4'-10" AL BRONZE IG-1 E1 6'-6" 3'-4 1/4" AL BRONZE IG-1	B1	3'-0"	4'-10"	AL	BRONZE			IG-1		
C3 8'-0" 4'-10" AL BRONZE IG-1 D1 10'-0" 4'-4 1/2" AL BRONZE IG-1 D2 10'-0" 4'-10" AL BRONZE IG-1 E1 6'-6" 3'-4 1/4" AL IG-1	C1	8'-0"	3'-10 171/256"	AL	BRONZE			IG-1		
D1 10'-0" 4'-4 1/2" AL BRONZE IG-1 D2 10'-0" 4'-10" AL BRONZE IG-1 E1 6'-6" 3'-4 1/4" AL IG-1	C2	8'-0"	4'-0"	AL	BRONZE			IG-1		
D2 10'-0" 4'-10" AL BRONZE IG-1 E1 6'-6" 3'-4 1/4" AL IG-1	C3	8'-0"	4'-10"	AL	BRONZE			IG-1		
E1 6'-6" 3'-4 1/4" AL IG-1	D1	10'-0"	4'-4 1/2"	AL	BRONZE			IG-1		
	02	10'-0"	4'-10"	AL	BRONZE			IG-1		
-1 7'-Δ" 3'-Θ" ΔΙ IG-1	1	6'-6"	3'-4 1/4"	AL				IG-1		
	1	7'-4"	3'-9"	AL				IG-1		

GENERAL NOTES


- A ALL DIMENSIONS SHALL BE VIF BY CONTRACTOR.
- B COMPLETION OF FACADE RESTORATION AND CLEANING IS RECOMMENDED BEFORE WINDOW INSTALLATION BEGINS. IF FACADE CLEANING OCCURS AFTER WINDOW INSTALLATION/ RESTORATION, NEW WORK SHALL BE PROTECTED SUFFICIENTLY TO AVOID DAMAGE TO FINISHES FROM CLEANING SOLUTIONS.
- C PROVIDED ELEVATIONS ARE FOR REFERENCE ONLY AND FOR BIDDING PURPOSES. FINAL LOCATION AND OPERATION SHALL BE CONFIRMED WITH THE FLOOR PLANS PRIOR TO INSTALLATION.
- D PROVIDE SAFETY GLASS AS REQUIRED BY CODE.

SURFACES/ STRUCTURE ARE SUITABLE FOR WINDOW INSTALLATION.

- E CONTRACTOR TO CONFIRM THAT ALL MATERIALS TO BE REMOVED FOR NEW WINDOW INSTALLATION HAVE BEEN ABATED AS REQUIRED, IF APPLICABLE.
- F NEW WINDOW ASSEMBLIES SHALL BE INSTALLED AT THE SAME DEPTH IN THE ROUGH OPENING FROM THE EXTERIOR FACE OF MASONRY AS THE EXISTING WINDOWS, UNLESS NOTED OTHERWISE.

G ALL EXISTING MATERIALS/ STRUCTURE SHALL BE VERIFIED BY CONTRACTOR TO ENSURE THAT EXISTING

- H PROVIDE BARRIER-FREE HARDWARE AT OPERABLE WINDOWS, INCLUDING ANY EXTENSIONS FOR REQUIRED REACH RANGE, AT LOCATIONS NOTED.
- I ANY WINDOWS REMOVED SHALL HAVE NEW WINDOWS INSTALLED, OR OPENING BOARDED UP, AT END OF EACH WORKDAY.
- J PROVIDE OPENING PROTECTIVES PER SPECIFICATIONS. REFER TO LIFE SAFETY PLANS AND ELEVATIONS FOR RATED WINDOW LOCATIONS AND SPECIFICATIONS FOR WINDOW REQUIREMENTS.
- K AT THE ONSET OF DEMOLITION, REMOVE ONE WINDOW FROM EACH TYPICAL CONDITION AND REVIEW CONDITION OF ROUGH OPENING WITH ARCHITECT AND OWNER TO CONFIRM EXTENTS OF DEMO, CONDITION/REPAIR OF UNDERLYING ROUGH OPENING, AND ANY MITIGATION PRIOR TO COMMENCING WITH FULL WINDOW REMOVAL.
- L PROVIDE SOLID DRW BLOCKING AT JAMBS AND HEADER OF ROUGH OPENING AFTER DEMO OF EXISTING WINDOWS FOR ATTACHMENT OF NEW WINDOW ASSEMBLIES.

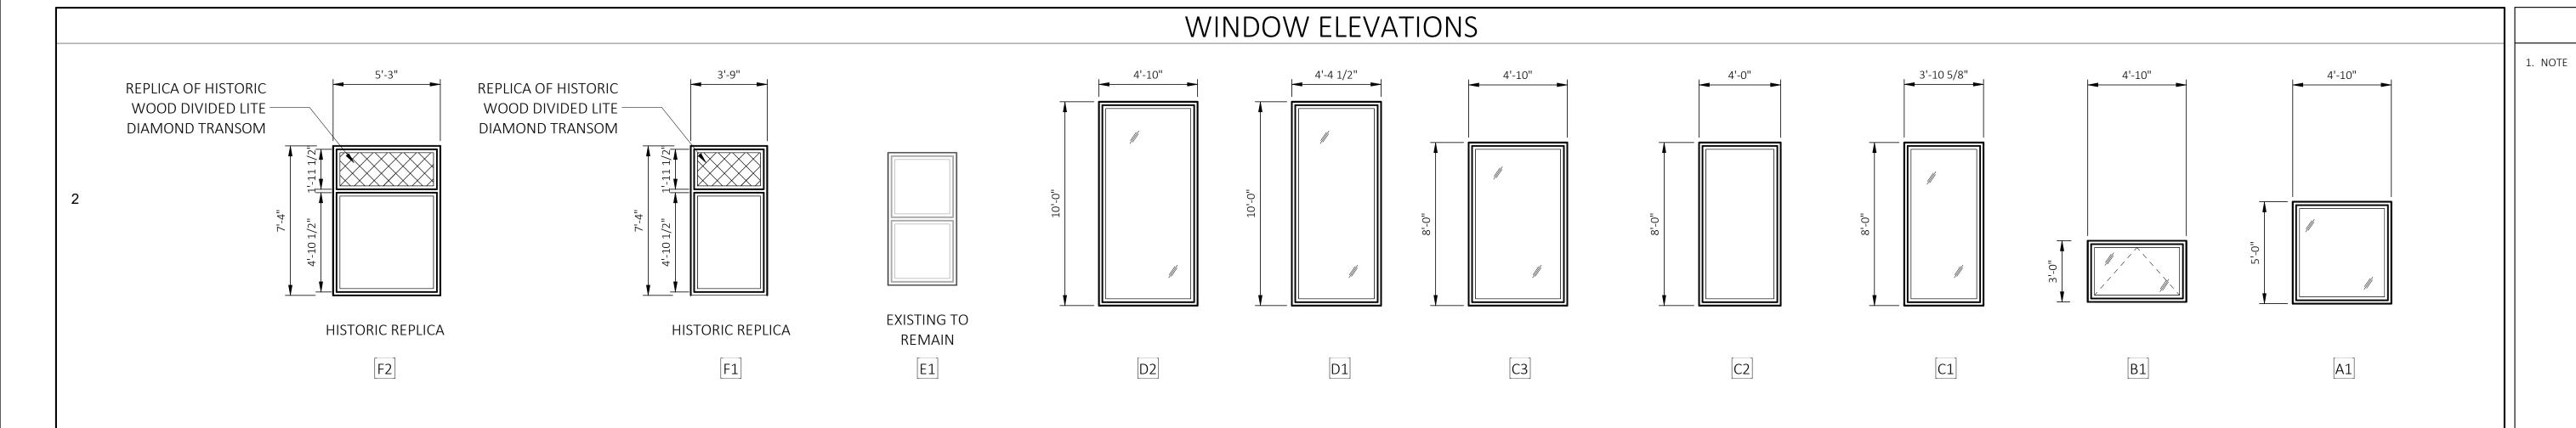

WINDOW DETAILS

REMARKS

Consultant

Architect

Kr<mark>ae</mark>mer<mark>Design</mark>Group

BASCO DETROIT, MI

GLASS TYPES

IG-1 INSULATING GLASS UNITS GL-1 MONOLITHIC GLAZING

(REFER TO SPECIFICATIONS FOR FURTHER INFORMATION ON GLASS TYPES)

BROADWAY LOFTS
1326-1336 BROADWAY ST

Project

MATERIALS LEGEND

AL ALUMINUM
WD WOOD
ST STEEL
FG FIBERGLASS
V VINYL

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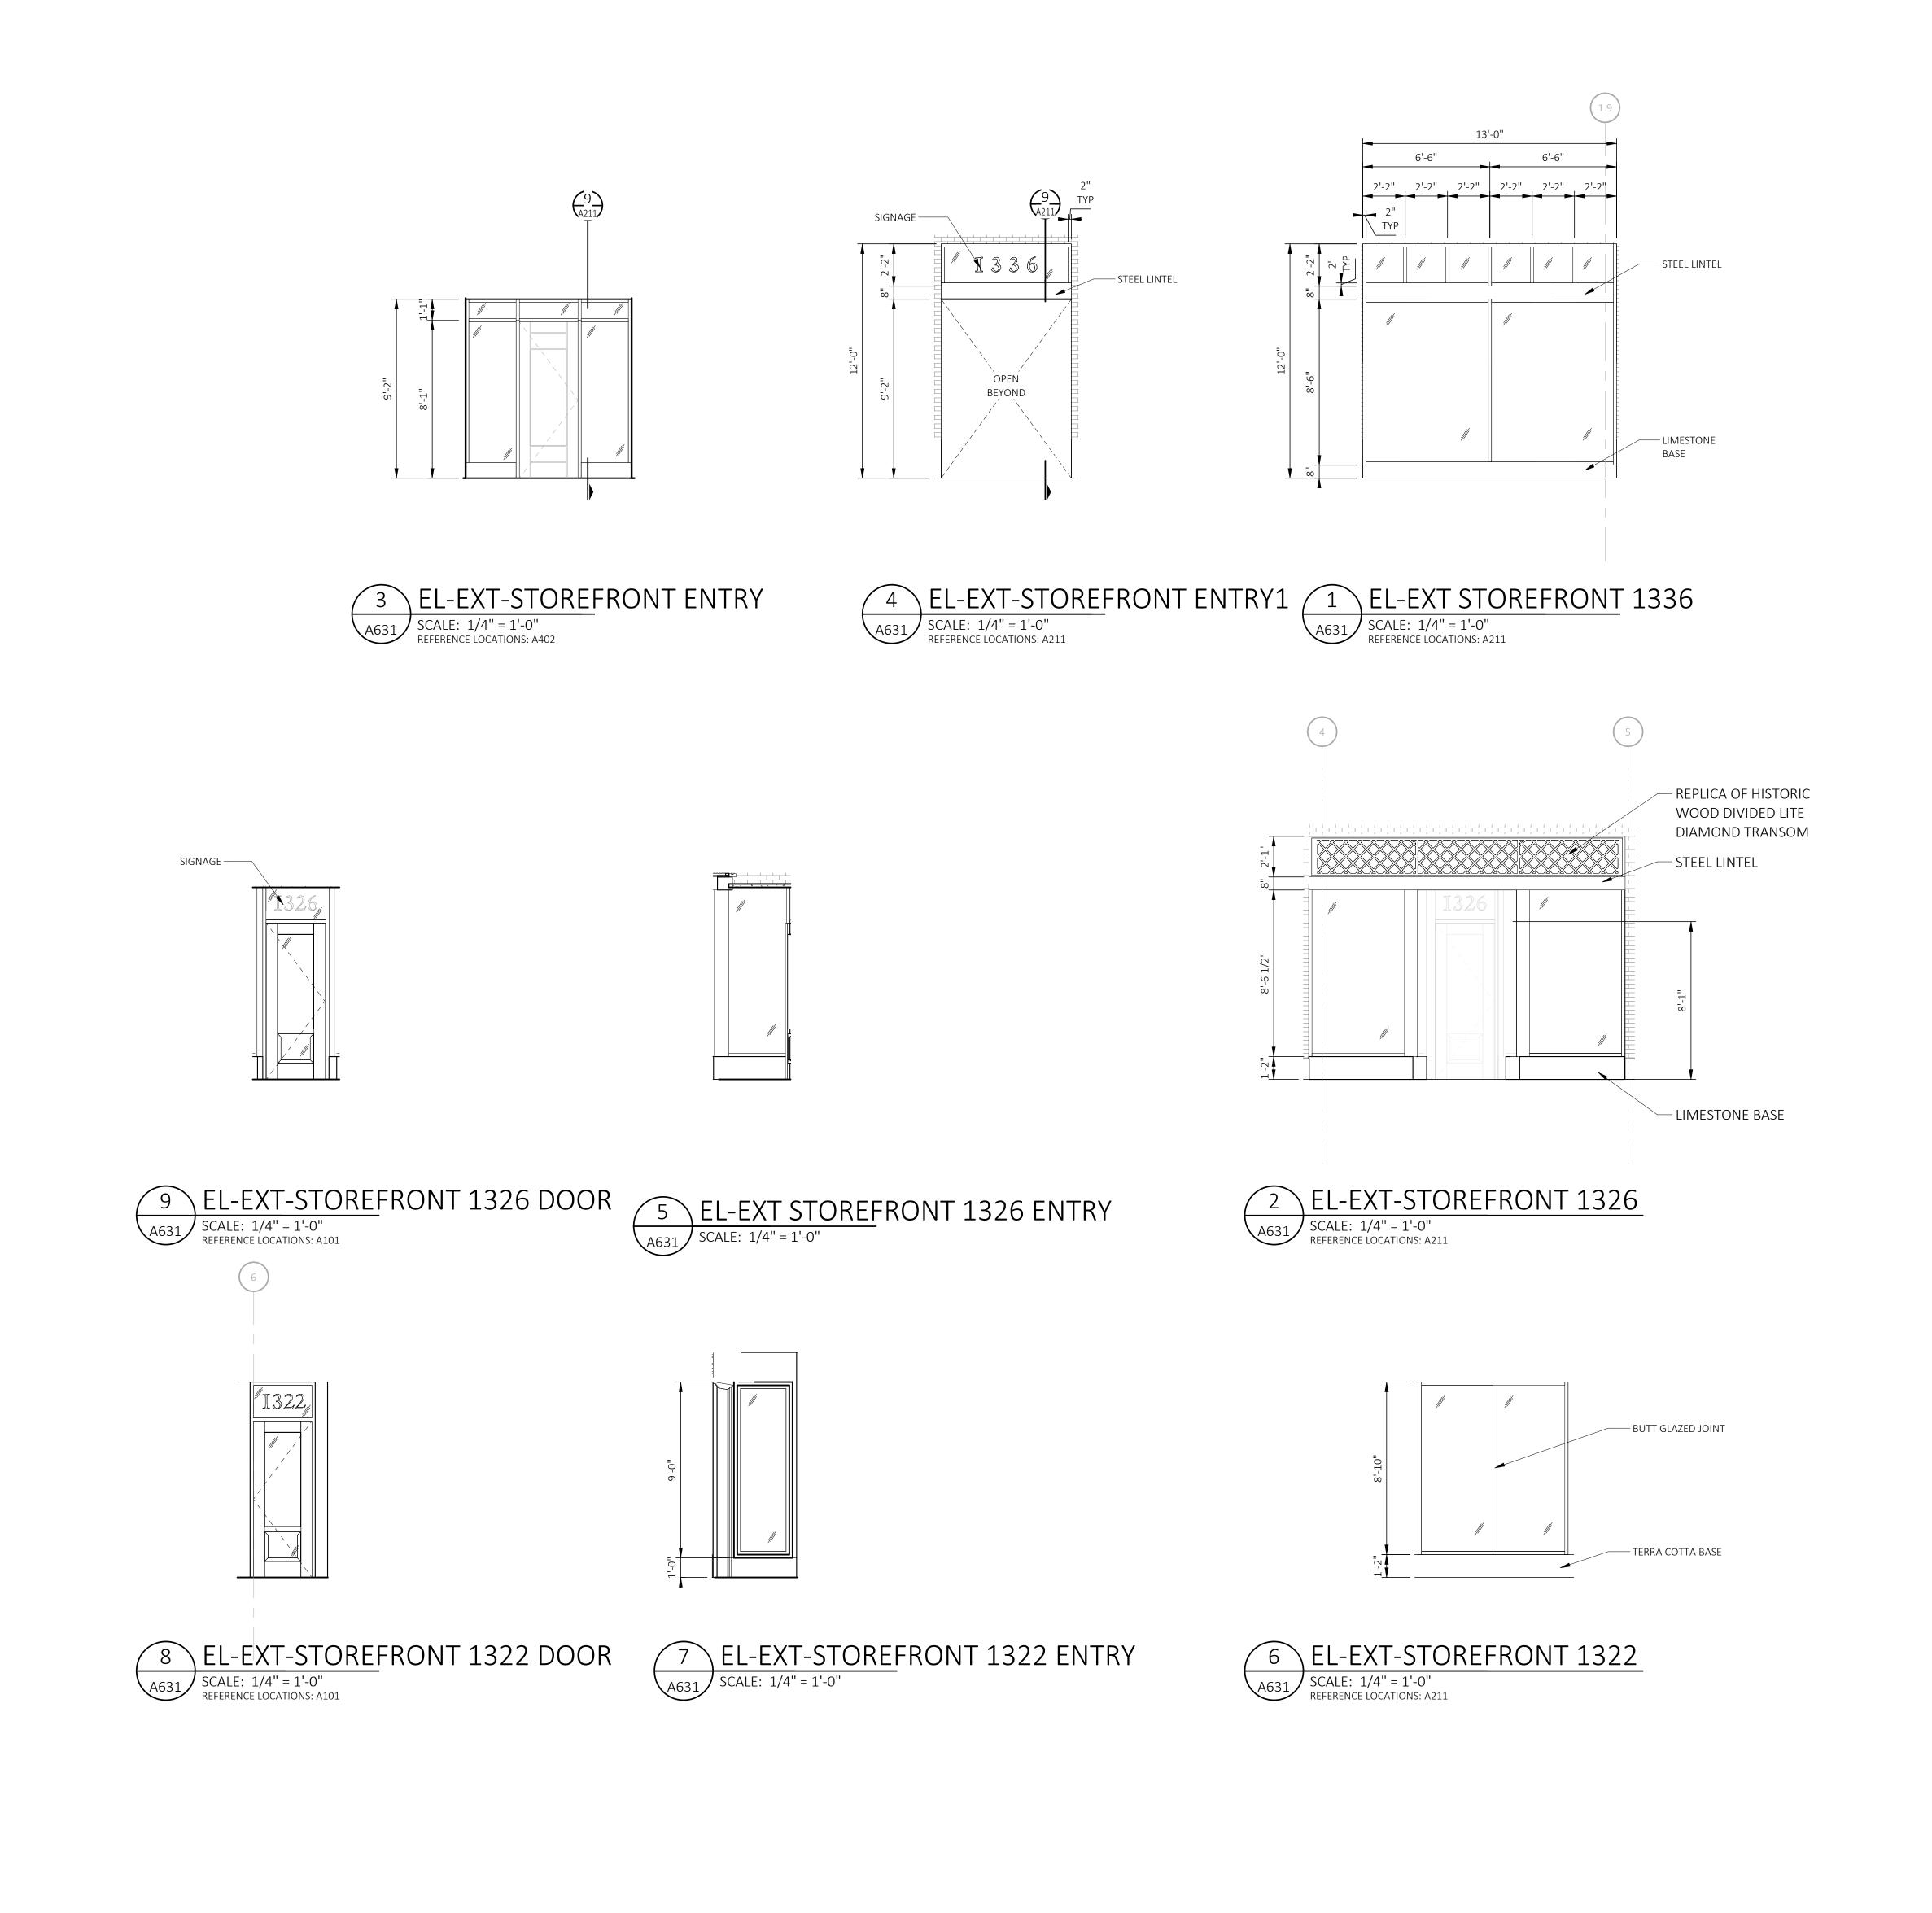
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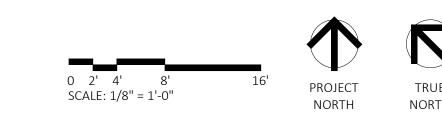
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WINDOW
ELEVATIONS AND

SCHEDULE
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