DHDC 23-8277

APPROVAL DOCUMENT - POST AT WORK LOCATION

CITY OF DETROIT HISTORIC DISTRICT COMMISSION 2 WOODWARD, SUITE 808 DETROIT, MICHIGAN 48226

April 18, 2023

CERTIFICATE OF APPROPRIATENESS

Jonah Raduns-Silverstein, Detroit Sound Conservancy 440 Burroughs St. Ste. 195 Detroit, MI 48202

RE: Application Number 23-8277, 5023 Tireman; Blue Bird Inn Historic District Project Scope: Demolish Addition, Construct Addition, Rehabilitate Facade, Erect Wall Sign

Dear Applicant,

At the regular meeting that was held on April 12, 2023, the Detroit Historic District Commission ("DHDC") reviewed the above-referenced application. Pursuant to Section 5(1) of the Michigan Local Historic District Act, as amended, being MCL 399.205 (1) and Sections 21-2-73/21-2-78 of the 2019 Detroit City Code; the DHDC hereby issues a Certificate of Appropriateness ("COA") for the following work, effective on April 18, 2023, as it meets the Secretary of Interior's Standards for Rehabilitation and the district's Elements of Design:

Demolish existing addition, construct new rear addition, install rooftop HVAC unit, repair plaster façade, repair masonry, repair existing entrance canopy, erect "neon" LED sign, per the submitted documents, drawings, and other submitted materials and specifications.

The COA is issued with the conditions that:

- The removal of any bricks or masonry elements beyond those specified on sheet A20 of the application materials shall be subject to approval by staff.
- The brick veneer to be used on the addition shall be subject to approval by staff.
- Stucco veneer and mural rehabilitation shall be limited to filling existing cracks and voids and repainting with the existing color or colors. Existing material shall not be removed and the painted figures must not be disturbed.
- The final design of the proposed LED "neon" sign, including its color and the locations of its anchors, electrical penetrations, and other supporting elements, shall be subject to approval by staff.
- A full scope of work, subject to approval by staff, shall be provided before any work on the canopy is performed.

Please retain this COA for your files and post it at the subject property until work is complete. It is important to note that approval by the DHDC does not waive the applicant's responsibility to comply with any other applicable ordinances or statutes. If you have any questions regarding the foregoing, please contact staff at 313-224-1762 or hdc@detroitmi.gov.

For the Commission:

Timothy Boscarino, staff

Detroit Historic District Commission

<u>Detroit Sound Conservancy - Blue Bird Inn - Phase 1</u> <u>Historic District Permit Application</u>

Description of existing conditions

The historic Blue Bird Inn currently sits vacant and secure at 5021 Tireman. On the front elevation, the front door is a metal grate and there are glass block windows and one window space is boarded up with plywood. The original historic masonry exists on the front as well as an idiosyncratic mural painted in the 1990s. The masonry and mural are in medium to poor condition. On the rear elevation, two doorways are boarded up with plywood and there is a concrete block addition off the back. That addition has three window openings. The concrete addition is in rather poor but stable condition. The sidewalk in the front and lot in the back his maintained by a community member. The concrete on the sidewalk is in poor condition.

Description of Project

Detroit Sound Conservancy (DSC) seeks to rehabilitate the historic Blue Bird Inn, a birthplace of bebop jazz and a working-class, Black owned and operated bar and hearth at 5021 Tireman on Detroit's Old West Side, into a music venue, gathering space and Detroit's only music archive. Through years of engagement, fundraising and planning DSC is ready for rehabilitation of the property. Though the HDC is only concerned with exterior changes, this rehabilitation will ultimately be both an interior and exterior rehabilitation to allow for programs and gathering on behalf of Detroit's rich musical heritage. As a part of an earlier application to HDC, replacement of the windows and doors on the front elevation has already been approved (#22-7954) thus those changes are not included in this application. This rehabilitation will enact changes on both the front (Tireman) and back (alley) elevations.

On the front elevation, DSC seeks to rehabilitate the current exterior elevation through extensive masonry rehabilitation as well as rehabilitation of the existing mural feature. Some of the windows and the front door will be replaced as well but that work has already been approved. In terms of masonry rehabilitation details can been seen on page A20 and S300 of the attached construction documents as well as in the quote from RAM. As detailed this work will include

- a. Mitigating existing steel beam deterioration, retrofitting may be required.
- b. Retrofitting of loose steel lintel around windows
- c. Retrofitting Masonry sill
- d. Restoring or replacing existing pre-cast coping stones on cornice. As verified by multiple masonry professionals, these stones are likely well beyond repair but the brick face will be salvaged to the highest extent possible.
- e. Removing and replacing existing precast detail stones.
- f. Restoration of existing mural
- g. Patching and masonry across the facade.

Further on the front elevation we will restore the existing marquee canopy to secure from additional damage and reinstall a neon sign that reads "Blue Bird Inn" above the marquee and below the cornice as was represented historically. Installation of this sign will require minor electrical work to be reinstalled as was historically to the sign as well as to power the basic lighting system that exists in the marquee currently. We are also planning to replace some of the crumbled concrete on the large double depth sidewalk in front of the Bird. This will be replaced

<u>Detroit Sound Conservancy - Blue Bird Inn - Phase 1</u> <u>Historic District Permit Application</u>

with standard sidewalk concrete. At a future date, we are planning to install basic seating and gathering space in front of the building but that will likely be included in a later application as the exact plans have not been designed yet. In the future, DSC is interested in pursuing a restoration strategy that would restore the earlier facade paneling system that was in use during the period of significance. If DSC decides this is the best strategy for the building an our organization, we will apply for that specific work at a later date when timelines, budget and preparation allows. For now, DSC's priority is to open the building for community use.

On the west elevation, which exists in the small lot between the adjacent property, basic brick repointing and replacement will need to be done. This will include removing all compromised mortar, rising voids, repointing new mortar and removing and replacing heavily damaged brick and installing new brick.

The south elevation will see the most extensive work that will serve the future use of The Blue Bird Inn. In an effort to fulfill Detroit Sound Consernvancy's mission to serve as a Detroit music's archive, DSC plans to demolish the existing concrete addition of the rear elevation of the building and replace that addition with a larger footprint high volume space with a mezzanine to use as a storage space for the music archive. This new addition will serve the use of the building more more thoroughly as it will allow for ample restroom square footage for the use as well as significant storage space that DSC can use to preserve Detroit music history.

The new addition will extend the entire width of the main building and will comprise two distinct heights to accommodate roof water drainage and interior uses. The west half of the addition will be lower at about 12' high where the main archival space will exist. There will be no windows or doors on this half and there will be a drainage system and gutters that allow for roof water drainage. Further there will be a parapet on the west side elevation to continue and echo the existing parapet on the main building. The east half of the rear addition will be a higher space that will allow for a mezzanine space on the interior for more archival storage and a mechanical room. This half will include a wide storefront door to accommodate egress as well as loading. We will build a small canopy over that door to echo the front of the building as well as a small window on the 2nd floor to accommodate some natural light in the space. Like the west half, there will be a parapet to echo the existing building. The new addition will be built out of CMU blocks with necessary reinforcement. A simple brick veneer will be installed over the CMU block to create a clean presentation and be consistent with the front elevation.

The roof and top elevation will be rehabilitated as is coordinated with the work on both the exterior elevations and on the interior. Further on the rear elevation, the chimney that exists will be repointed and rebuilt if necessary. This work will include recapping the around the retaining wall of the roof, repointing and potentially rebuilding the chimney and finalizing roof work around the new addition. Further, the building HVAC unit will be placed on the rear addition on the 2nd story. Though this will place the HVAC at the highest elevation, this placement is necessary to prioritize the acoustic quality of the interior space for music performance. The Bird was highly sought after as an acoustically pristine venue as such we have to ensure that any potential interference from mechanical or other systems would be put to a minimum. As such the HVAC unit placed far away and on a separate addition from the performance space would be ideal for such a condition. We have done studies to see the visibility from the street and rear and as can be see it will not be an issue from the front elevation as it will not be visible. Further to provide access to the HVAC unit, a roof hatch will be built on the addition.

<u>Detroit Sound Conservancy - Blue Bird Inn - Phase 1</u> <u>Historic District Permit Application</u>

Detailed Scope of Work

- 1. Front (North) Elevation
 - a. Rehabilitation of existing marquee and Reinstall neon sign on front elevation and lights in the existing front elevation marquee
 - b. Masonry Rehabilitation facade and parapet.
 - c. Mural Rehabilitation
 - d. Installation of neon sign in historic location.
 - e. Concrete sidewalk replacement and restoration.
- 2. West (Side) Elevation
 - a. Brick repointing and replacement
- 3. South (Back) Elevation
 - a. Demolish the existing rear addition
 - b. Build the new rear addition. New addition will have two distinct heights and include a wide access door, small marquee and single window.
 - c. Install gutters and other drainage mechanisms.
 - d. Install Electrical hookup attached to the rear of the building.
- 4. Roof Elevation
 - a. Complete roof work as needed in conjunction with interior rehabilitation
 - b. Installation and placement of HVAC unit on roof for interior
 - c. Existing Chimney rehabilitation
 - d. Installation of roof hatch on addition for HVAC access

Current Photographs

Current Photographs Blue Bird Inn.pdf

Historic Exterior Photographs

Historic Photographs Blue Bird Inn.pdf

Architectural Construction Documents

- 2023_DSC_HDC_Construction_Documents_Exterior.pdf
- Blue_Bird_HVAC_Roof_Elevation.pdf

Brochures and Proposals for Work

- Blue Bird Inn 5021 Tireman Detroit MI .pdf
- Blue Bird Inn Exterior Preservation Proposal.pdf
- Lakeside Painting Plaster Repair Quote 1.pdf

RENOVATION OF HISTORIC BLUE BIRD INN

DETROIT SOUND CONSERVANCY



DRAWING INDEX

EXTERIOR ELEVATIONS

BUILDING & WALL SECTIONS

DOOR SCHEDULE & DETAILS
WINDOW SCHEDULE & DETAILS

LOW ROOF FRAMING PLAN
UPPER ROOF FRAMING PLAN

BUILDING & WALL SECTIONS

SPECIAL INSPECTIONS & DESIGN CRITERIA

BUILDING SECTIONS

WALL SECTIONS

EXTERIOR DETAILS

PARTITION TYPES

GENERAL NOTES

FOUNDATION PLAN
MEZZANINE PLAN

BUILDING SECTIONS

FRONT ELEVATION STANDARD DETAILS STANDARD DETAILS

NUMBER SHEET NAME SHEET NAME COVER SHEET LEGEND, SYMBOLS, AND ABBREVIATIONS CODE SHEETS MECHANCIAL DEMOLITION FLOOR PLAN LIFE SAFETY PLANS MECHANICAL NEW WORK FLOOR PLANS ARCHITECTURAL DEMO MECHANICAL NEW WORK ROOF PLAN **DEMOLITION PLAN** MECHANICAL NEW WORK ROOF PLAN ARCHITECTURAL MECHANICAL DETAILS AND DIAGRAMS LEGENDS, SYMBOLS, ABBREVIATIONS MECHANICAL DETAILS AND DIAGRAMS ARCHITECTURAL SITE TEMPERATURE CONTROLS DIAGRAMS ARCHITECTURAL SITE PLAN MECHANICAL SCHEDULES **ARCHITECTURAL MECHANICAL SPECIFICATIONS NEW WORK FLOOR PLANS** M51 MECHANICAL SPECIFICATIONS **PLUMBING** NEW WORK FLOOR PLANS **ROOF PLAN** PLUMBING LEGEND, SYMBOLS, AND ABBREVIATIONS **ROOF PLAN** PLUMBING DEMOLITION FLOOR PLAN PLUMBING NEW WORK UNDERGROUND & FIRST FLOOR REFLECTED CEILING PLAN & DETAILS PLUMBING NEW WORK SCECOND FLOOR & ROOF REFLECTED CEILING PLAN & DETAILS **ENLARGED PLANS & INTERIOR ELEVATIONS** PLUMBING DETAILS AND DIAGRAMS **ENLARGED PLANS & INTERIOR ELEVATIONS** PLUMBING SCHEDULES

P40 PLUMBING SPECIFICATIONS

ELECTRICAL

E00 ELEC. SYMBOLS LIST & LIGHTING SCHEDULE

E11 LEVELS 1 & 2 ELECTRICAL POWER PLANS

E11 LEVELS 1 & 2 ELECTRICAL POWER PLANS
E12 ELECTRICAL ROOF POWER PLAN
E21 LEVELS 1 & 2 ELECTRICAL LIGHTING PLANS
E30 ELEC. ONE-LINE DIAGRAM & PANEL SCHEDULES

QUINN EVANS

4219 WOODWARD AVE SUITE 301 DETROIT, MI 48201

v 313.462.2550

QUINNEVANS.COM





RENOVATION OF HISTORIC BLUE BIRD INN

DETROIT SOUND CONSERVANCY

PROJECT TEAM

QUINN EVANS Architects

4219 WOODWARD AVE SUITE 301 DETROIT, MI 48201 v 313 462 2550

DETROIT, MI 48201 ROYA v 313.462.2550 v 248

ETS ENGINEERING, INC.

ELECTRICAL 418 1/2 S, WASHINGTON AVE ROYAL OAK, MI 48067 v 248.744.0360 METROPOLITAN STRUCTURAL ENGINEERS & ASSOCIATES INC.


STRUCTURAL 422 N ALTADENA ROYAL OAK, MI 48067 v 248.561.2035

SELLINGER ASSOCIATES, INC.

MECHANICAL & PLUMBING 19821 FARMINGTON RD LIVONIA, MI 48152 v 248.482.0045

VICINITY MAPS

STRUCTURAL

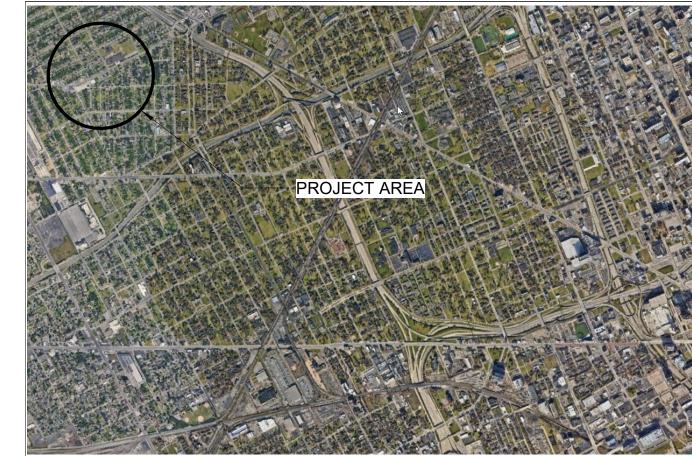




PERMIT / BID SET 03/10/2023

Checker

COVER SHEET

G01

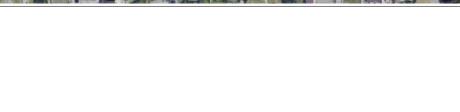






EXISTING CONDITION PHOTOS

LEVEL 1 DEMOLITION PLAN

1/4" = 1'-0" REFERRED FROM: A14

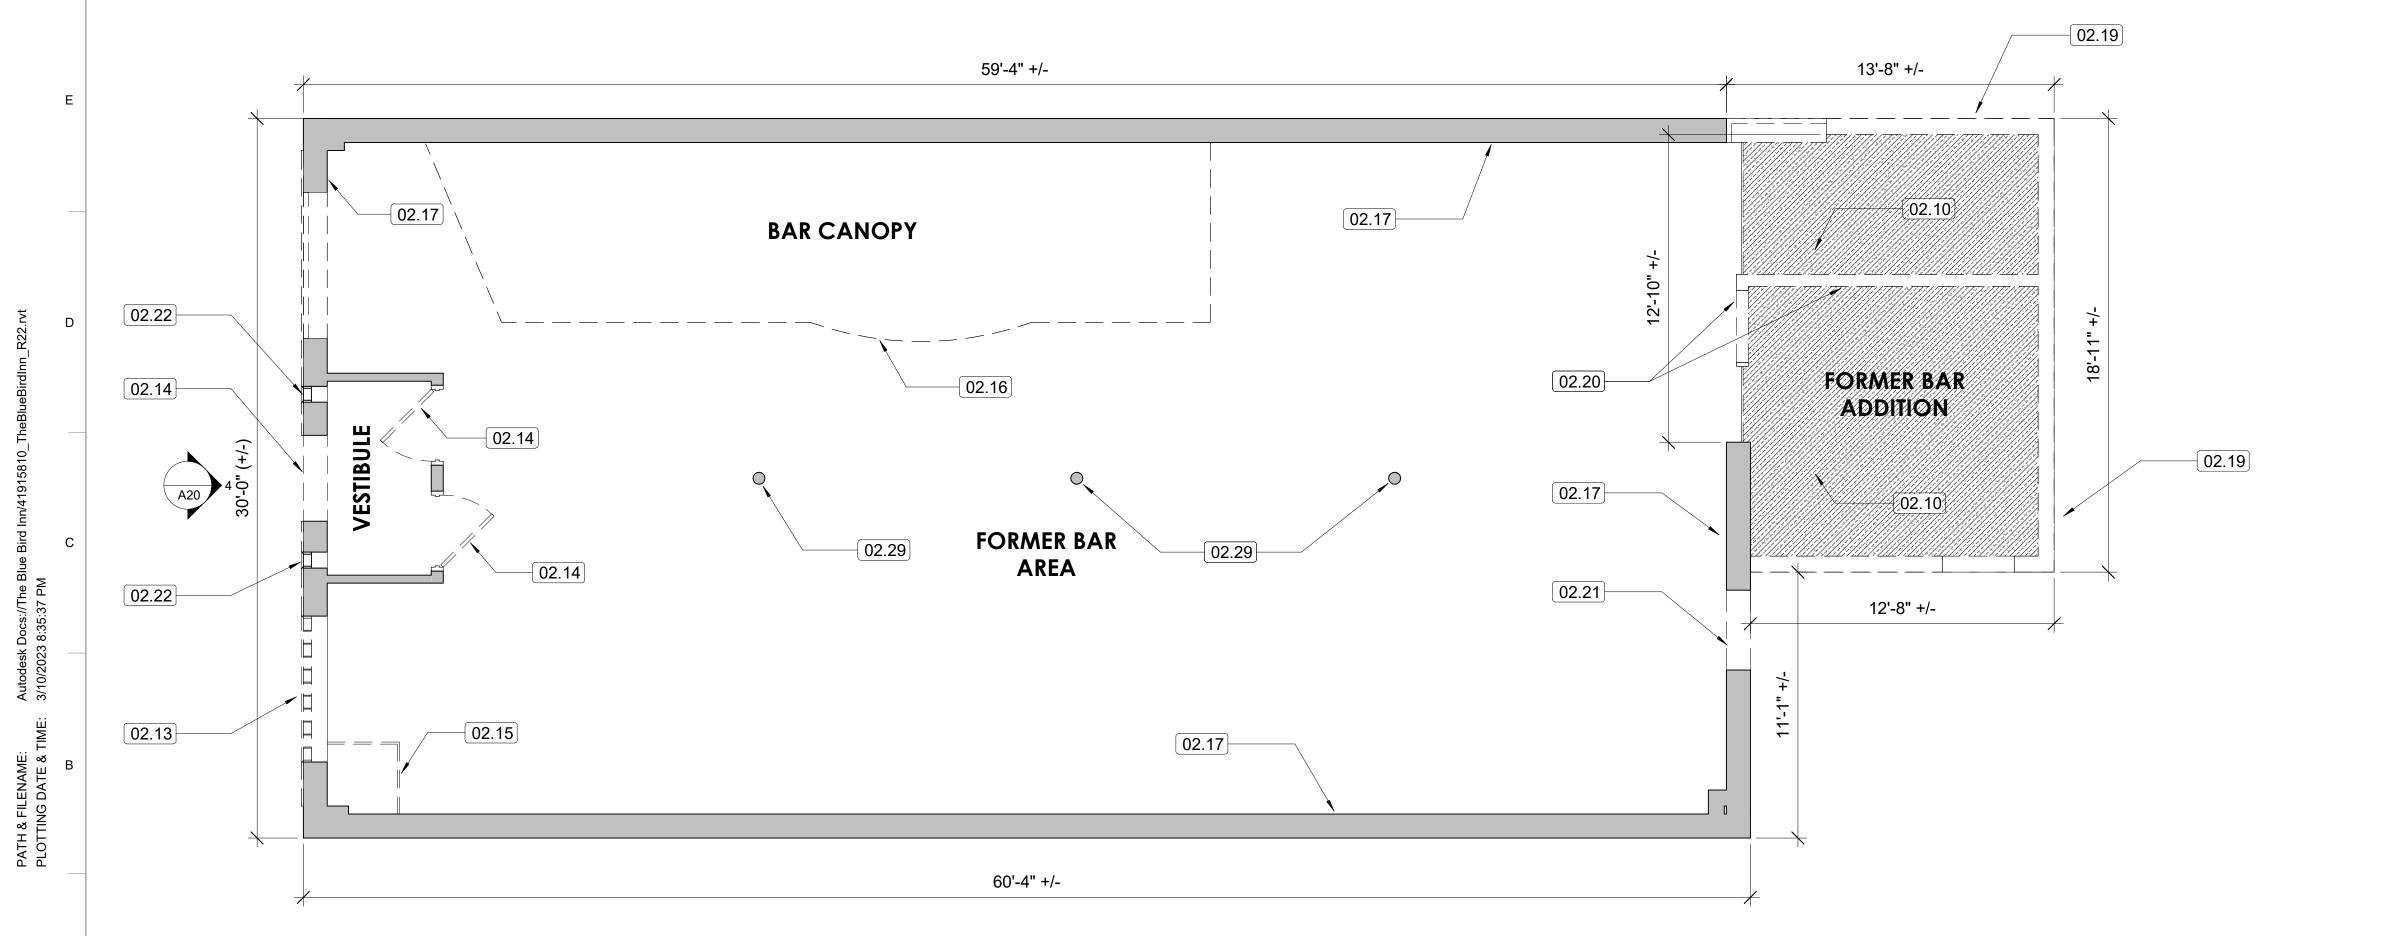

GENERAL NOTES

- 1. THE BLUE BIRD INN IS A BUILDING OF HISTORICAL SIGNIFICANCE. TREAT THE BUILDING RESPECTFULLY. TREAT EXISTING MATERIALS AS IRREPLACEABLE. DO NOT REMOVE, ALTER, DISFIGURE, OR OTHERWISE DAMAGE EXISTING MATERIALS, ELEMENTS, OR FINISHES UNLESS SPECIFICALLY INDICATED HEREIN OR DIRECTED BY THE CONTRACTING OFFICER. PROTECT HISTORIC FINISHES SLATED TO REMAIN FROM DAMAGE.
- 2. PROTECT EXISTING CONDITIONS TO REMAIN, INCLUDING HISTORIC FINISHES SLATED TO REMAIN, FROM DAMAGE. PROVIDE TEMPORARY ENCLOSURES, PROTECTION AND BARRICADES AS NECESSARY TO PROTECT AND SECURE THE BUILDING.
- 3. FOR ALL EXISTING INTERIOR WALLS TO REMAIN, CONTRACTOR SHALL REMOVE FINISHES AS WELL AS ALL ATTACHMENTS AND ACCESSORIES IN PREPERATION FOR A NEW WALL FINISH, INCLUDING BUT NOT LIMITED TO ANCOHRS, CLIPS, BRACKETS, REMNANTS OF CEILING GRID, AND WALL CONDUITS
- 4. VERIFY EXISTING FIELD CONDITIONS AND NOTIFY THE CONTRACTING OFFICER ON INCONSISTENCIES BETWEEN THESE DRAWINGS AND ACTUAL CONDITIONS BEFORE PROCEEDING WITH CONSTRUCTION OR DEMOLITION.
- 5. PROTECT FROM WEATHER ANY OPENING TO THE INTERIOR, EITHER EXISTING OR CREATED DURING DEMOLITION.
- INFORMATION OBTAINED FROM THIS DRAWING PERTAINING TO EXISTING CONDITIONS HAS BEEN OBTAINED FROM GENERAL FIELD OBSERVATIONS AND MAY NOT INDICATE ACTUAL EXISTING CONDITIONS IN DETAIL OR DIMENSION. THE CONTRACTOR IS RESPONSIBLE FOR DETERMINING THE ACTUAL EXISTING CONDITIONS PRIOR TO FABRICATION OR PERFORMANCE OF ANY WORK. SHOULD CONDITIONS BE DISCOVERED THAT PREVENT EXECUTION OF THE WORK AS INDICATED, THE CONTRACTOR SHALL IMMEDIATELY NOTIFY THE ARCHITECT IN WRITING AND AWAIT DIRECTION BEFORE
- PROCEEDING WITH THE WORK.
 ALL ROOMS TO HAVE EXISTING MECHANICAL, ELECTRICAL, AND PLUMBING EQUIPMENT REMOVED.
- FORMER BAR ADDITION TO HAVE EXISTING FLOORING REMOVED PERFORM SURVEY AND ANALYSIS OF EXISTING BUILDING PRIOR TO COMMENCING WITH DEMOLITION OPERATIONS. DO NOT REMOVE CONSTRUCTION IF APPROPRIATE TEMPORARY SUPPORTS ARE IN PLACE. GENERAL CONTRACTOR IS FULLY RESPONSIBLE FOR DESIGN AND INSTALLATION OF ALL NECESSARY SHORING AND BRACING OF
- EXISTING STRUCTURE REQUIRED FOR IMPLEMENTATION OF DESIGN.

 10. REMOVAL OF HAZARDOUS MATERIALS SHALL BE COMPLETED BY A SPECIALIST WITH
- HAZMAT REMEDIATION EXPERIENCE IN HISTORIC BUILDINGS AND STRUCTURES.

 GENERAL CONTRACTORS SHALL COORDINATE ALL DISCONNECTS AND SHUT OFFS THAT MAY BE REQUIRED FOR DEMOLITION.
- REMOVE MECHANICAL/HVAC EQUIPMENT SLATED FOR DEMOLITION INCLUDING ALL ASSOCIATED PIPING, RADIATORS, AND DUCTWORK. REMOVE PIPING BACK TO SERVICE ENTRY POINT/METER. COORDINATE EXTENT WITH MECHANICAL/PLUMBING DEMOLITION DRAWINGS
- 13. EXPOSED STRUCTURE TO BE INSPECTED AND REPAIRED AS REQUIRED.
 14. DEMOLISH ALL UNUSED ROOF AND SOFFIT PENETRATING AND MOUNTED ITEMS SUCH AS,
- BUT NOT LIMITED TO, WIRING, CONDUIT, PIPES, ELECTRICAL BOXES, ETC.

 15. INSPECT CONDITION OF EXISTING CEILING JOISTS. IF UNREPAIRABLE DETERIORATION OR DAMAGE IS OBSERVED, IMMEDIATELY INFORM THE PROJECT ENGINEER IN WRITING AND OBTAIN WRITTEN RESPONSE PRIOR TO PROCEEDING WITH DEMOLITION IN THE
- AFFECTED AREA, UNLESS IMMEDIATE STABILIZATION IS NEEDED.


 16. REFER TO GENERAL NOTES S-001 FOR ADDITIONAL STRUCTURAL INFO.

VALUE



QUINNEVANS.COM



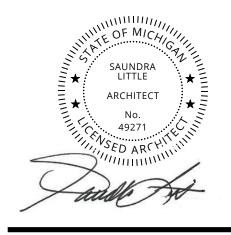

RENOVATION OF HISTORIC BLUE BIRD INN

DETROIT SOUND CONSERVANCY

DEMOLITION LEGEND

KEYNOTES

02.10 REMOVE ALL FLOORING AND FLOOR

02.13 REMOVE EXISTING GLASS BLOCK

02.15 REMOVE EXISTING METERS AND

02.16 REMOVE EXISTING OVERHEAD BAR

02.17 STRIP DOWN INTERIOR WALLS TO

02.19 REMOVE EXISTING EXTERIOR CMU

02.20 REMOVE EXISTING STUD PARTITION

02.21 REMOVE EXISTING DOOR TRIM TO

02.22 EXISTING GLASS BLOCK TO REMAIN02.29 REMOVE EXISTING COLUMN. SEE

STRUCTURAL SHEETS FOR ADDITIONAL SCOPE (TYP.)

PREP FOR CMU INFILL

02.14 REMOVE EXISTING DOOR

EXISTING MASONRY

WINDOW

WALLS

ENCLOSURE


TEXT

EXISTING CONSTRUCTION TO REMAIN



EXISTING DOOR TO REMAIN

ITEM / CONSTRUCTION TO BE REMOVED, SALVAGED OR REINSTALLED

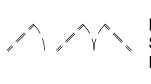

DOOR TO BE REMOVED, SALVAGED OR REINSTALLED



EXTENT OF SLAB/FLOOR REMOVAL 03/10/2023

DEMOLITION PLAN

PERMIT / BID SET

1/4" = 1' - 0" SCALE OF FEET

DRAWN BY:

KP/LH/SR

PROJECT MANAGER:

Description

AD01







RENOVATION OF HISTORIC BLUE BIRD INN

DETROIT SOUND CONSERVANCY 5021 TIREMAN AVENUE DETROIT, MI 48204

30' 20' 10' 0" 20' 30'

SCALE OF FEET

1" = 20'-0"

No. Date Description


PROJECT MANAGER: DRAWN BY:

KP/LH/SR

PERMIT / BID SET 03/10/2023

ARCHITECTURAL SITE PLAN

AS01

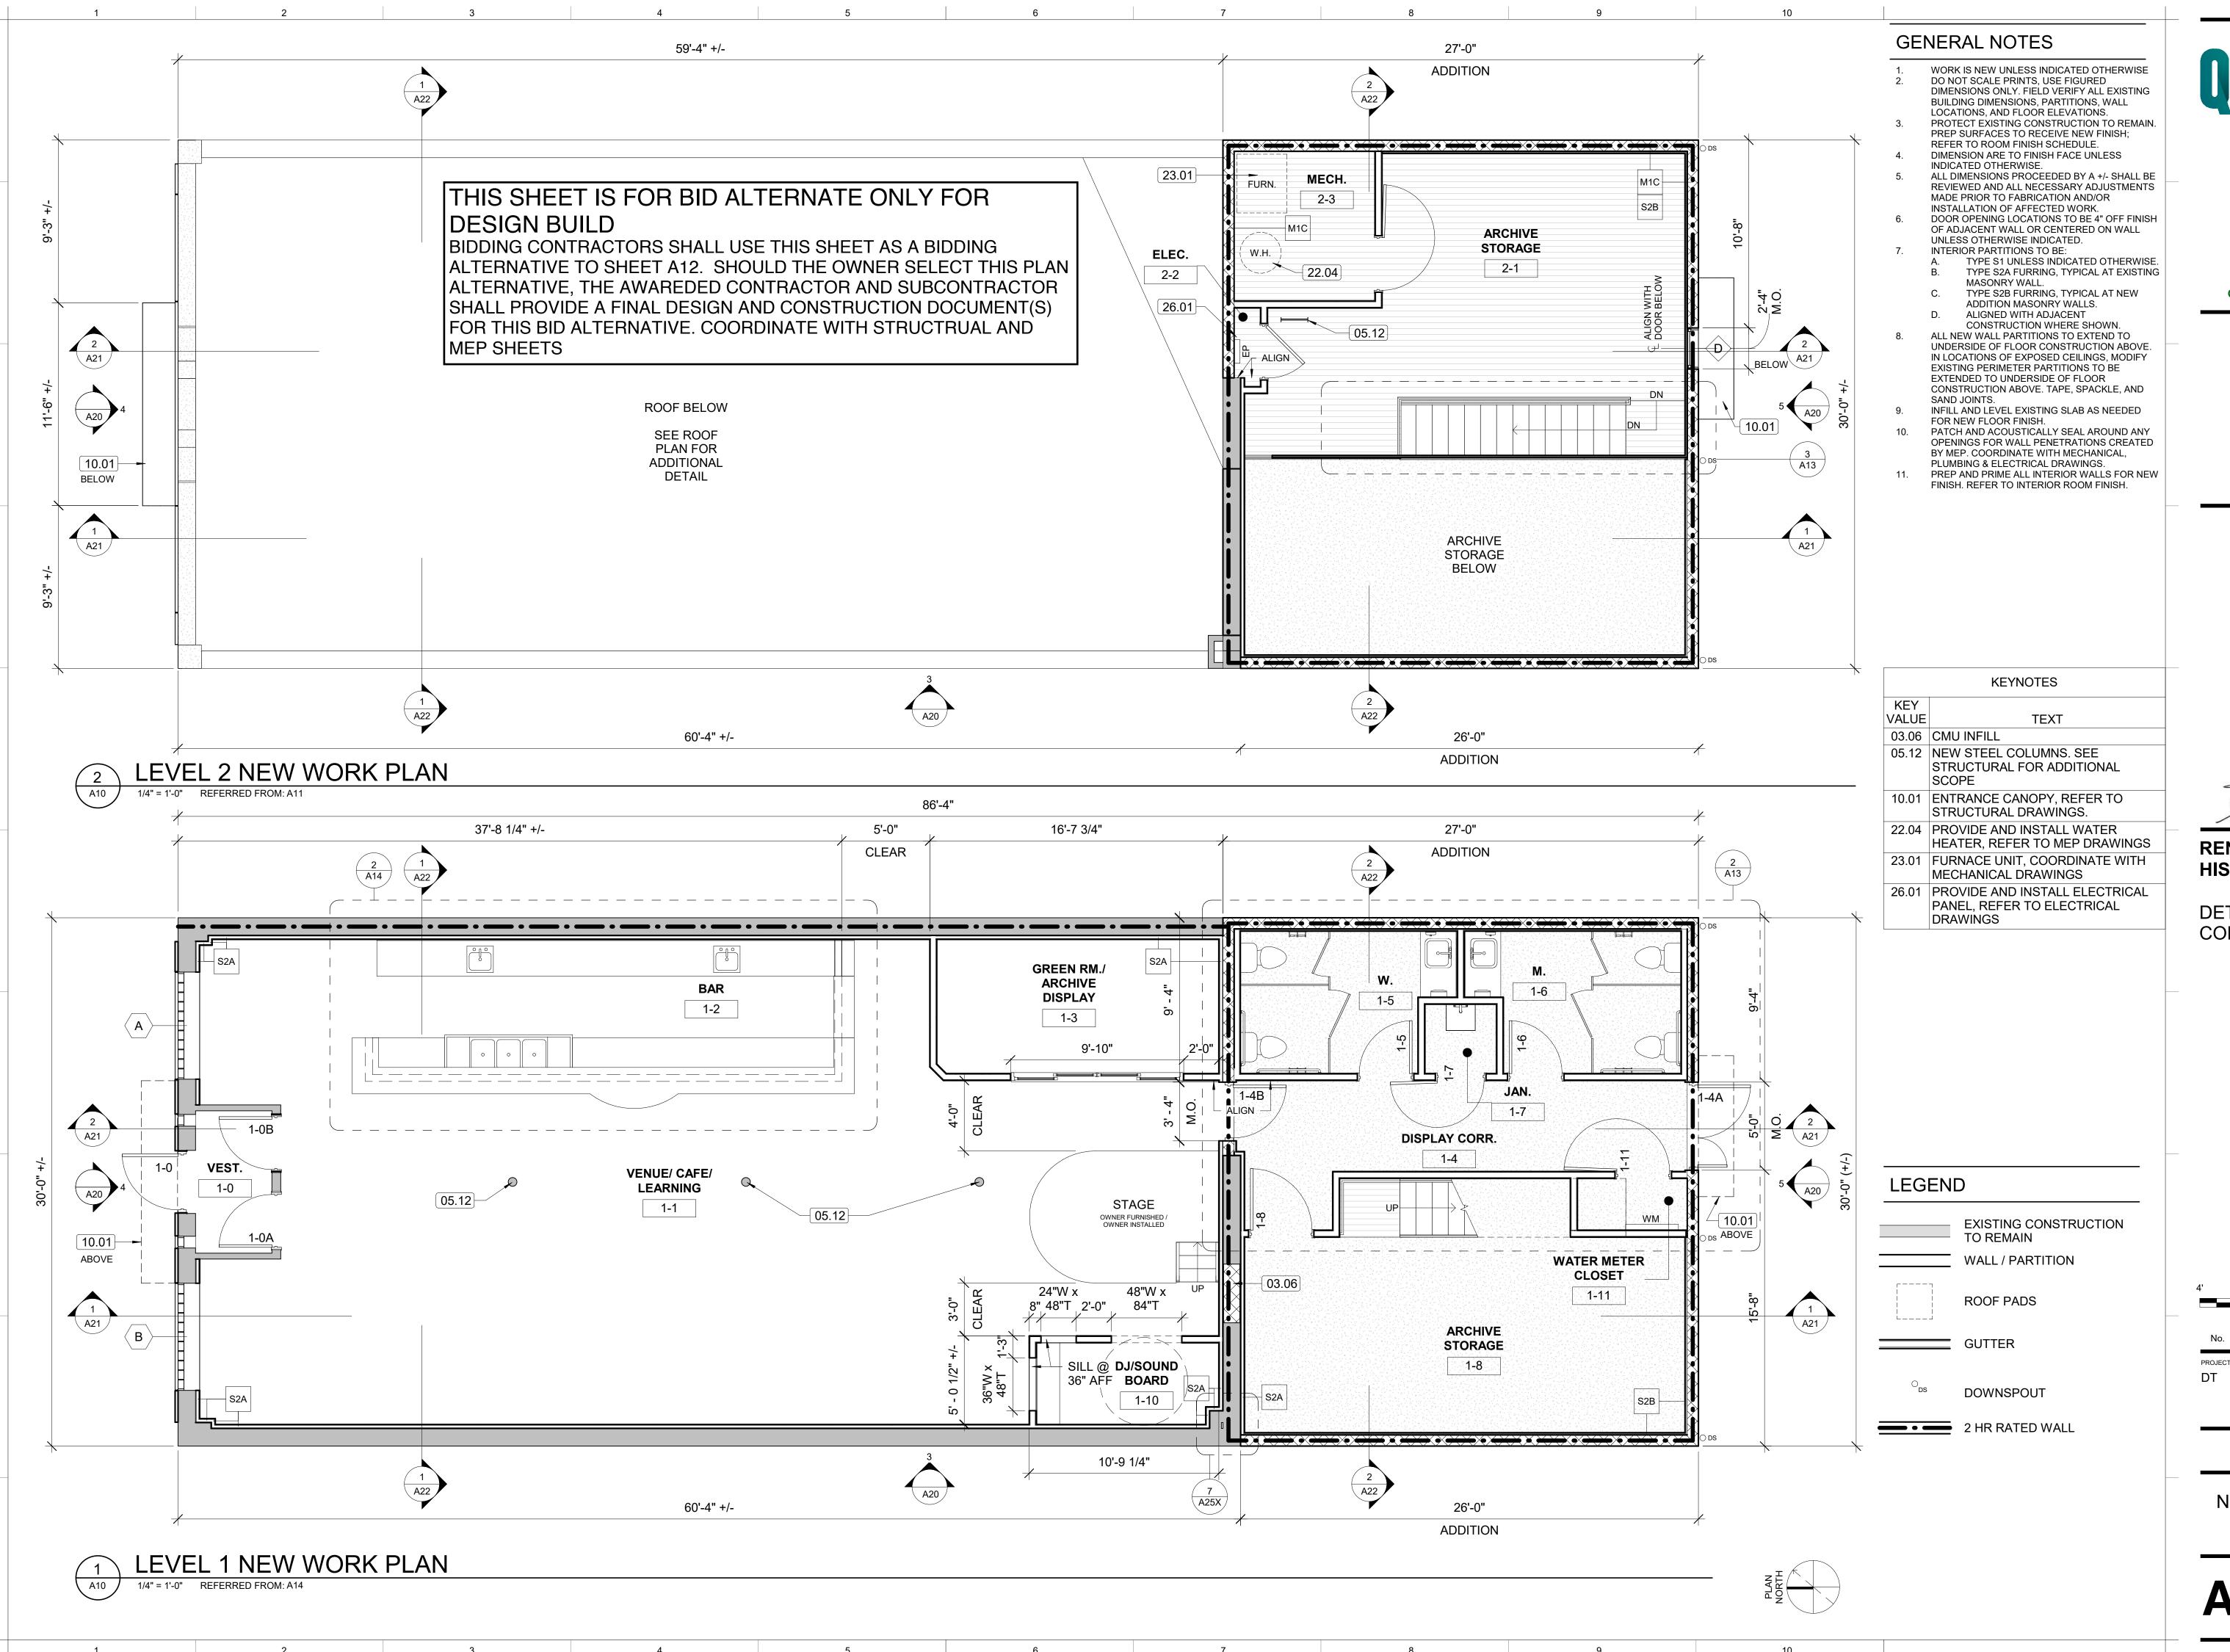







RENOVATION OF HISTORIC BLUE BIRD INN

DETROIT SOUND CONSERVANCY

2' 0 4' 8

1/4" = 1' - 0" SCALE OF FEET

No. Date Description

ROJECT MANAGER: DRAWN BY:


KP/LH/SR


PROJECT MANAGER:

PERMIT / BID SET 03/10/2023

NEW WORK FLOOR PLANS

ALT A10

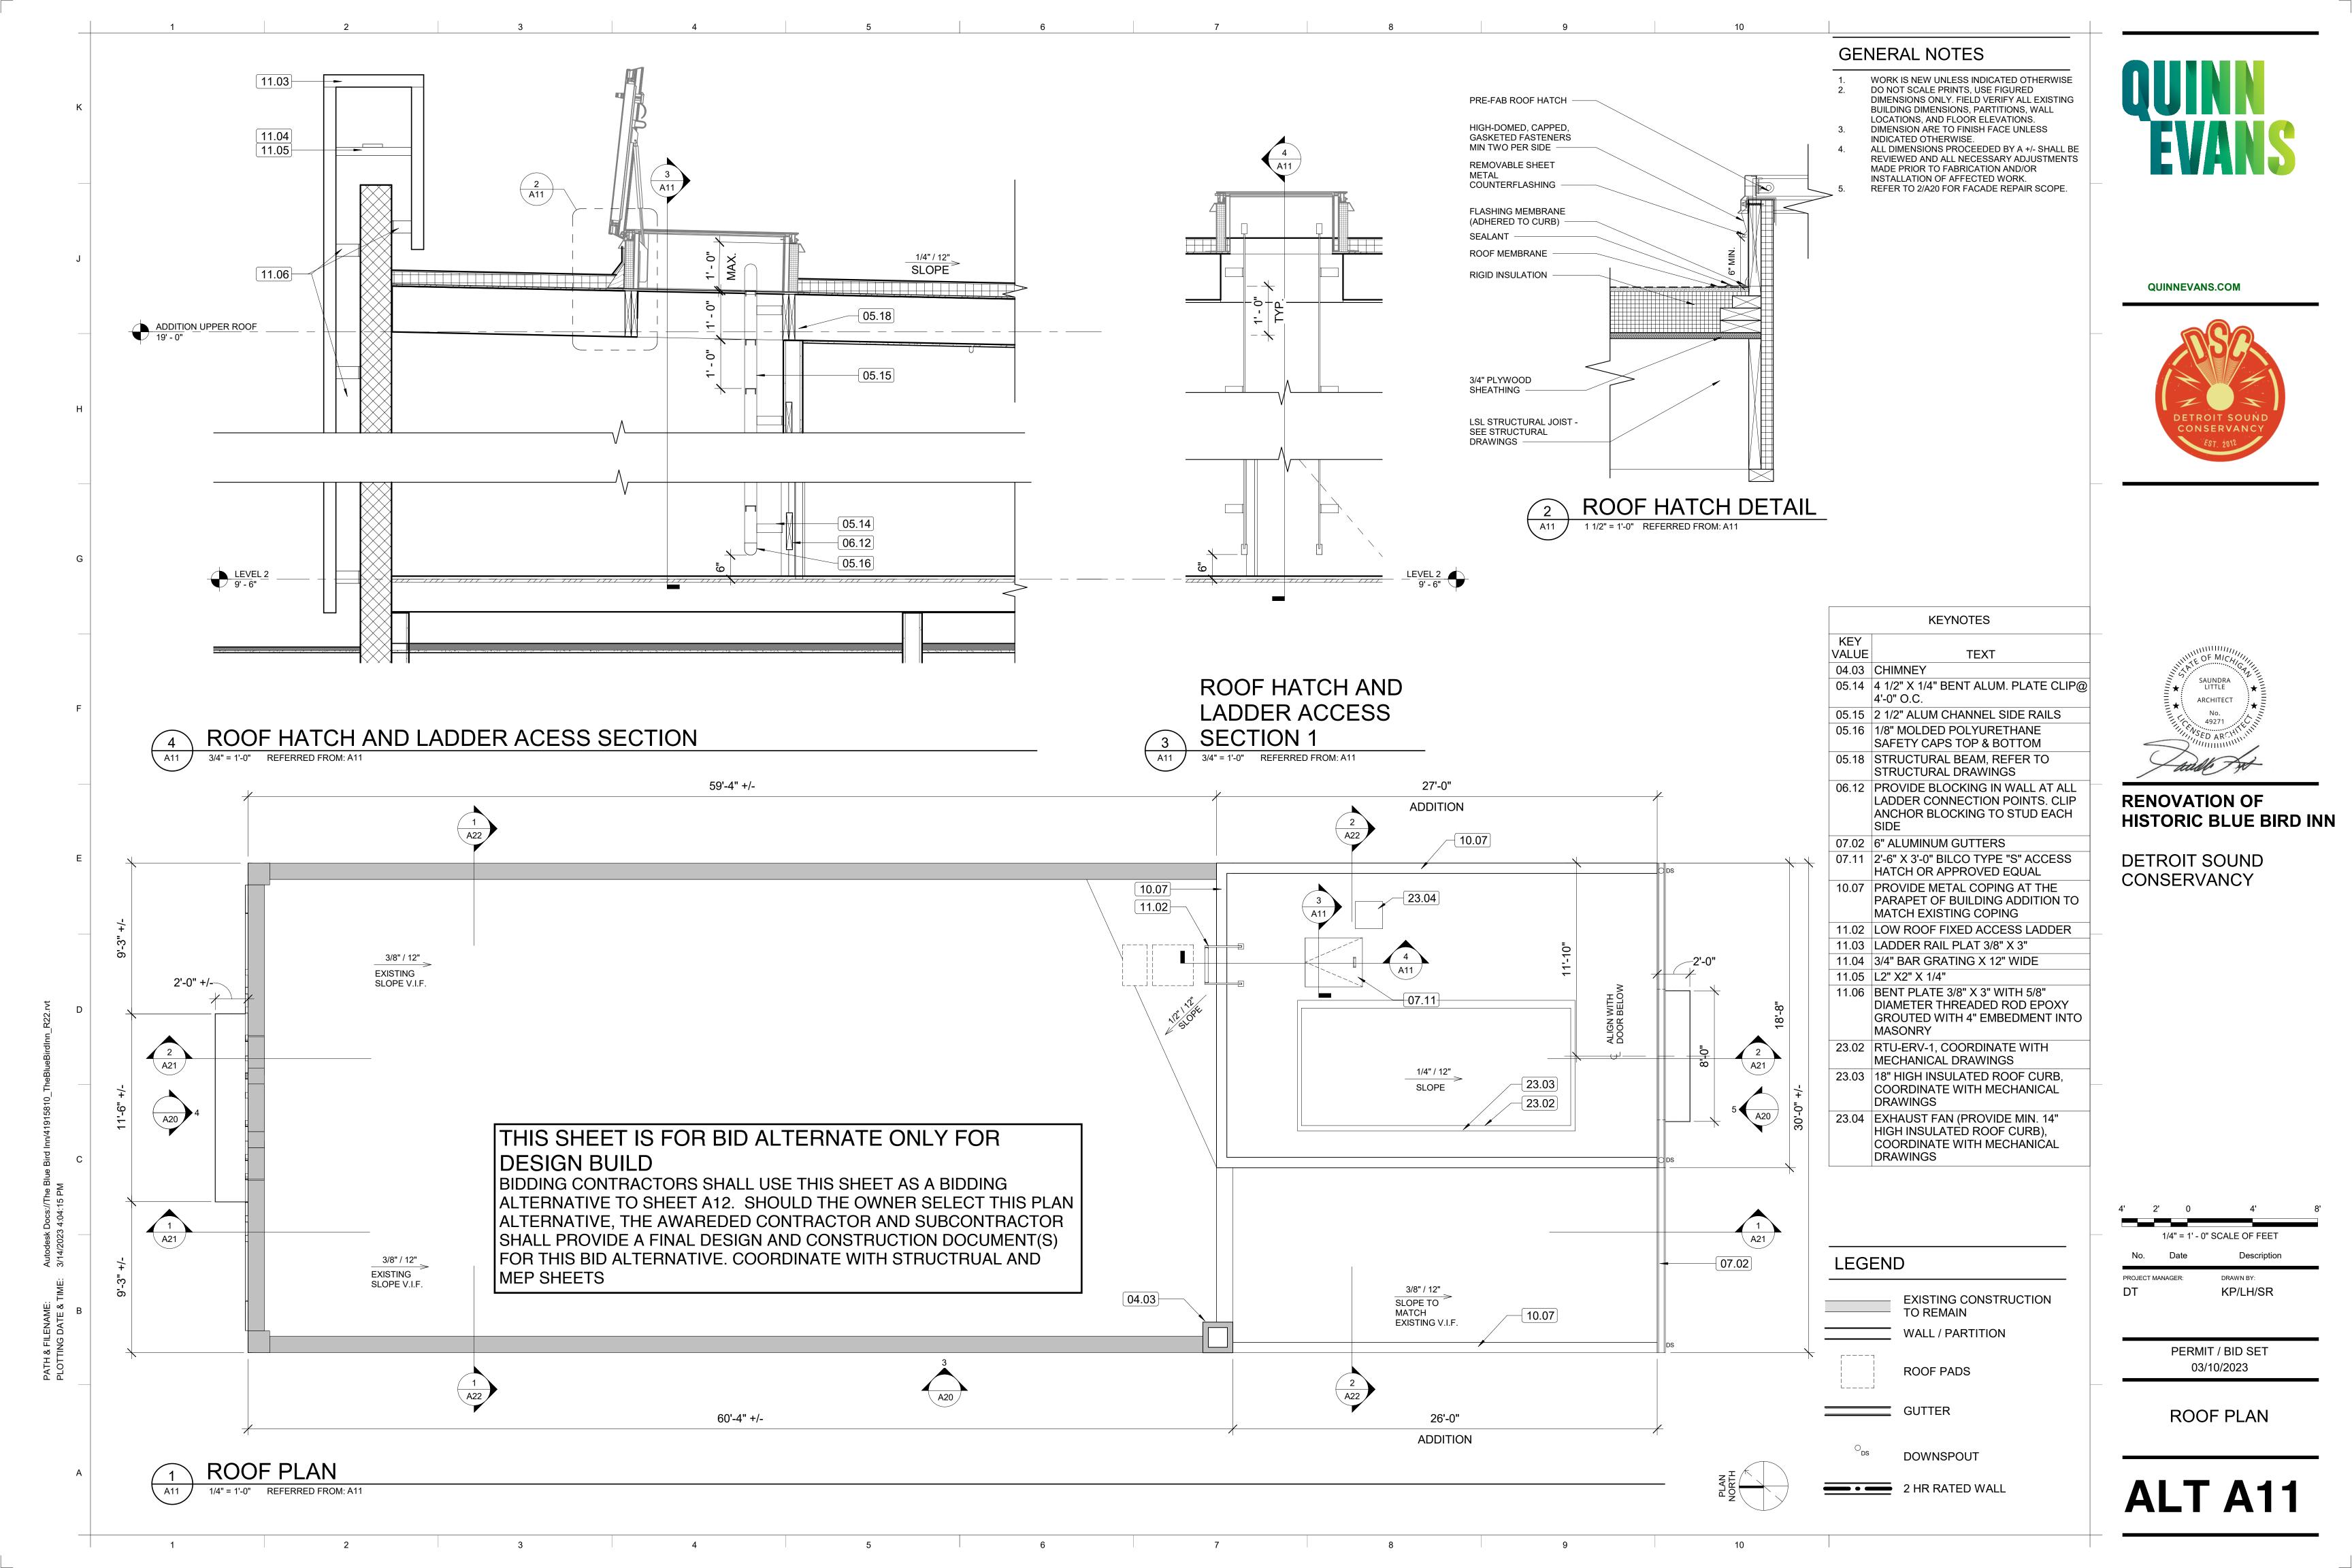


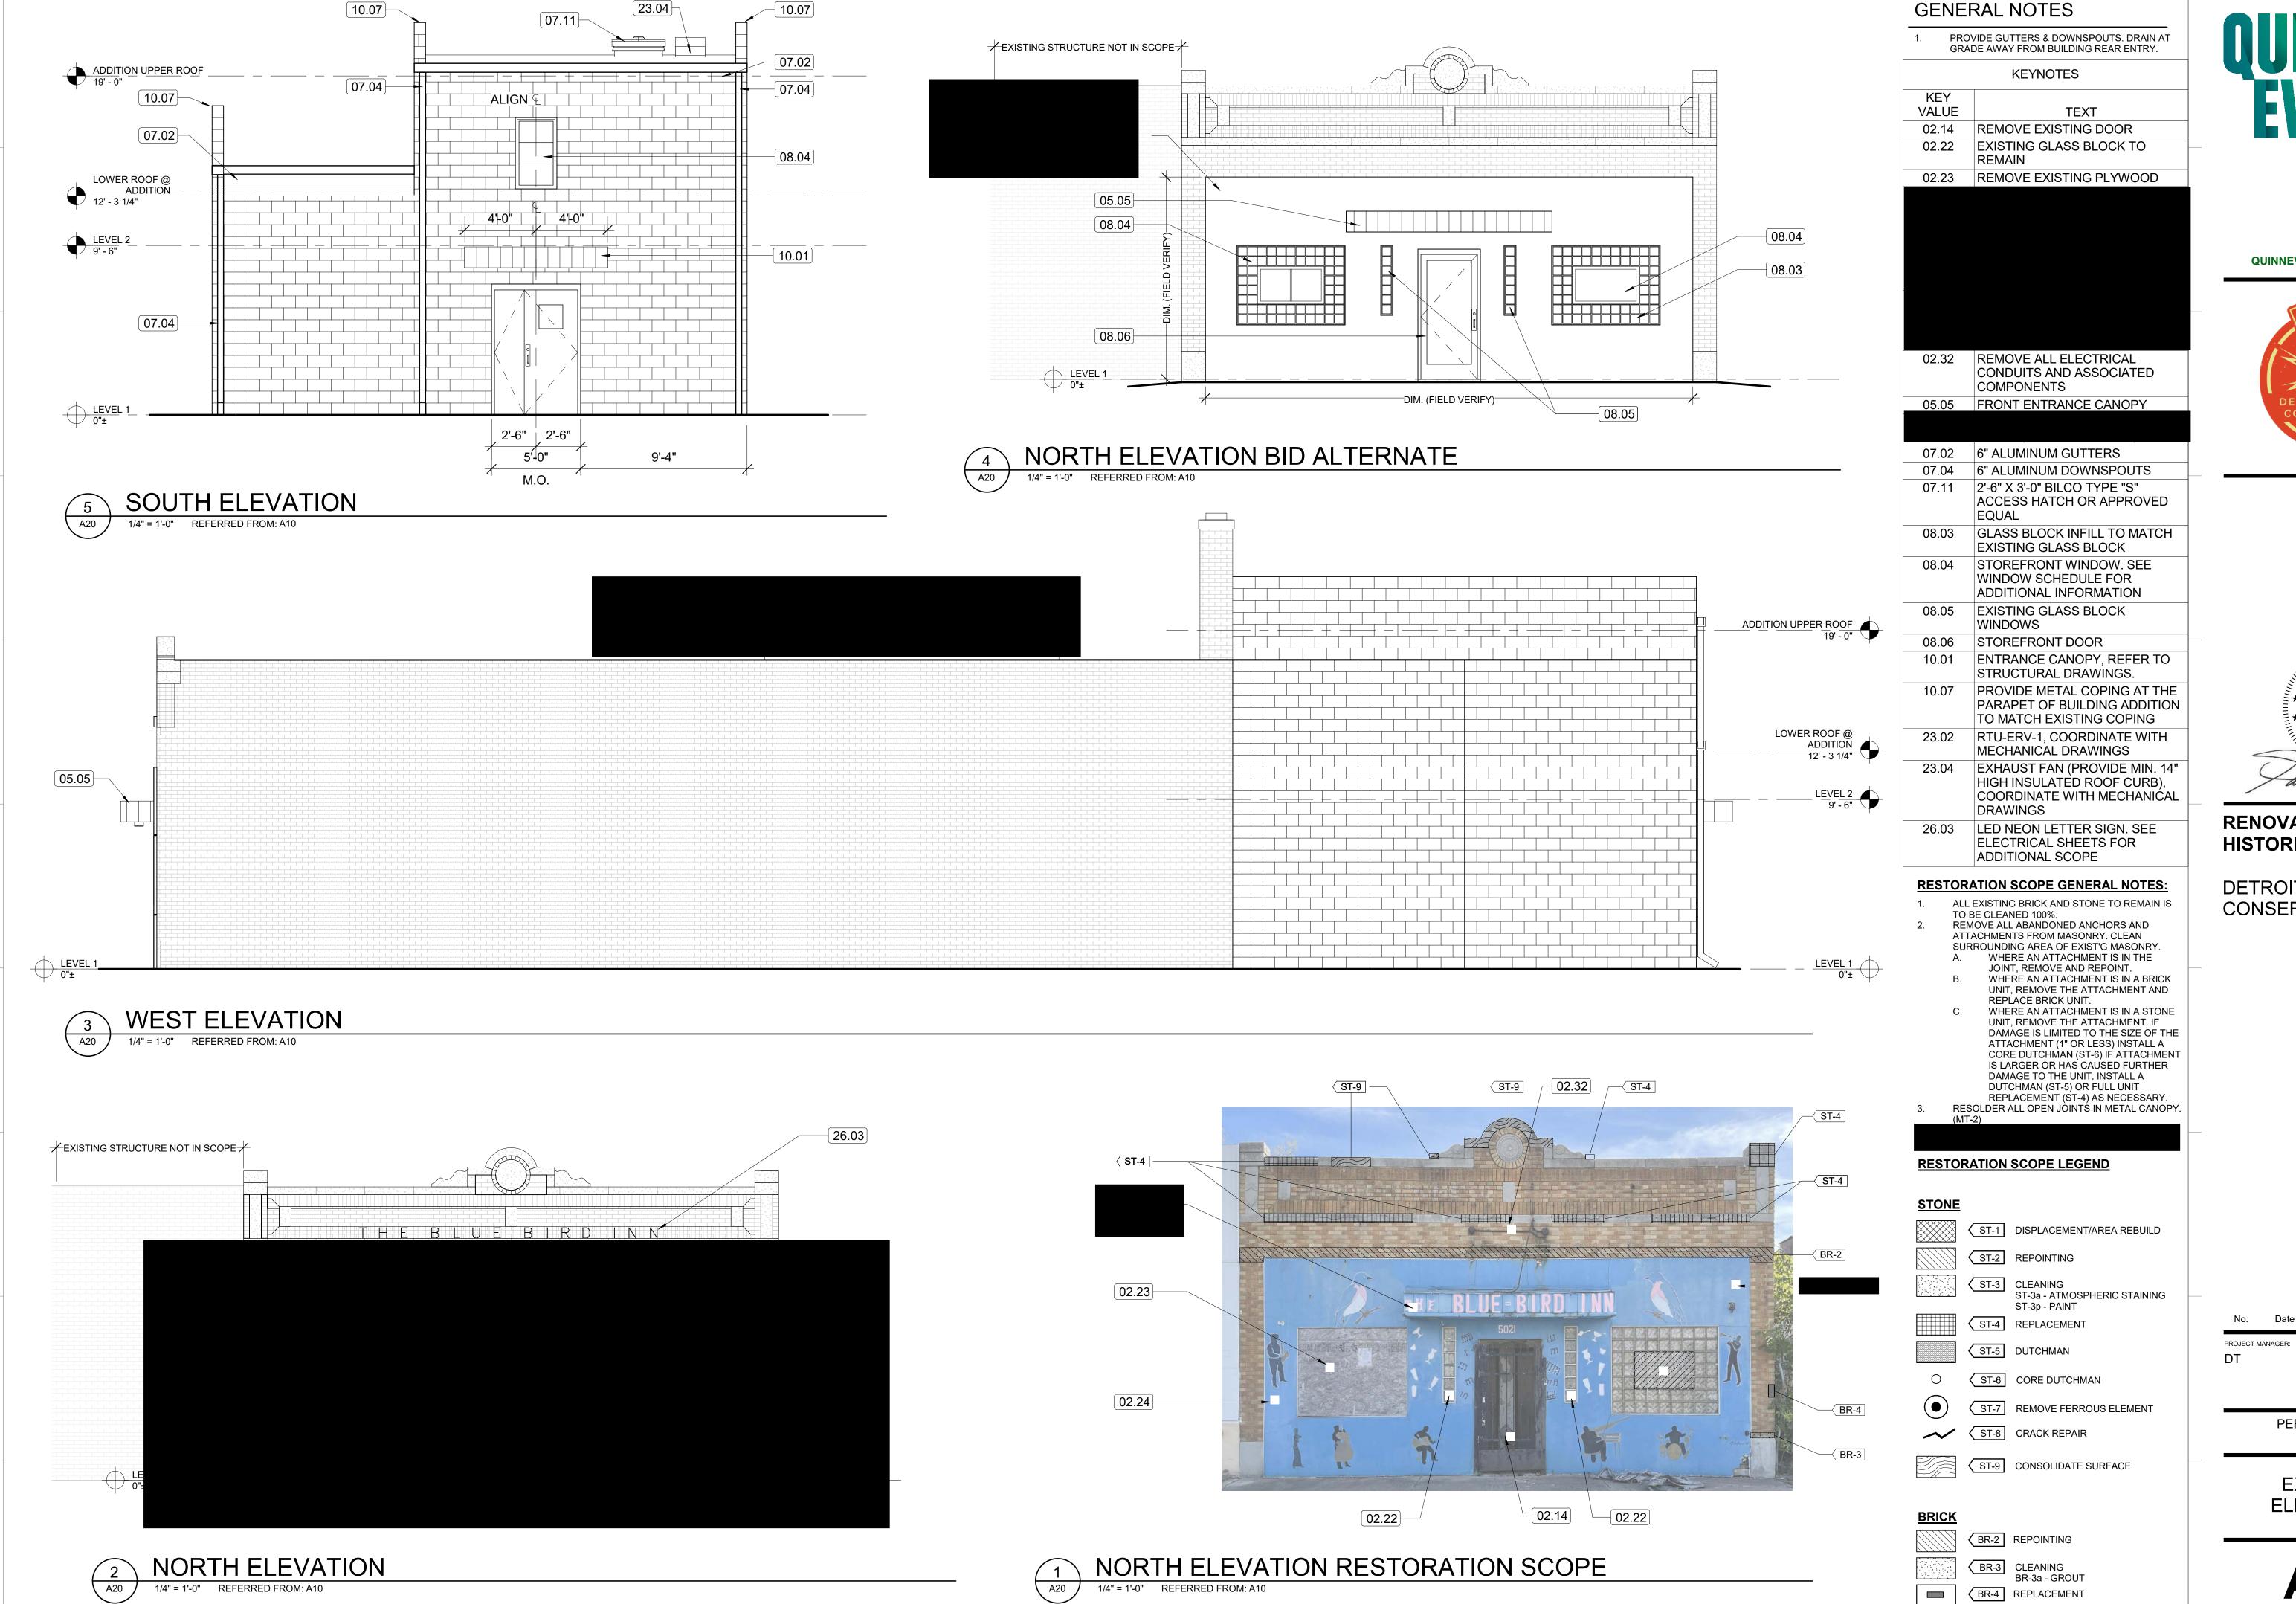

QUINN EVANS

QUINNEVANS.COM



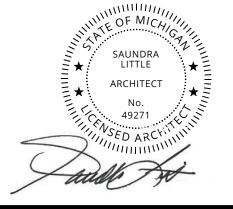

RENOVATION OF HISTORIC BLUE BIRD INN

DETROIT SOUND CONSERVANCY

Δ20

PERMIT / BID SET

03/10/2023


EXTERIOR

ELEVATIONS

Description

DRAWN BY:

KP/LH/SR

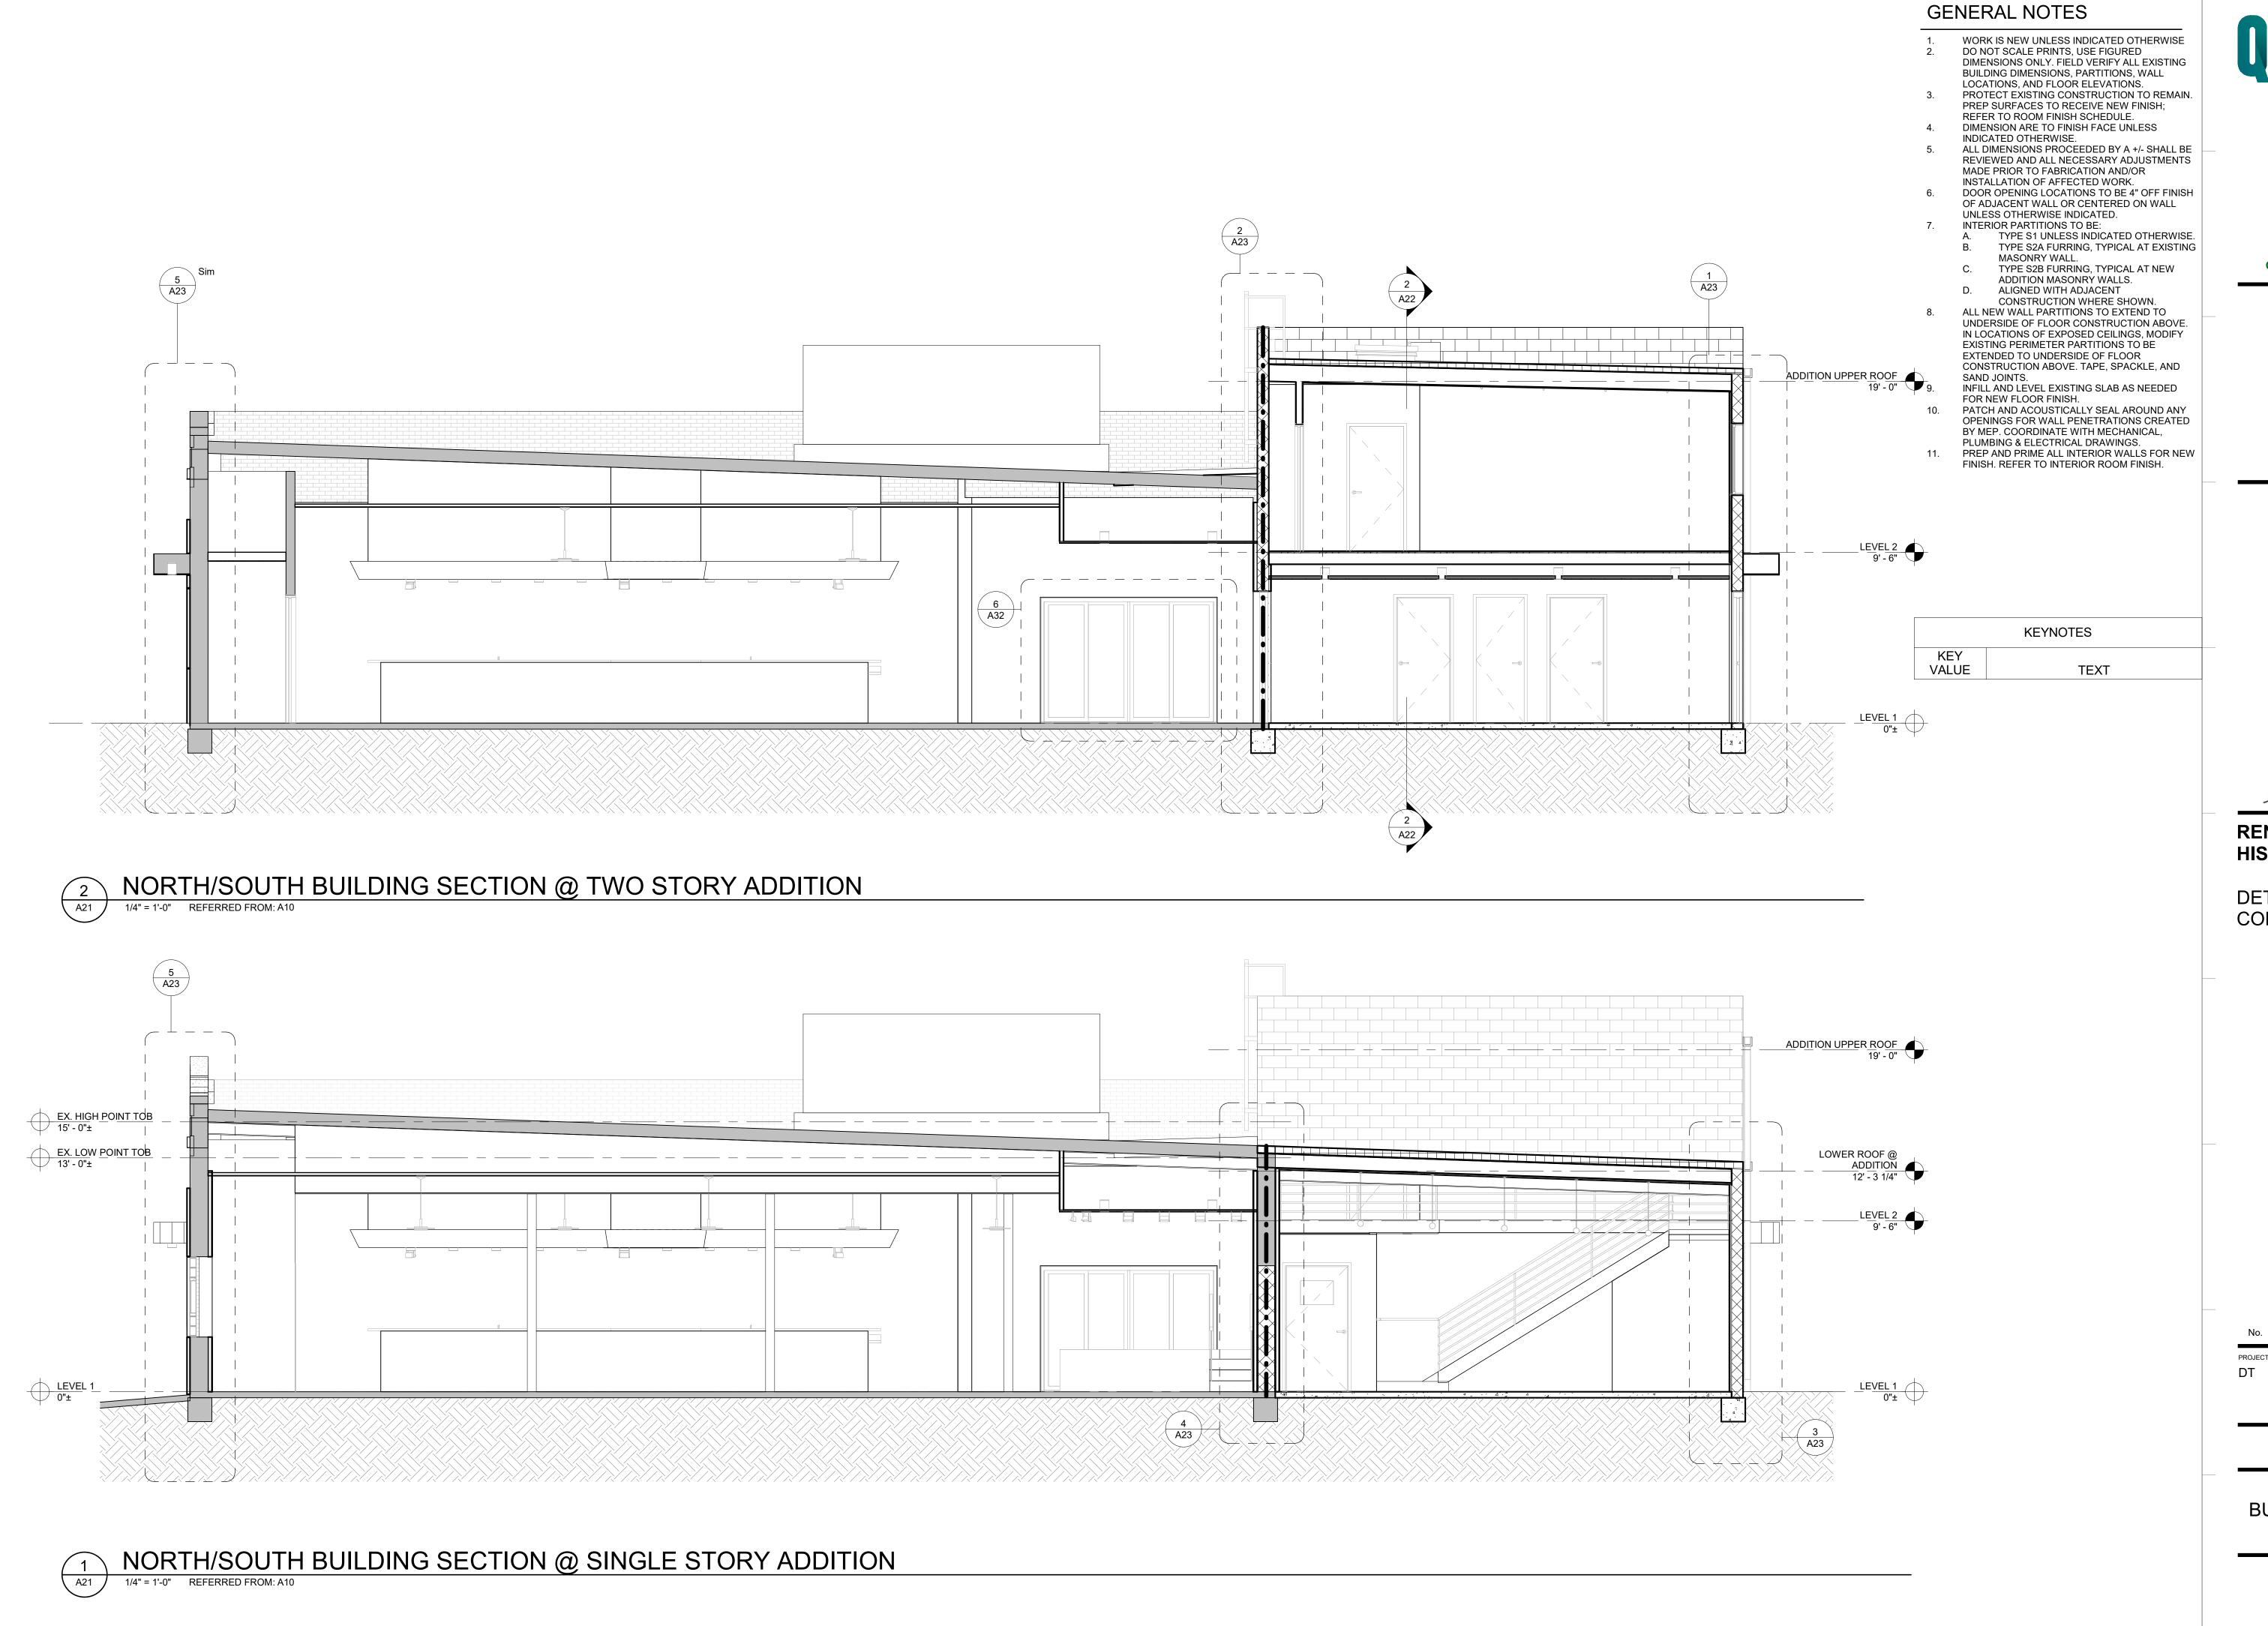







RENOVATION OF HISTORIC BLUE BIRD INN

DETROIT SOUND CONSERVANCY


No. Date Description

PROJECT MANAGER: DRAWN BY:

KP/LH/SR

PERMIT / BID SET 03/10/2023

BUILDING SECTIONS

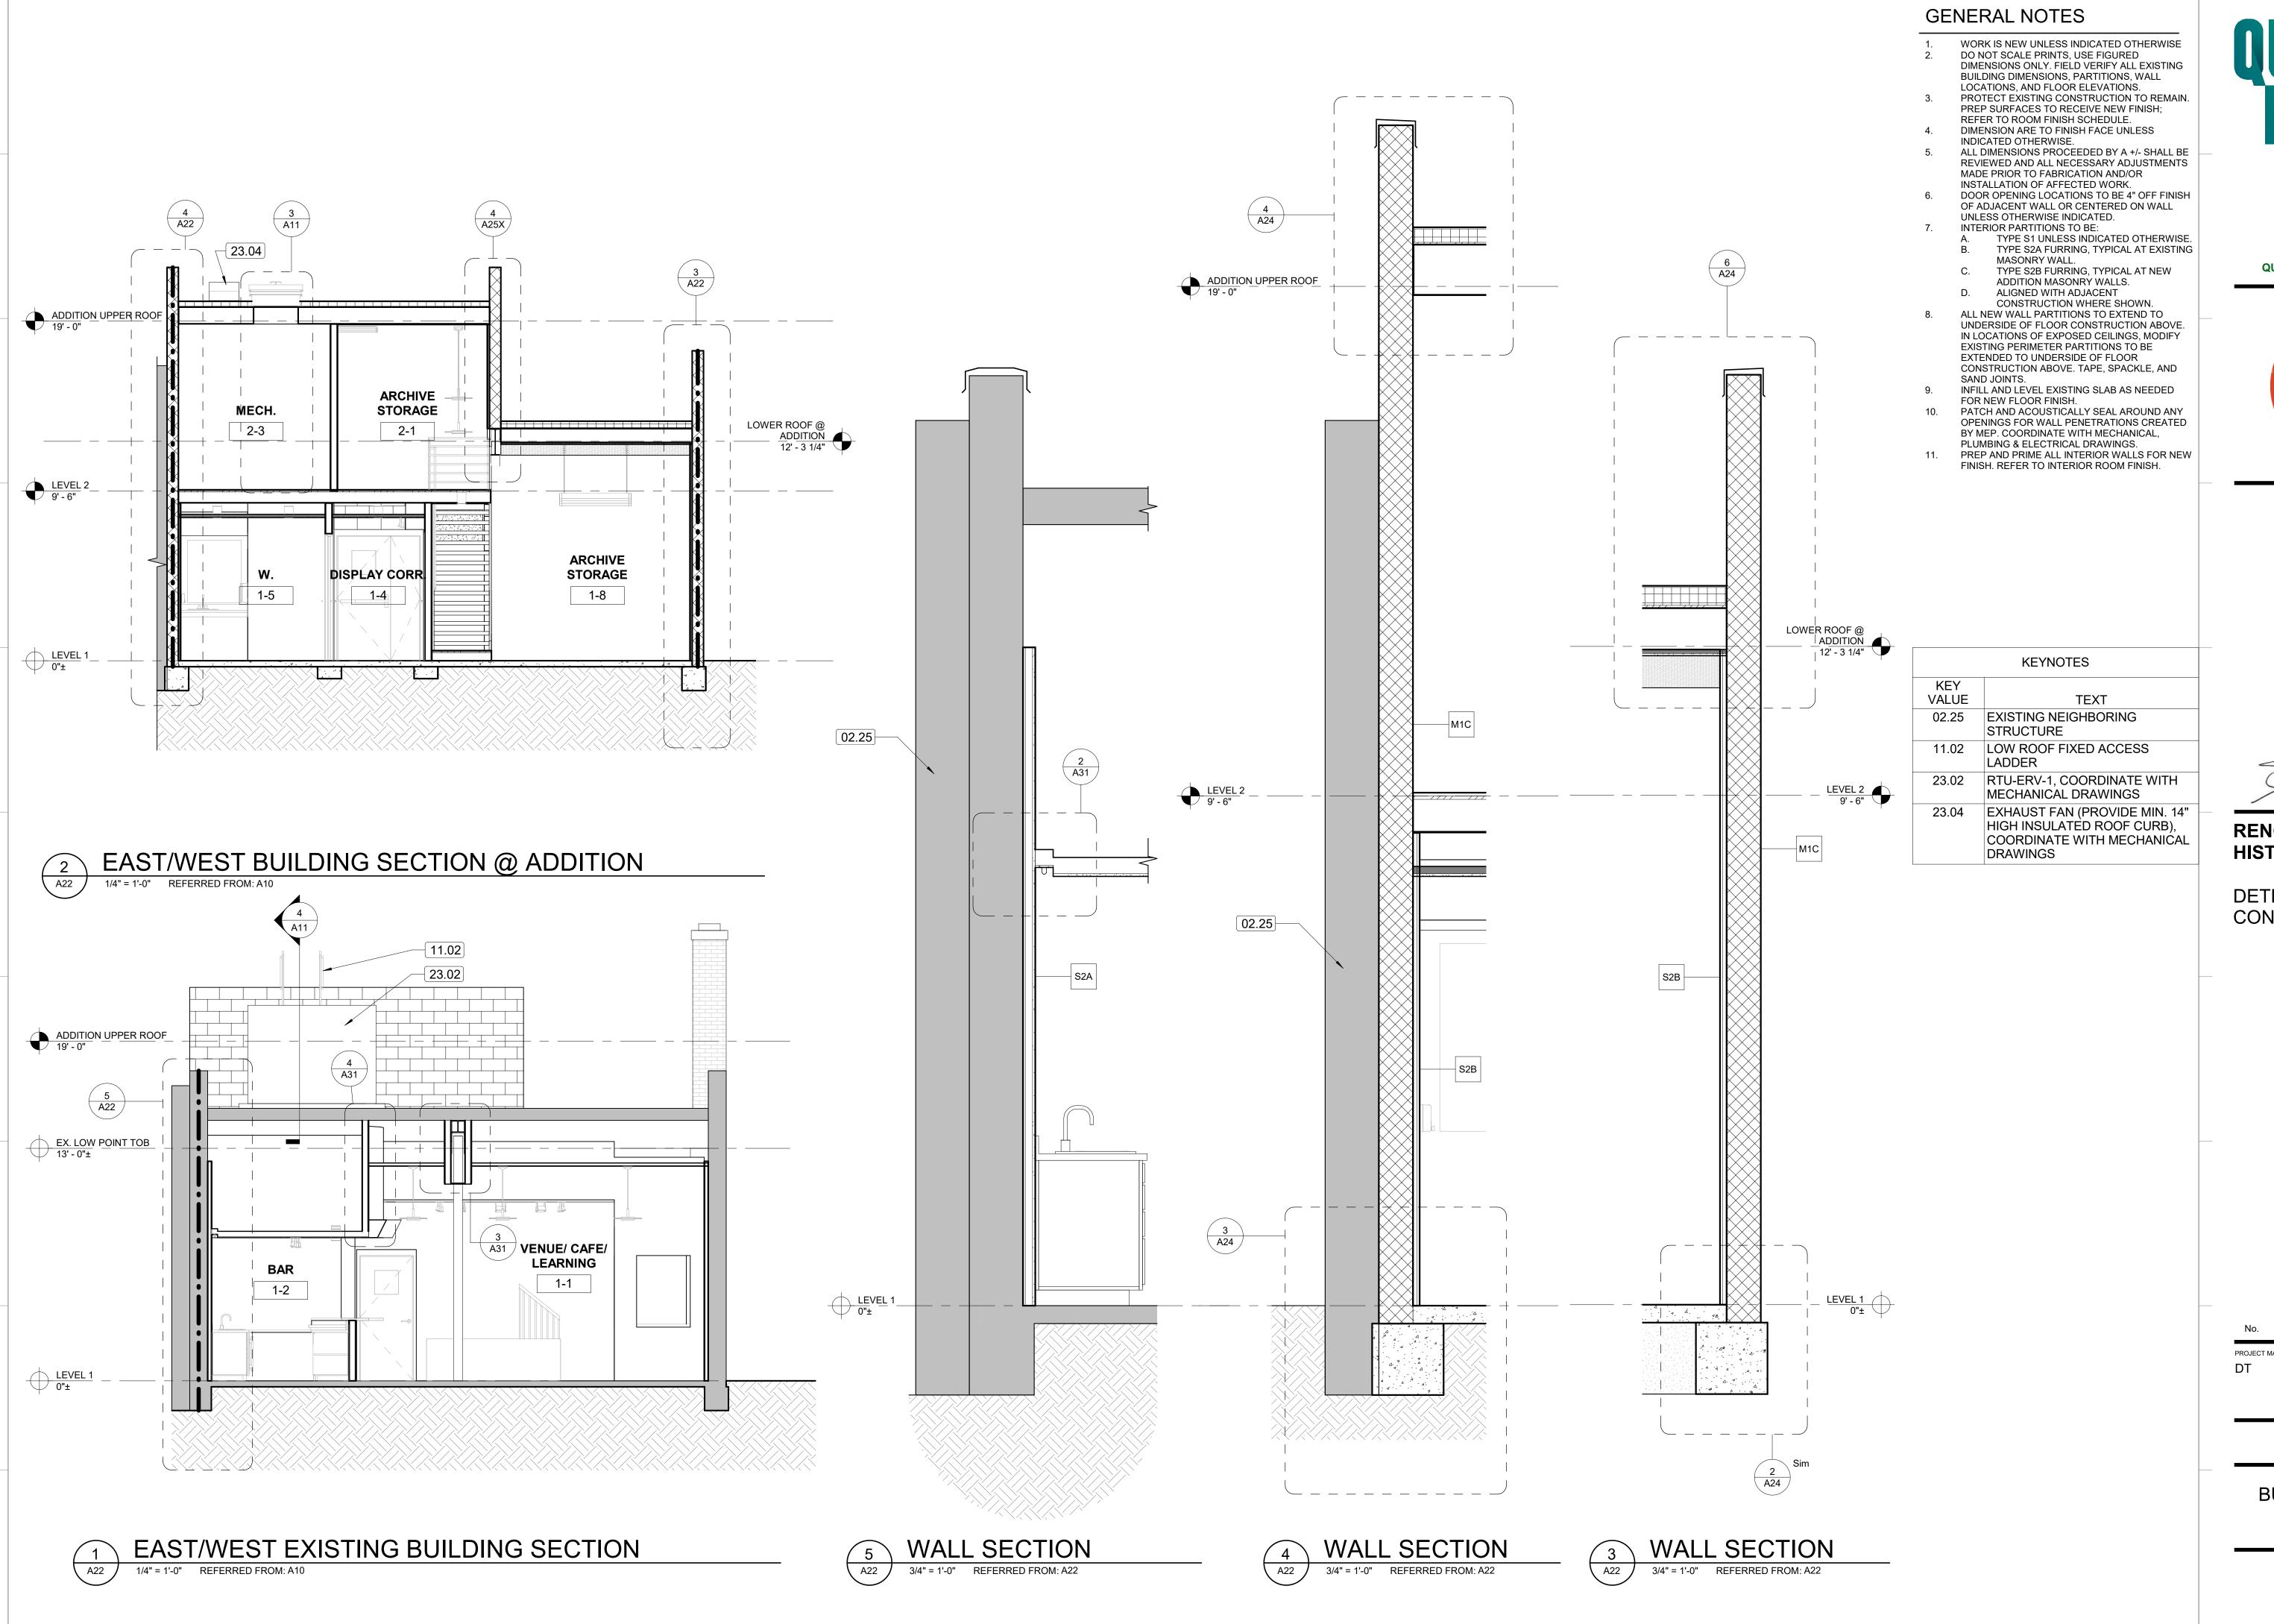







RENOVATION OF HISTORIC BLUE BIRD INN

DETROIT SOUND CONSERVANCY


No. Date Description

PROJECT MANAGER: DRAWN BY:


DT KP/LH/SR

PERMIT / BID SET 03/10/2023

BUILDING & WALL SECTIONS

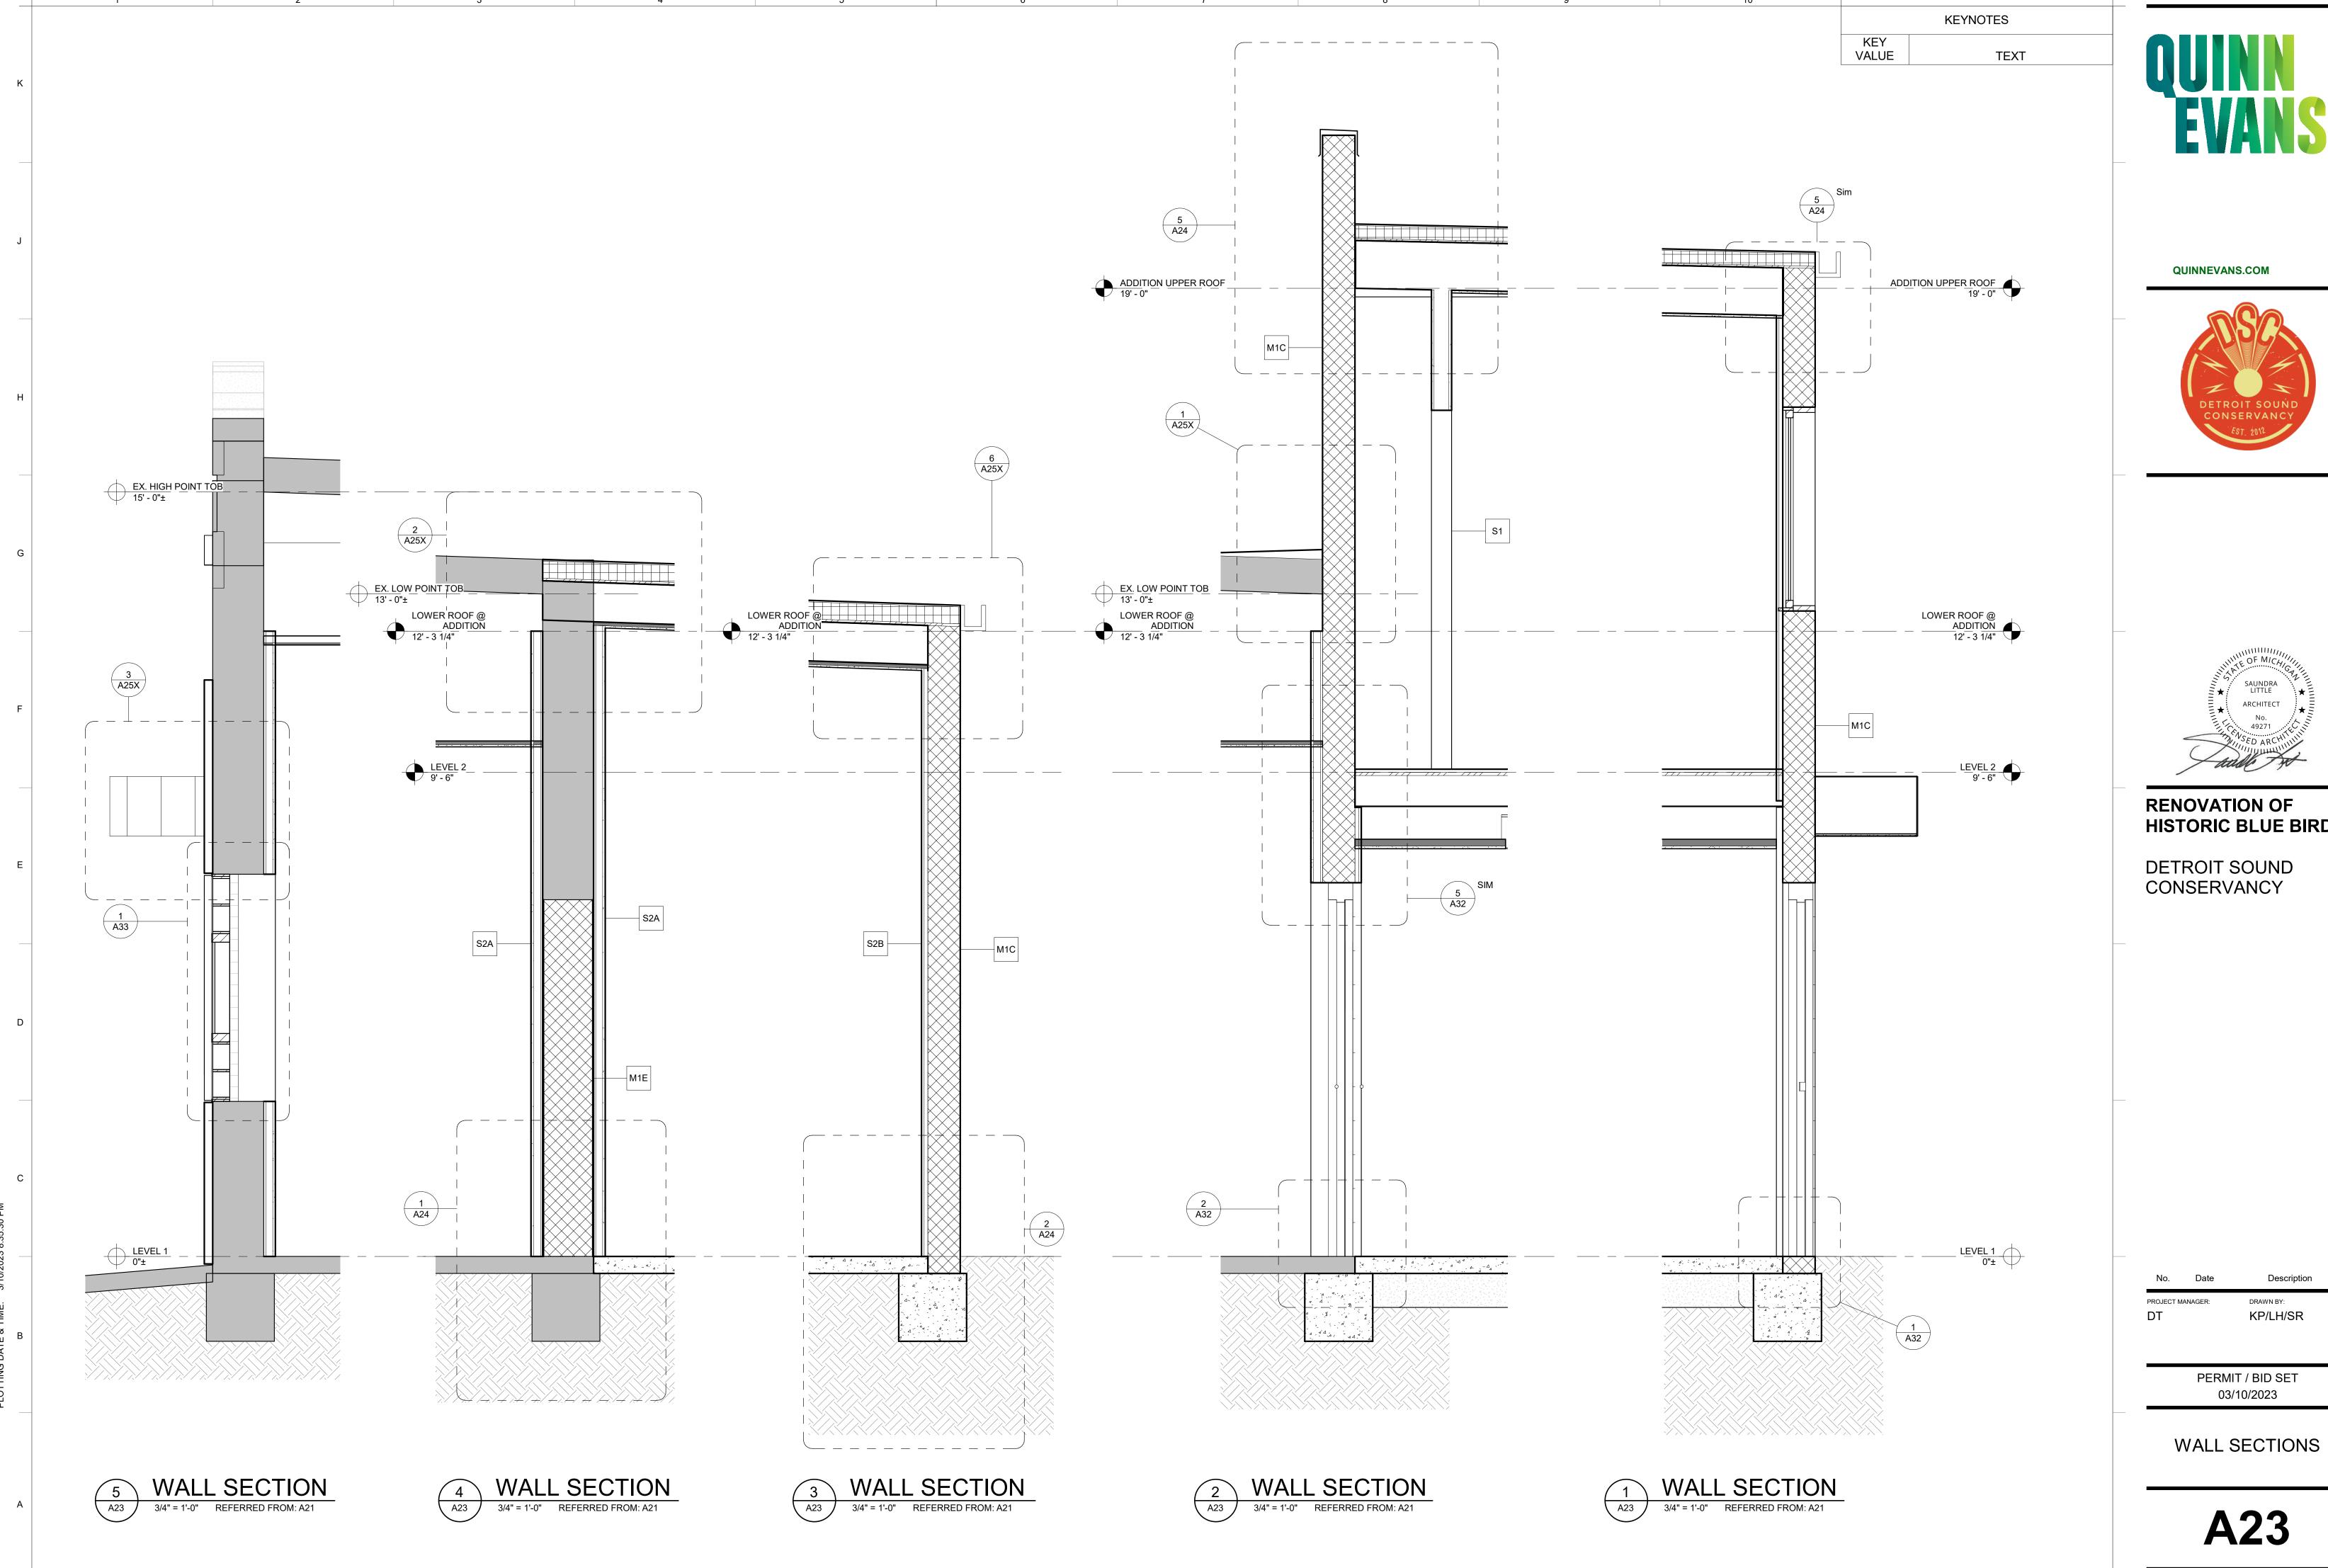




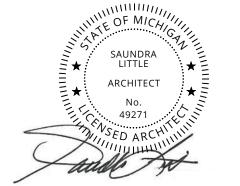

HISTORIC BLUE BIRD INN

KP/LH/SR

PERMIT / BID SET 03/10/2023

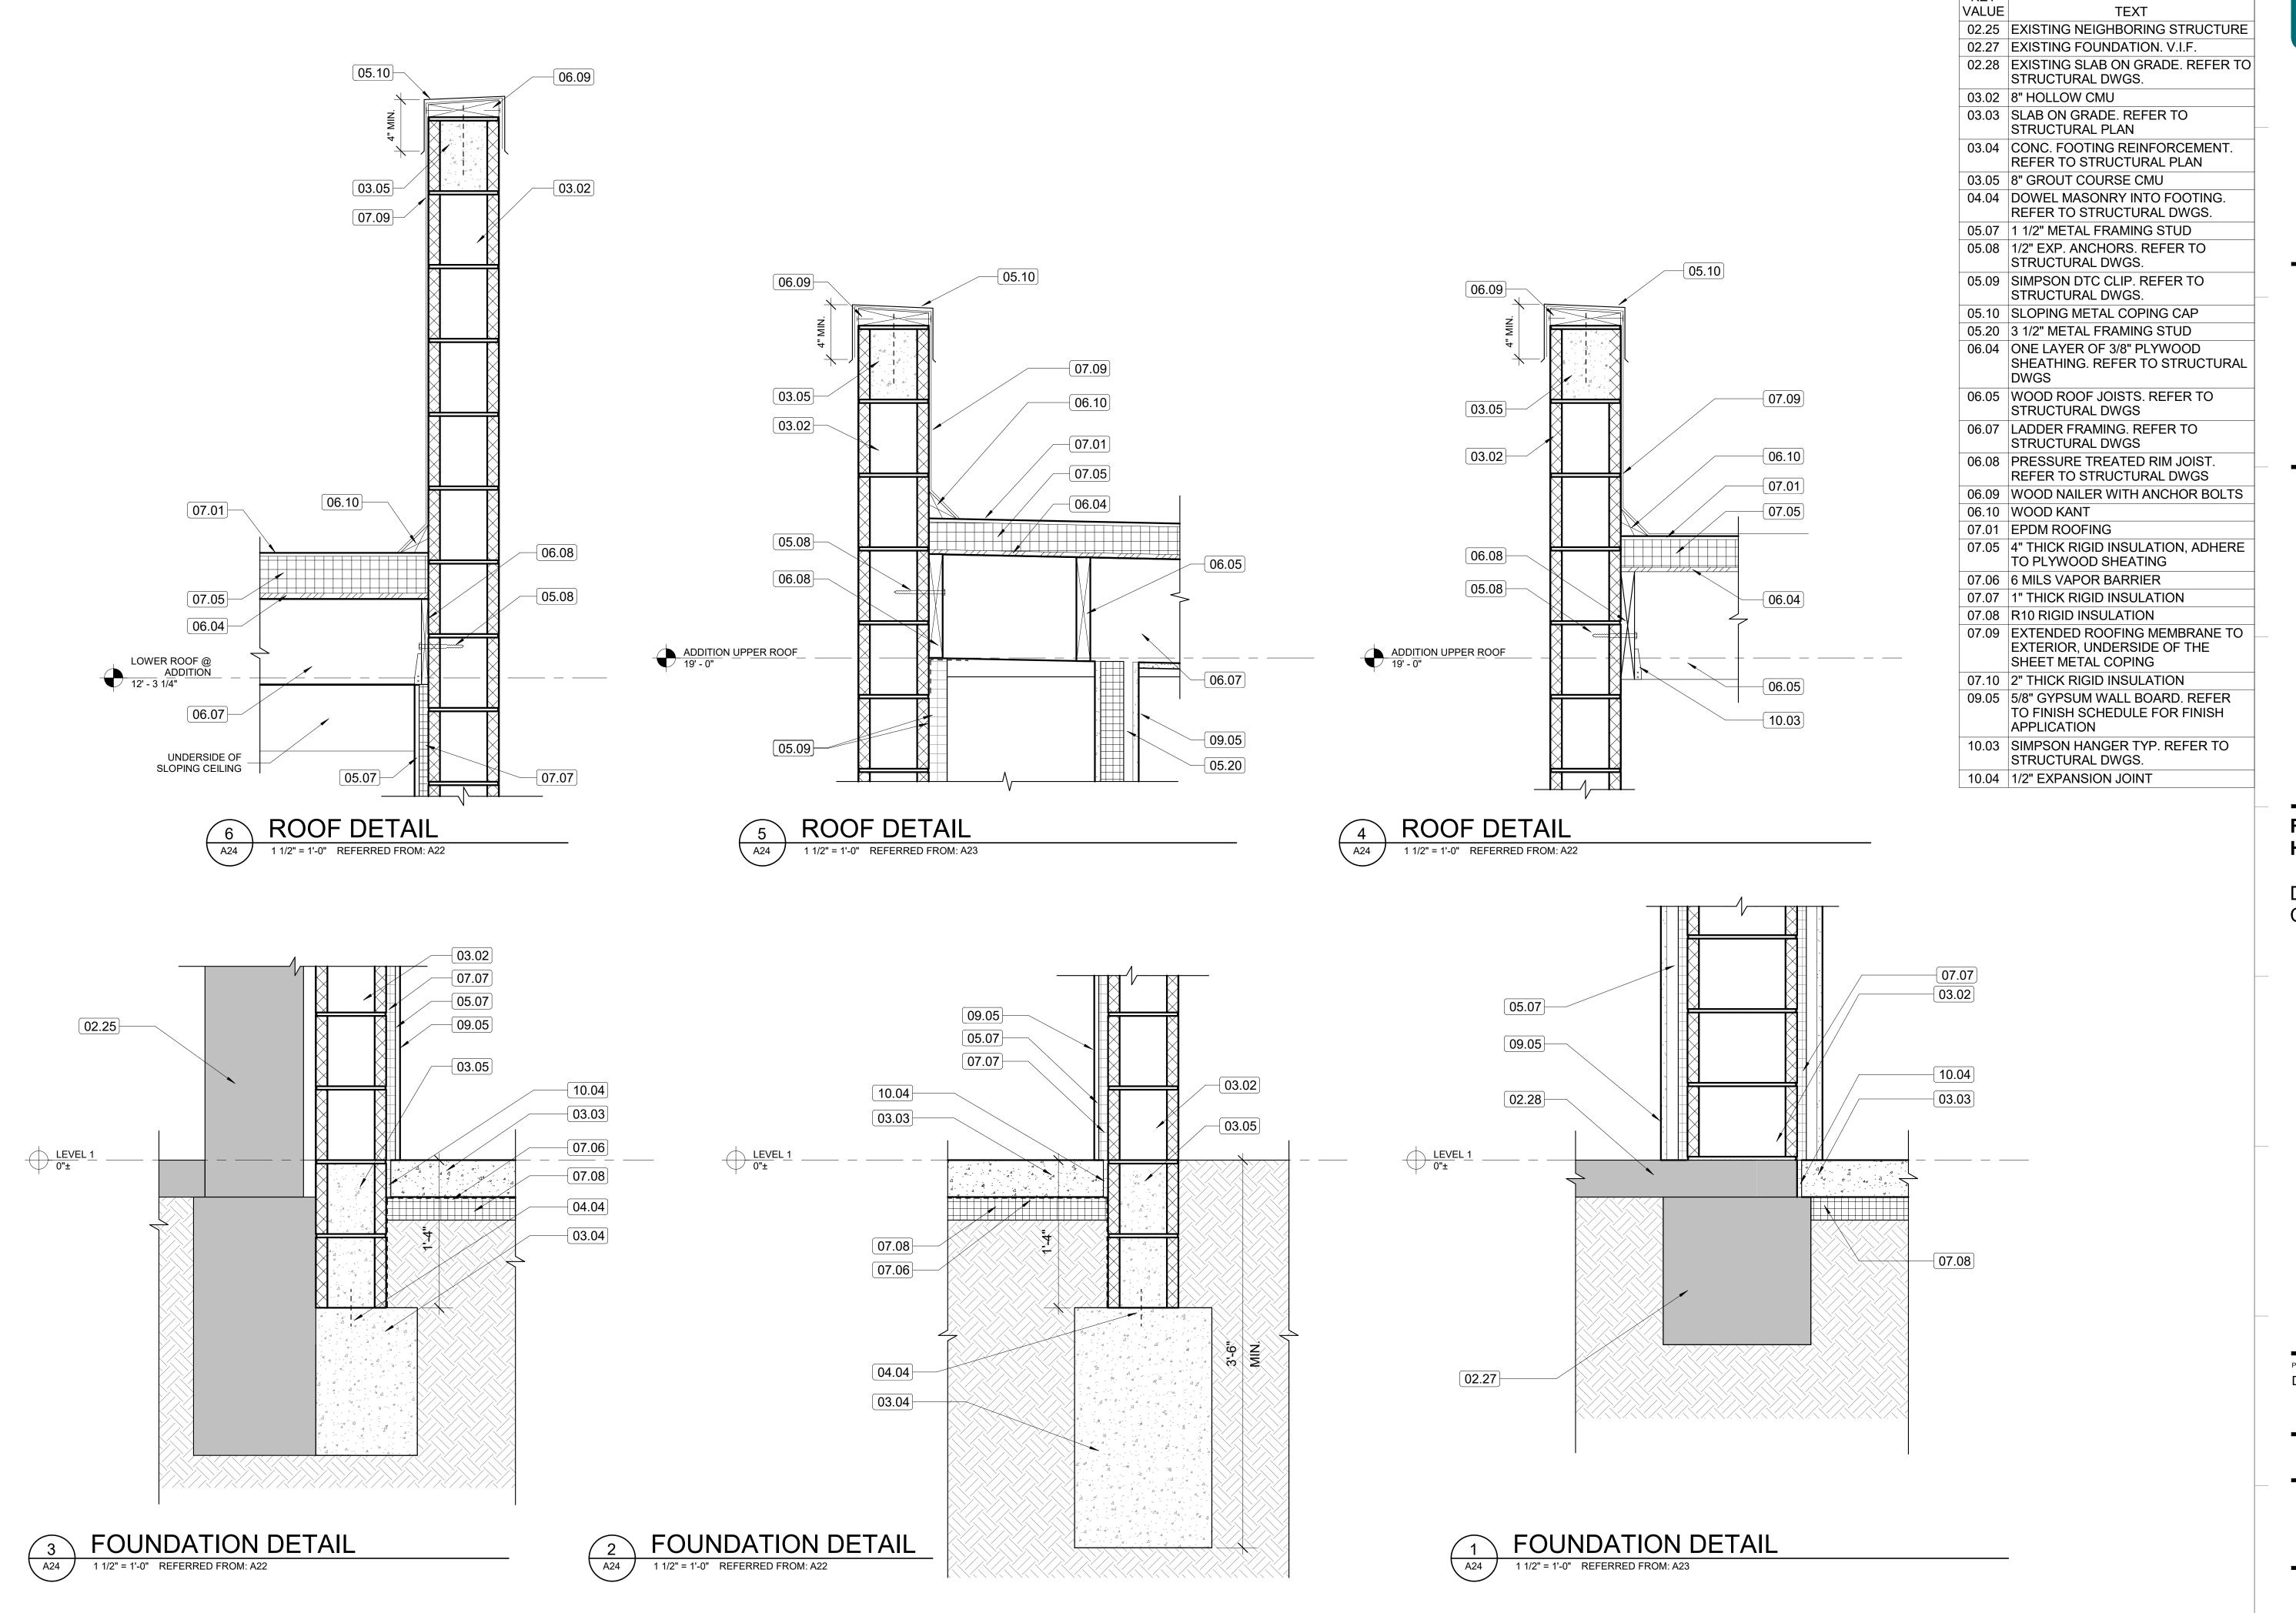



KEYNOTES

QUINNEVANS.COM





RENOVATION OF HISTORIC BLUE BIRD INN

DETROIT SOUND CONSERVANCY

No. Date Description

PROJECT MANAGER: DRAWN BY:

The project MANAGER: DRAWN BY:

The project MANAGER: MRAWN BY:

The project MANAGER: DRAWN BY:

The project MANAGER: MRAWN BY:

The project MRAWN BY:

The projec

PERMIT / BID SET 03/10/2023

EXTERIOR DETAILS

LOW ROOF FRAMING PLAN NOTES:

- 1. VERIFY IN FIELD ALL CONDITIONS PRIOR TO PROCEEDING WITH NEW WORK. NOTIFY A/E TEAM IMMEDIATELY IF ANY DISCREPANCIES ARE DISCOVERED.
- 2. COORDINATE THE STRUCTURAL DRAWINGS WITH THE ARCHITECTURAL DRAWINGS TO ENSURE THE DESIGN INTENT IS SATISFACTORILY IMPLEMENTED.
- 3. PROVIDE TEMPORARY SUPPORT, SHORING, AND FORMING AS REQUIRED DURING CONSTRUCTION.
- 4. REFER TO STANDARD DETAILS, GENERAL NOTES, SPECIAL INSPECTIONS, AND DESIGN CRITERIA FOR ADDITIONAL INFORMATION/REQUIREMENTS.
- 5. <u>DESIGNATIONS</u>:
 - WOOD ROOF JOISTS 2x10 @ 24" O.C. MAX. + 5/8" SHEATHING, BRIDGE AT MID-SPAN
 - WOOD LEDGER BOARD 2x10 PRESSURE TREATED
 - MASONRY WALL 8" CMU REINFORCED W/ #5 BARS @ 32" O.C. MAX. VERT. + W1.7 LADDER TYPE HORIZONTAL JOINT REINFORCEMENT @ 16" O.C. MAX. + (2) #5 CONT. BOND BEAM AT TOP AND MID-HEIGHT OF WALL
 - STEEL BEARING PLATE 8x6x3/8"
 - WOOD HEADER (3) 1.75"x9.25" LVL1.8E Fb=2200PSI MIN., BRIDGE AT SPAN/3 LOCATIONS
 - LADDER FRAMING @ 24" O.C. MAX.
 - REFER TO DETAIL
 - EXISTING CORRODED STEEL COLUMN TO BE REMOVED AND REPLACED W/ NEW HSS6x1/4
 - EXISTING COLUMN TO BE STRUCTURALLY INSPECTED AFTER BUILDING FINISHES THAT ARE CONCEALING IT ARE REMOVED
 - BEARING POCKET TO BE RESTORED
 - EXISTING STEEL BEAM TO BE UNCOVERED FOR STRUCTURAL INSPECTION, RESTORATION/REPLACEMENT MAY BE REQUIRED
 - EXISTING STEEL CANOPY FRAMING TO BE UNCOVERED FOR STRUCTURAL INSPECTION, RESTORATION/REPLACEMENT MAY BE REQUIRED
 - REINFORCE EXISTING ROOF JOISTS WITH NEW 2x10 SISTERED TO EACH EXISTING JOIST
 - PROVIDE (2) 1.75"x9.25" LVL BLOCKING AROUND UNIT EDGES



QUINNEVANS.COM



422 N. ALTADENA ROYAL OAK, MI 48067 248.561.2035



RENOVATION OF HISTORIC BLUE BIRD INN


DETROIT SOUND CONSERVANCY

1 03.03.2023 BIDS & PERMITS

PROJECT MANAGER:

CONSTRUCTION DOCUMENTS 03/03/2023

LOW ROOF FRAMING PLAN

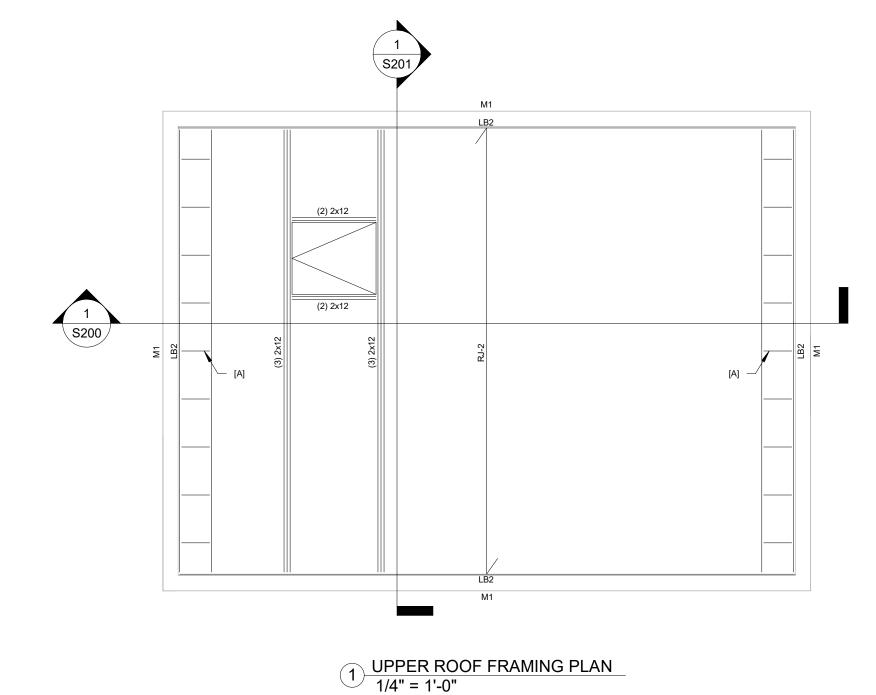

UPPER ROOF FRAMING PLAN NOTES:

- 1. VERIFY IN FIELD ALL CONDITIONS PRIOR TO PROCEEDING WITH NEW WORK. NOTIFY A/E TEAM IMMEDIATELY IF ANY DISCREPANCIES ARE DISCOVERED.
- 2. COORDINATE THE STRUCTURAL DRAWINGS WITH THE ARCHITECTURAL DRAWINGS TO ENSURE THE DESIGN INTENT IS SATISFACTORILY IMPLEMENTED.
- 3. PROVIDE TEMPORARY SUPPORT, SHORING, AND FORMING AS REQUIRED DURING CONSTRUCTION.
- 4. REFER TO STANDARD DETAILS, GENERAL NOTES, SPECIAL INSPECTIONS, AND DESIGN CRITERIA FOR ADDITIONAL INFORMATION/REQUIREMENTS.
- 5. <u>DESIGNATIONS</u>:
 - RJ-2: WOOD ROOF JOISTS 2x12 @ 16" O.C. MAX. + 5/8" SHEATHING, BRIDGE AT SPAN/3 LOCATIONS
 - LB2: WOOD LEDGER BOARD 2x12 PRESSURE TREATED
 - M1: MASONRY WALL 8" CMU REINFORCED W/ #5 BARS @ 32" O.C. MAX. VERT.
 + W1.7 LADDER TYPE HORIZONTAL JOINT REINFORCEMENT @ 16" O.C. MAX
 - + W1.7 LADDER TYPE HORIZONTAL JOINT REINFORCEMENT @ 16" O.C. MAX. + (2) #5 CONT. BOND BEAM AT TOP AND MID-HEIGHT OF WALL
 - [A]: LADDER FRAMING @ 24" O.C. MAX.



QUINNEVANS.COM



422 N. ALTADENA ROYAL OAK, MI 48067 248.561.2035



RENOVATION OF HISTORIC BLUE BIRD INN

DETROIT SOUND CONSERVANCY

1 03.03.2023 BIDS & PERMITS


No. Date Description


PROJECT MANAGER: DRAWN BY:

AL EL

CONSTRUCTION DOCUMENTS 03/03/2023

UPPER ROOF FRAMING

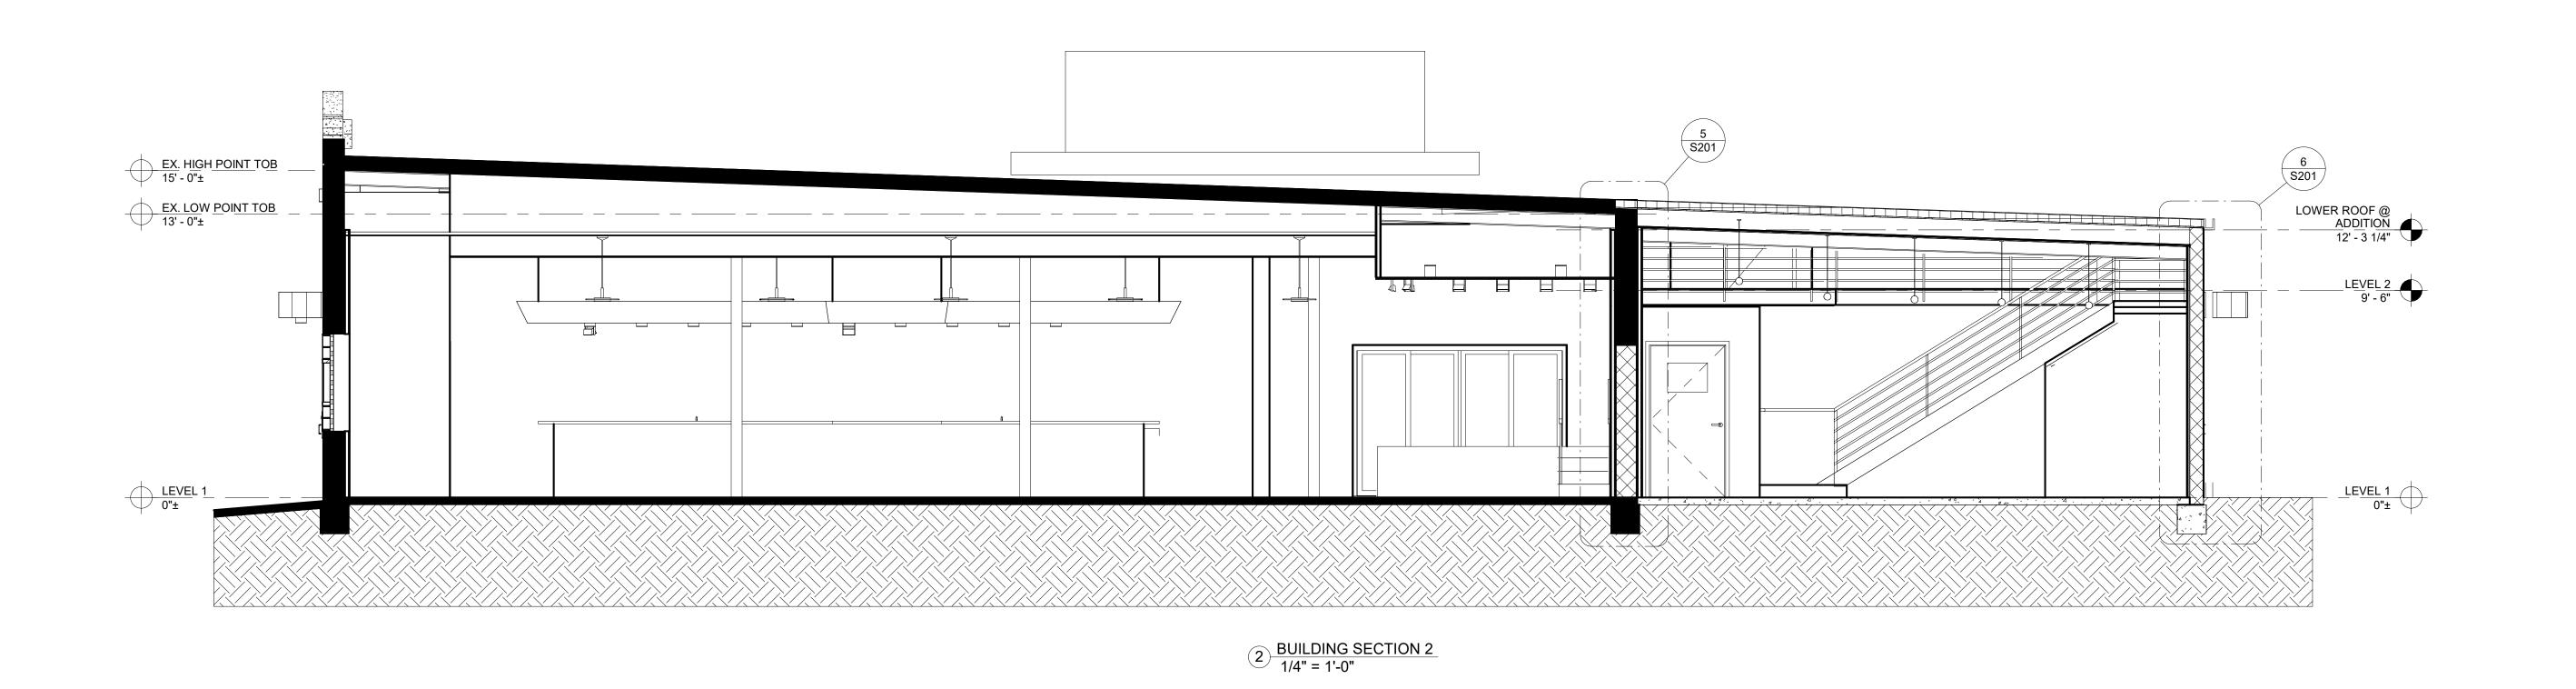

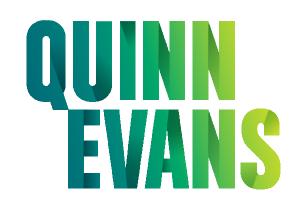



422 N. ALTADENA ROYAL OAK, MI 48067 248.561.2035



RENOVATION OF HISTORIC BLUE BIRD INN

DETROIT SOUND CONSERVANCY


1 03.03.2023 BIDS & PERMITS


	INO.	Date	Description	
PR	OJECT MAN	IAGER:	DRAWN BY:	
Α	L		EL	


CONSTRUCTION DOCUMENTS 03/03/2023

BUILDING SECTIONS



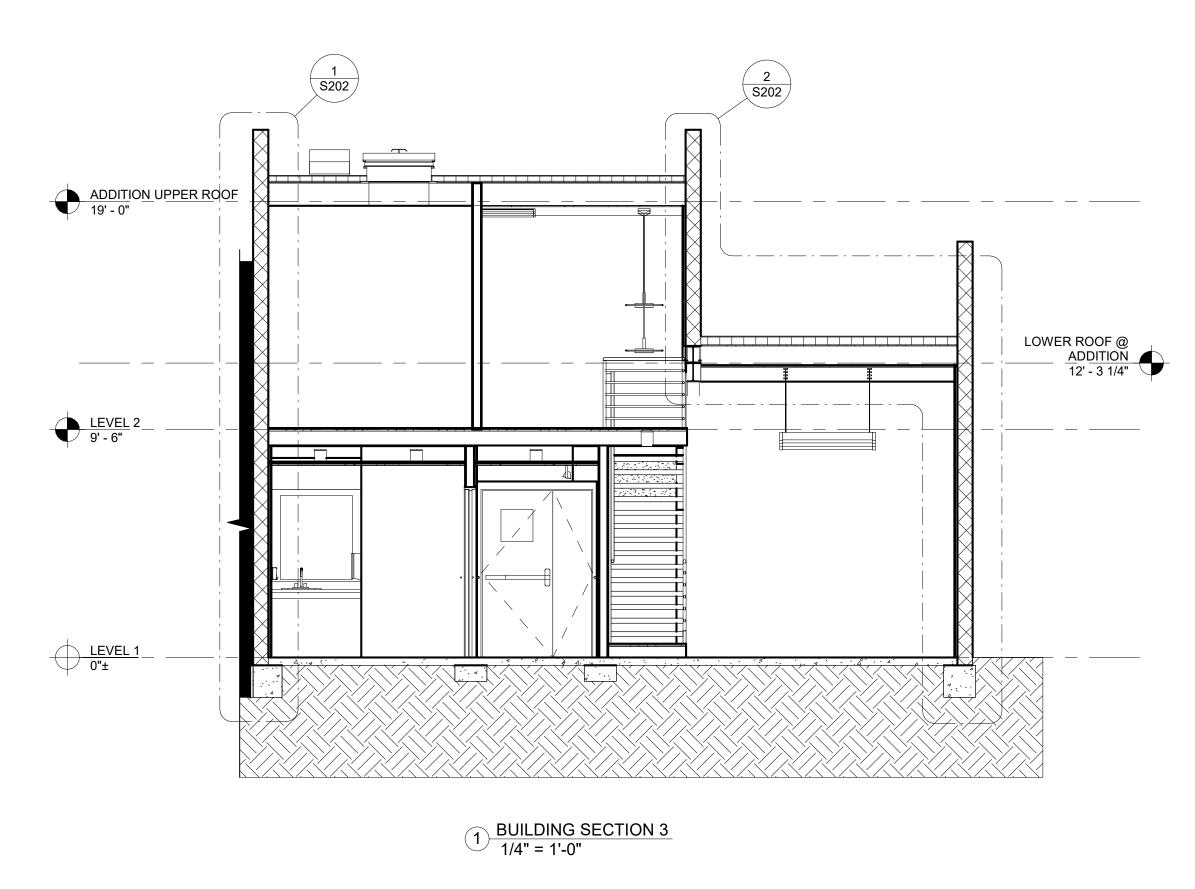

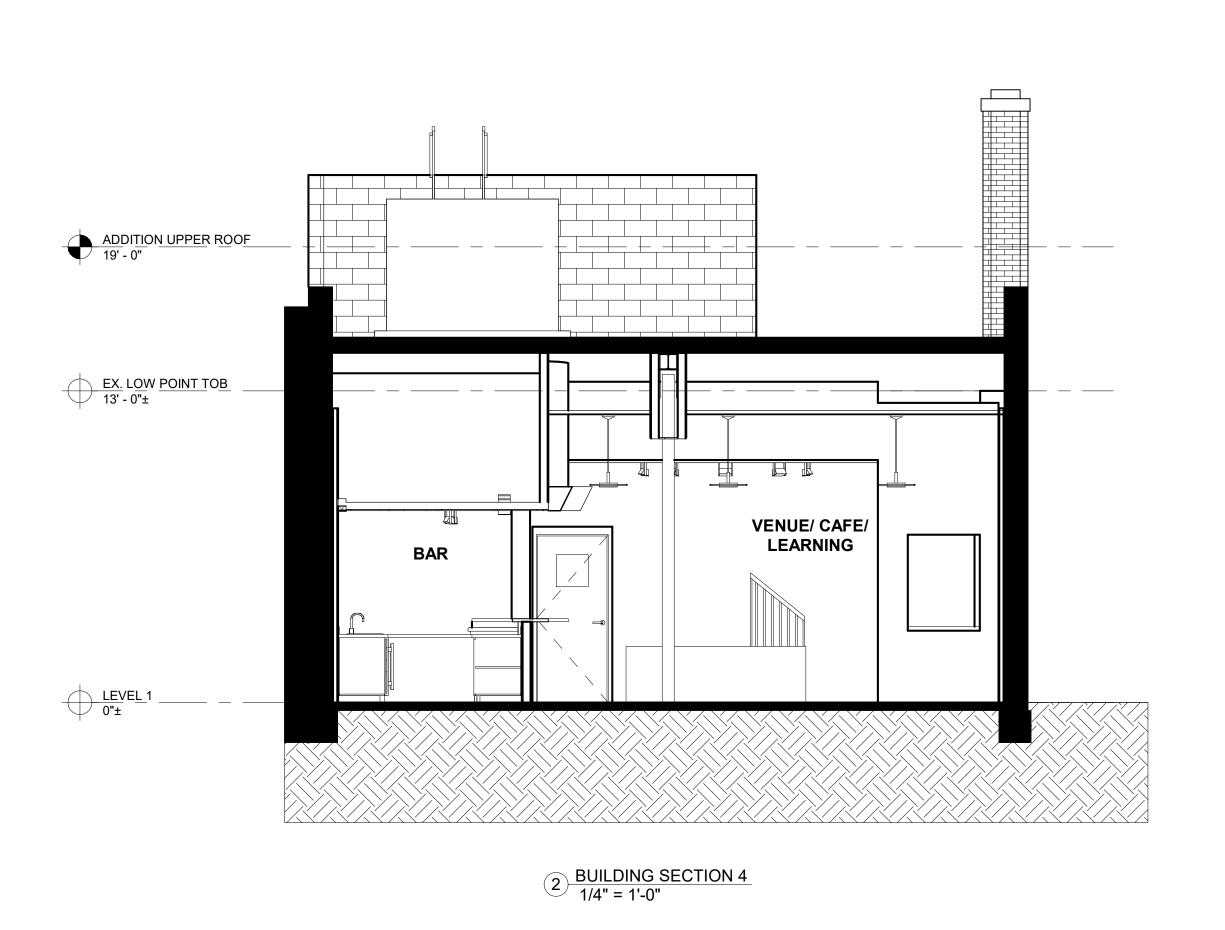


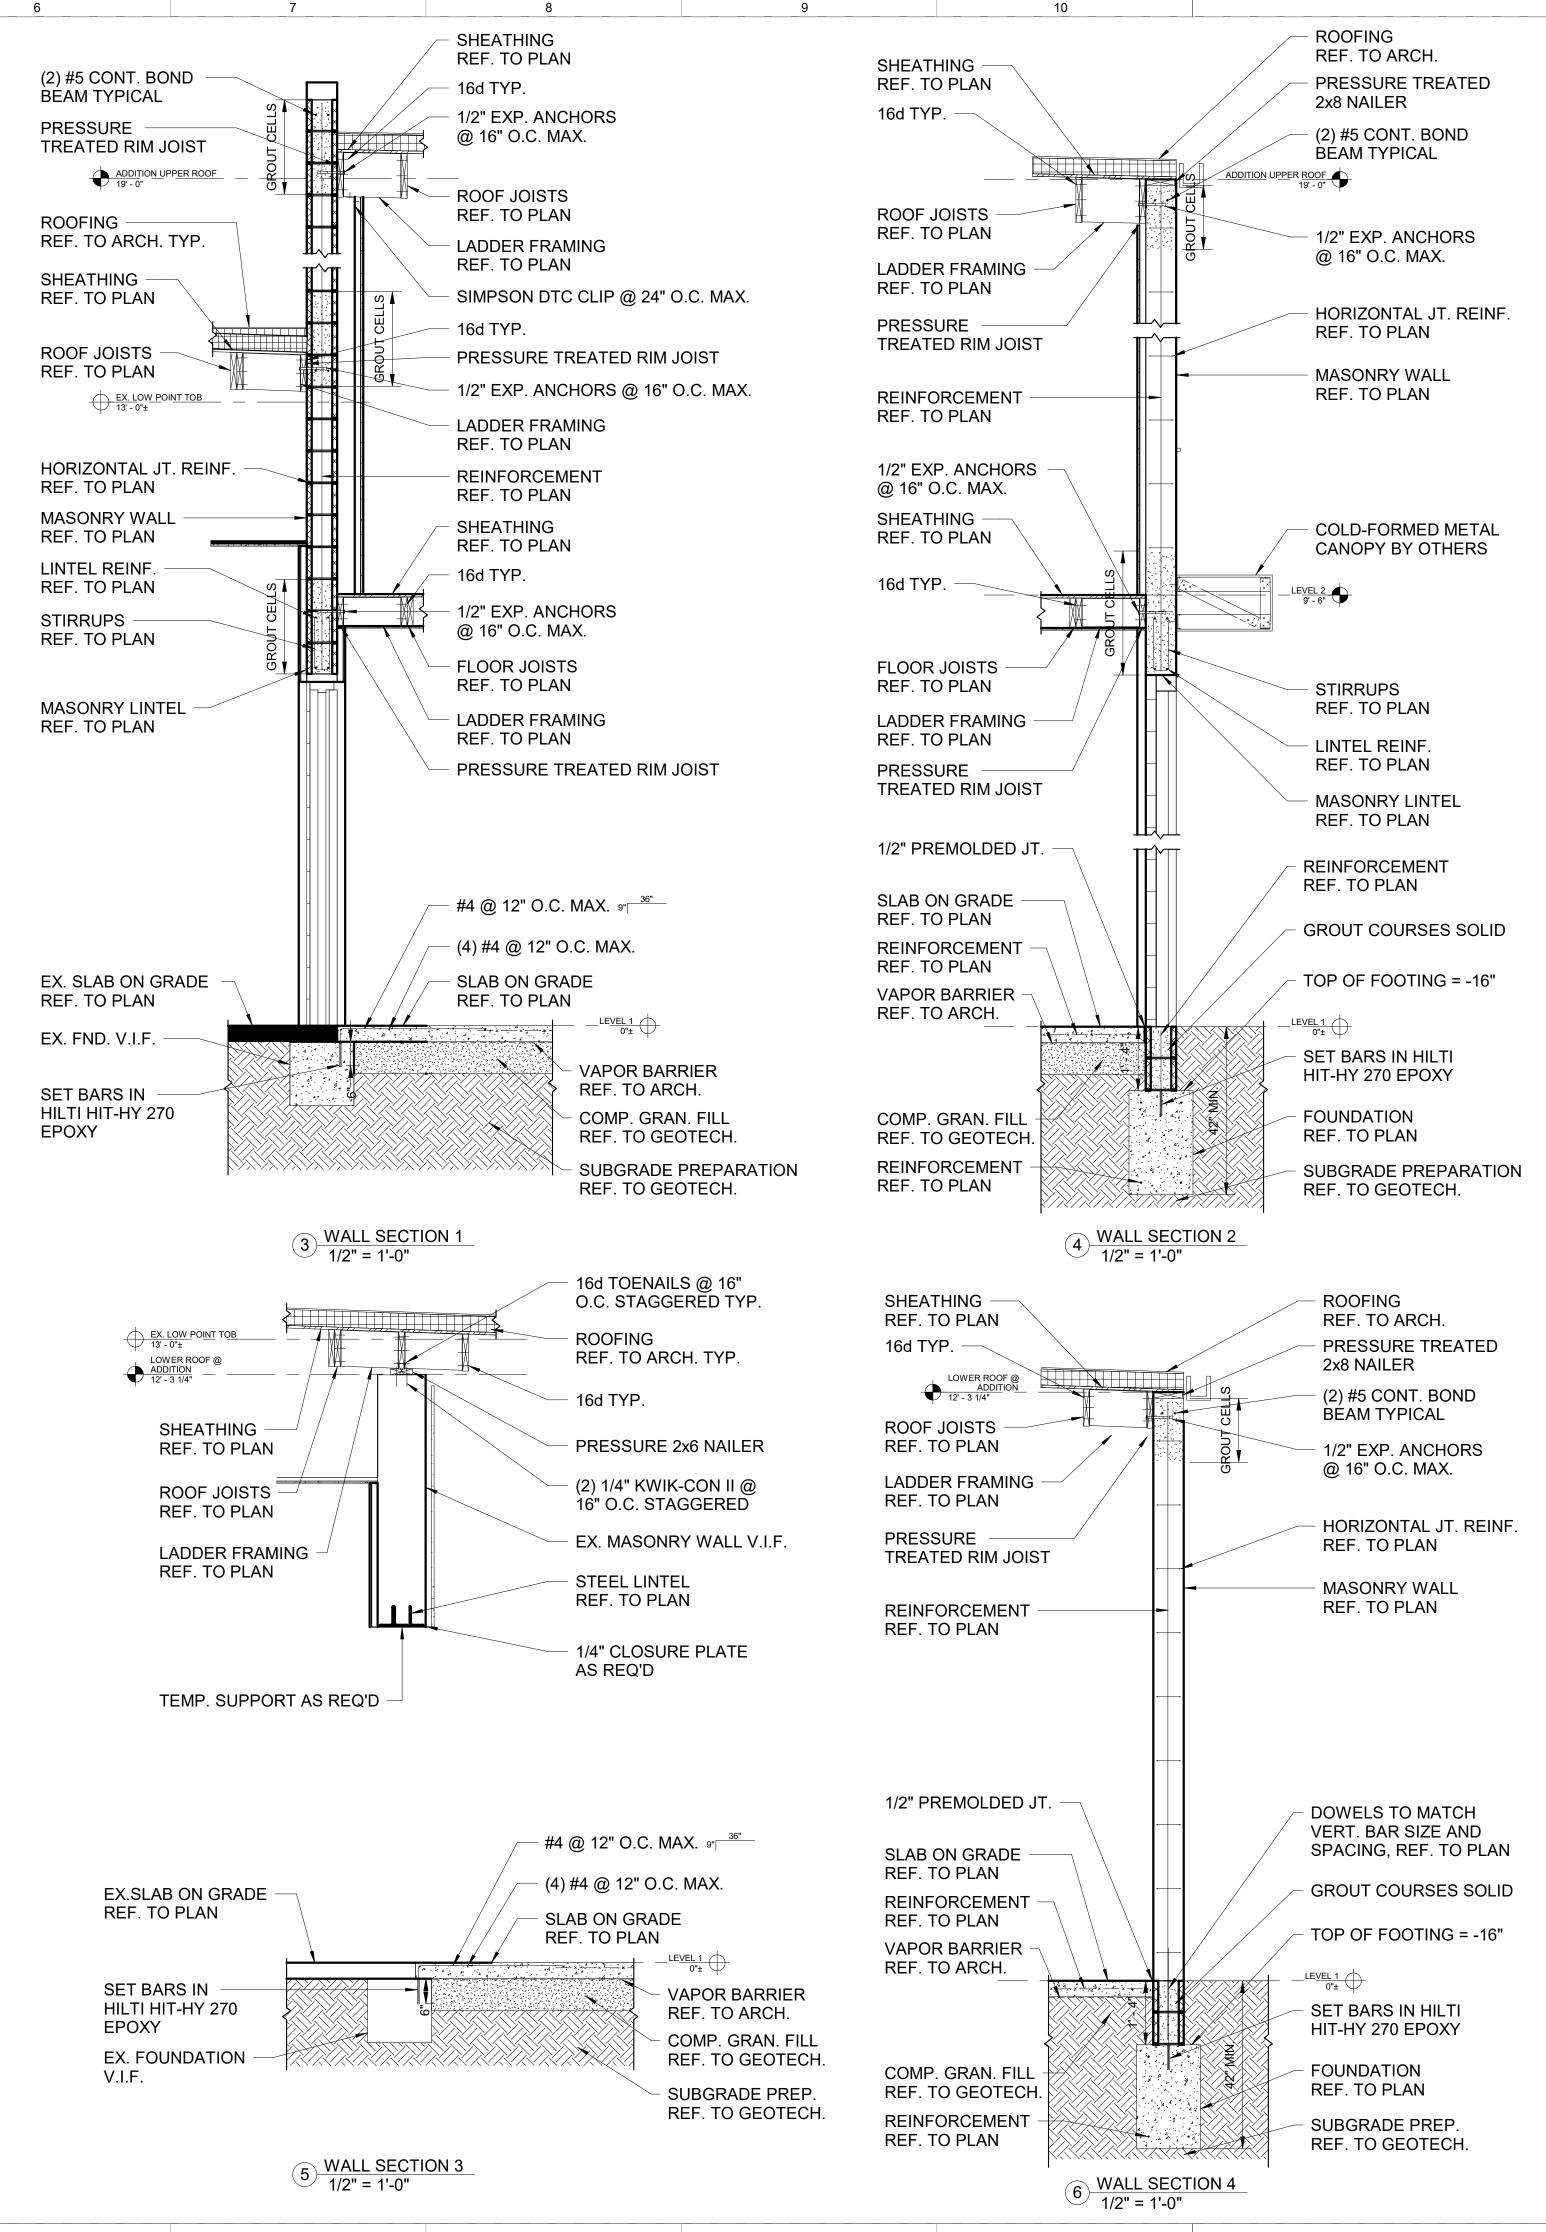





422 N. ALTADENA ROYAL OAK, MI 48067 248.561.2035

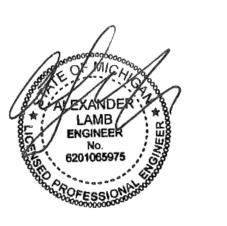

RENOVATION OF HISTORIC BLUE BIRD INN

DETROIT SOUND CONSERVANCY

1 03.03.2023 BIDS & PERMITS

PROJECT MANAGER: DRAWN BY: AI FI	No.	Date	Description		
AI FI	PROJECT M	ANAGER:	DRAWN BY:		
· \=	AL		EL		

CONSTRUCTION DOCUMENTS 03/03/2023

BUILDING & WALL SECTIONS



- 1. PROVIDE TEMPORARY SUPPORT AS REQUIRED DURING CONSTRUCTION AND DEMOLITION ACTIVITIES
- 2. VERIFY IN FIELD ALL CONDITIONS PRIOR TO PROCEEDING WITH NEW WORK
- 3. TUCK POINT ALL MORTAR JOINTS, DO NOT USE PORTLAND CEMENT BASED MORTAR MATERIALS

DESIGNATIONS:

- [A]: EXISTING STEEL BEAM DETERIORATION REMOVE EXISTING BRICKS AS REQUIRED TO EXPOSE EXISTING STEEL BEAM FOR STRUCTURAL INSPECTION. RETROFIT OF STEEL BEAM MAY BE REQUIRED.
- [B]: EXISTING STEEL LOOSE LINTEL REMOVE EXISTING PARGING FOR STRUCTURAL INSPECTION OF LOOSE LINTEL. RETROFIT OF LINTEL MAY BE REQUIRED. RECOMMEND TO PAINT LINTEL WITH ZINC RICH PRIMER AS A MINIMUM TREATMENT
- [C]: EXISTING MASONRY SILL REMOVE EXISTING PARGING FOR STRUCTURAL INSPECTION OF MASONRY SILL. RETROFIT OF SILL UNITS AND BED/PERPEND JOINTS MAY BE REQUIRED
- [D]: EXISTING MASONRY CORNICE COPING RESTORE EXISTING PRE-CAST COPING STONES WITH CONCPROCO PRODUCTS TBD [E]: EXISTING MASONRY DETAIL - REMOVE AND REPLACE EXISTING PRE-CAST DETAIL STONES
- [F]: EXISTING PARGING & MURAL REMOVE EXISTING MASONRY PARGING FOR STRUCTURAL INSPECTION OF EXISTING MASONRY WALL. FULLY DOCUMENT THE MURAL AS REQUIRED PRIOR TO REMOVAL SO THAT IT MAY BE REPLICATED AT THE OWNERS' WILL
- [G]: EXISTING MASONRY SOLDIER COURSE REMOVE ALL EMBEDDED STEEL ELEMENTS FROM EXISTING MASONRY SOLDIER COURSE. PATCH HOLES AS REQUIRED

1 FRONT FACADE ELEVATION 1 1/2" = 1'-0"



QUINNEVANS.COM



422 N. ALTADENA ROYAL OAK, MI 48067 248.561.2035



RENOVATION OF HISTORIC BLUE BIRD INN

DETROIT SOUND CONSERVANCY


1 03.03.2023 BIDS & PERMITS

PROJECT MANAGER:


CONSTRUCTION DOCUMENTS 03/03/2023

FRONT ELEVATION



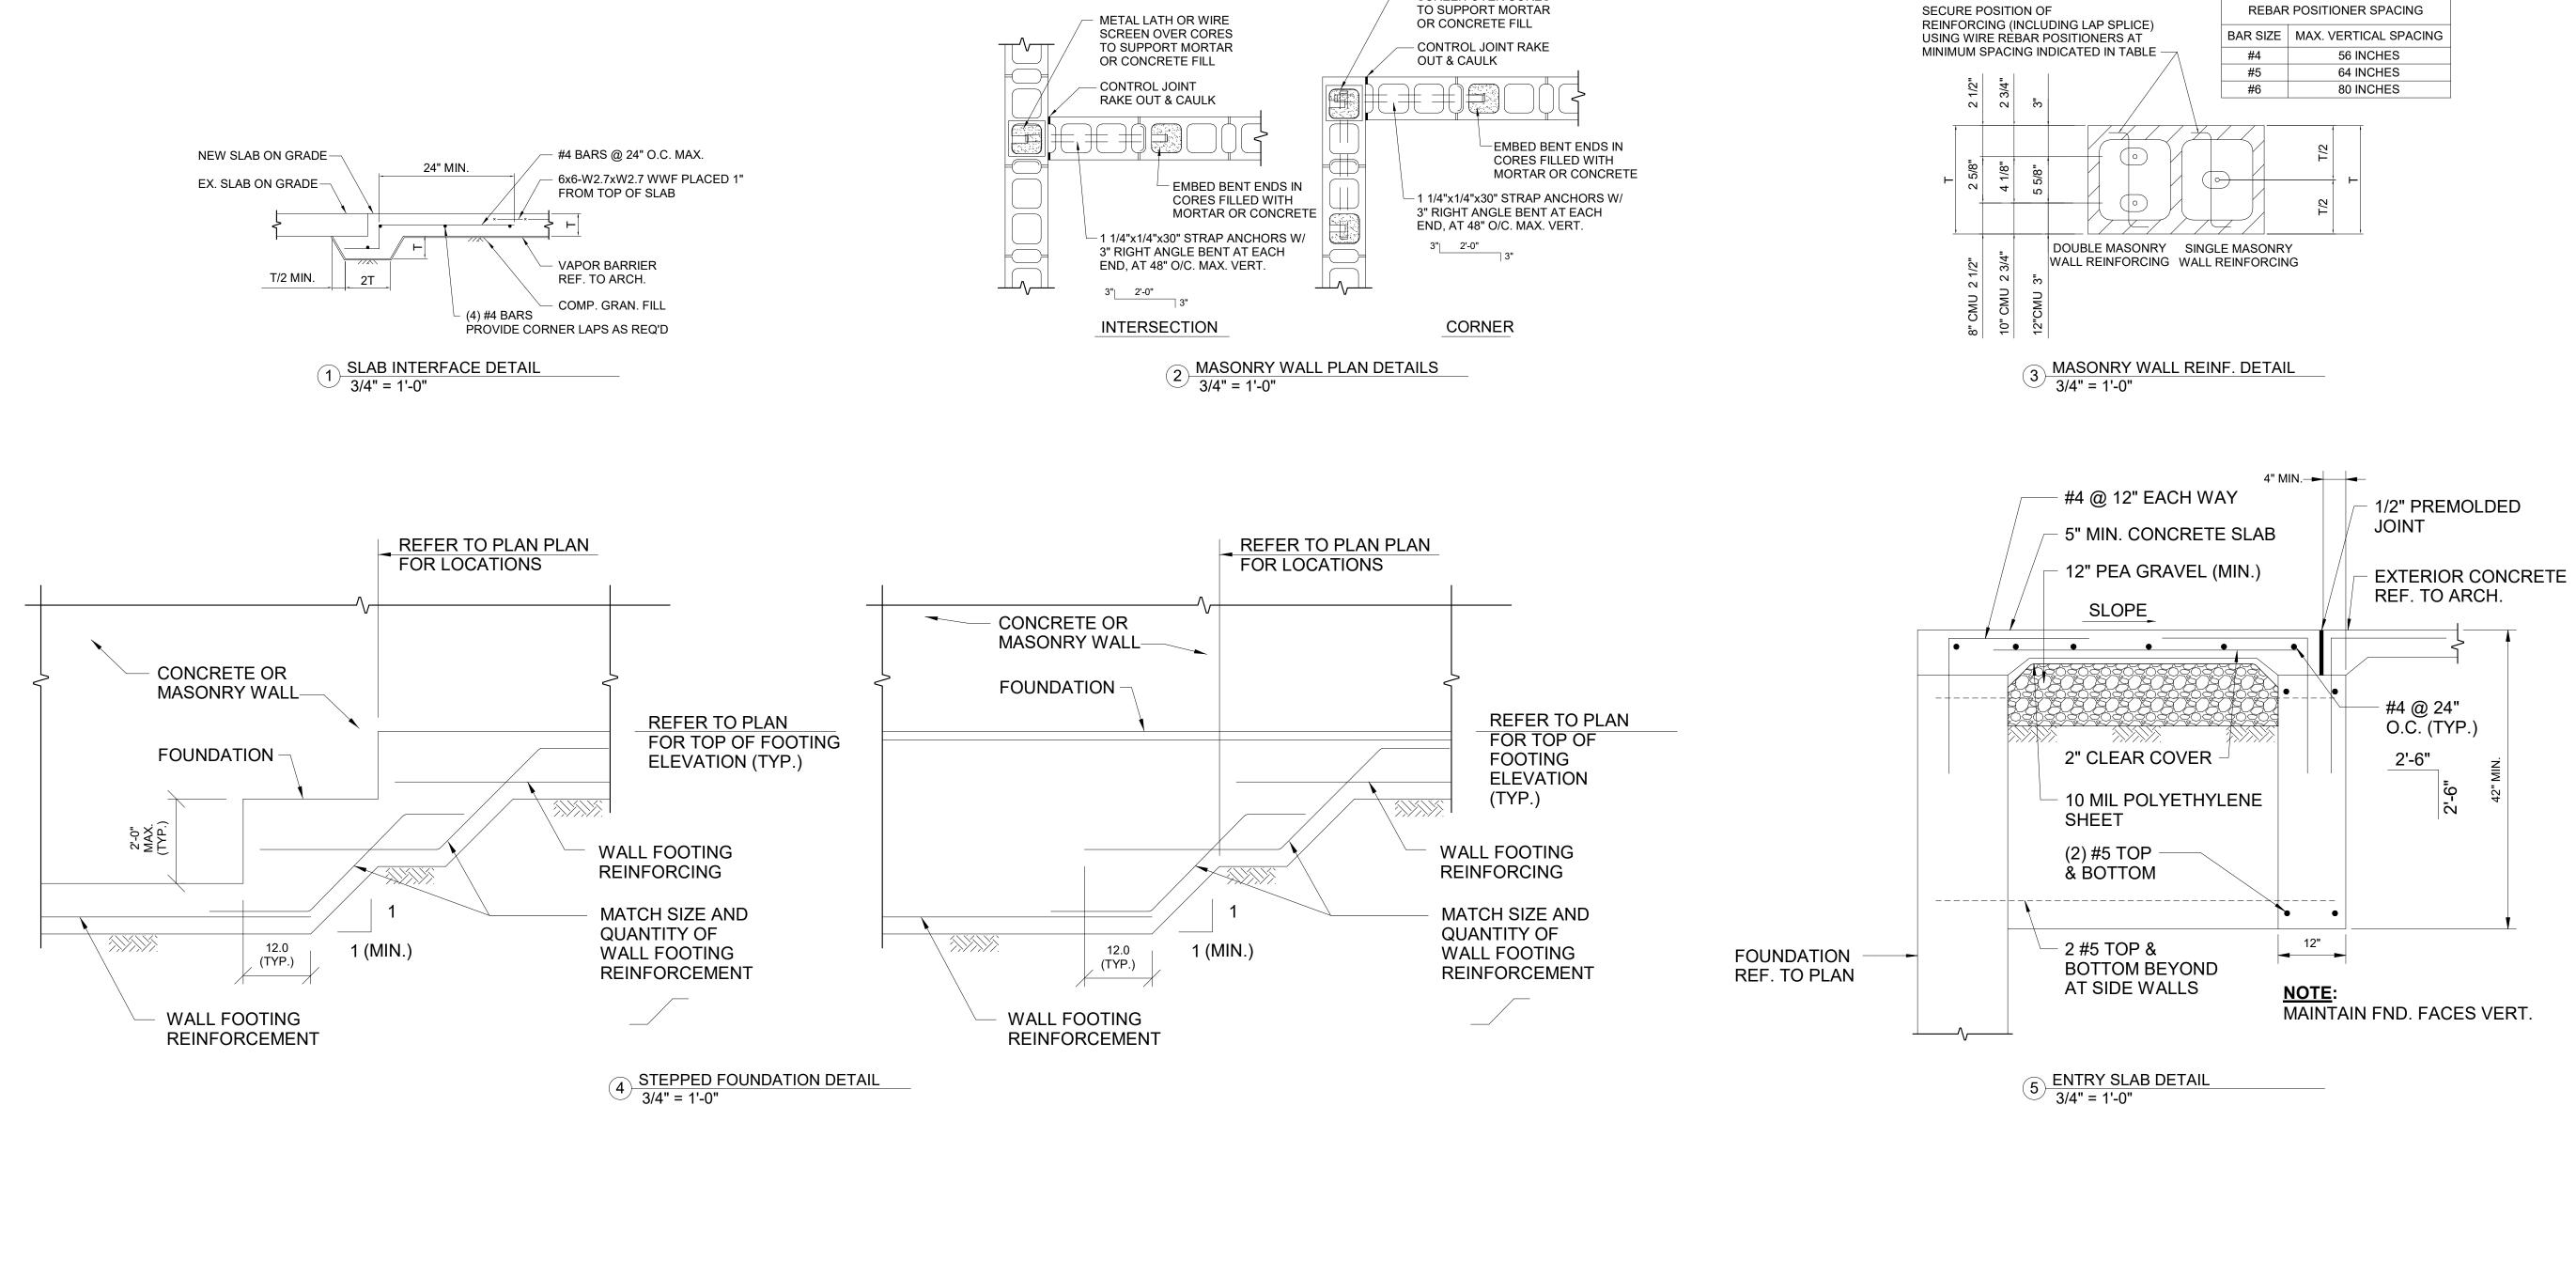

- METAL LATH OR WIRE SCREEN OVER CORES

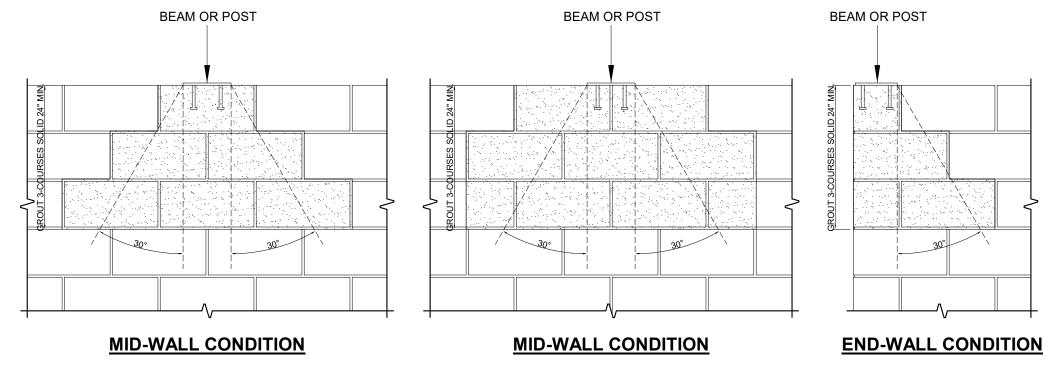

6 MAS. WALL BEARING PLATE DETAIL 3/4" = 1'-0"

QUINN EVANS

QUINNEVANS.COM



422 N. ALTADENA ROYAL OAK, MI 48067 248.561.2035



RENOVATION OF HISTORIC BLUE BIRD INN

DETROIT SOUND CONSERVANCY

1 03.03.2023 BIDS & PERMITS

No. Date Description

PROJECT MANAGER: DRAWN BY:

AL EL

CONSTRUCTION DOCUMENTS 03/03/2023

STANDARD DETAILS

NOTE: SEE MOO FOR MECHANICAL GENERAL NOTES

THIS SHEET IS FOR BID ALTERNATE ONLY FOR

BIDDING CONTRACTORS SHALL USE THIS SHEET AS A BIDDING

FOR THIS BID ALTERNATE. COORDINATE WITH STRUCTRUAL,

ARCHITECTURAL, AND OTHER MEP SHEETS

ALTERNATE TO SHEET A11. SHOULD THE OWNER SELECT THIS PLAN ALTERNATIVE, THE AWAREDED CONTRACTOR AND SUBCONTRACTOR

SHALL PROVIDE A FINAL DESIGN AND CONSTRUCTION DOCUMENTS(S)

DESIGN BUILD

QUINNEVANS.COM




RENOVATION OF HISTORIC BLUE BIRD INN

DETROIT SOUND CONSERVANCY


PERMIT / BID SET 03/10/2023

MECHANICAL NEW WORK ROOF PLAN

ALT M11

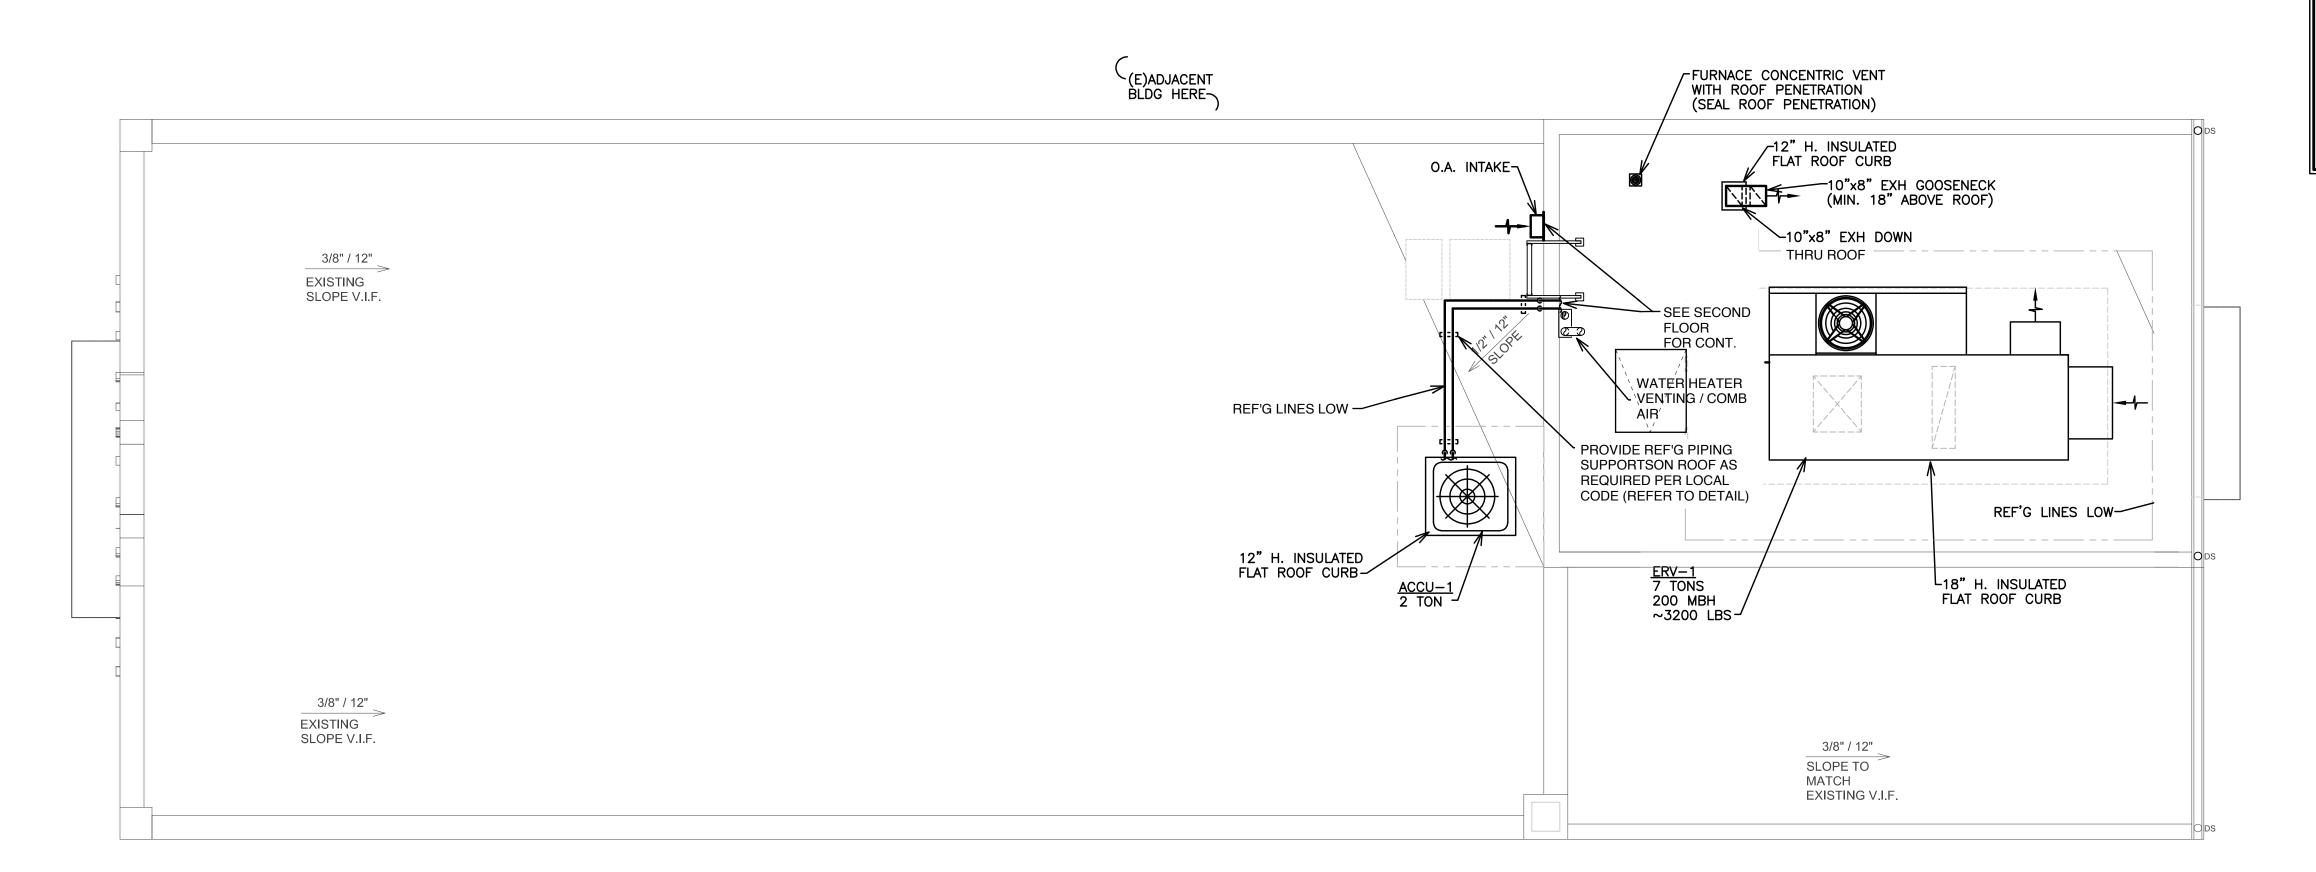

MECHANICAL NEW WORK PLAN - ROOF

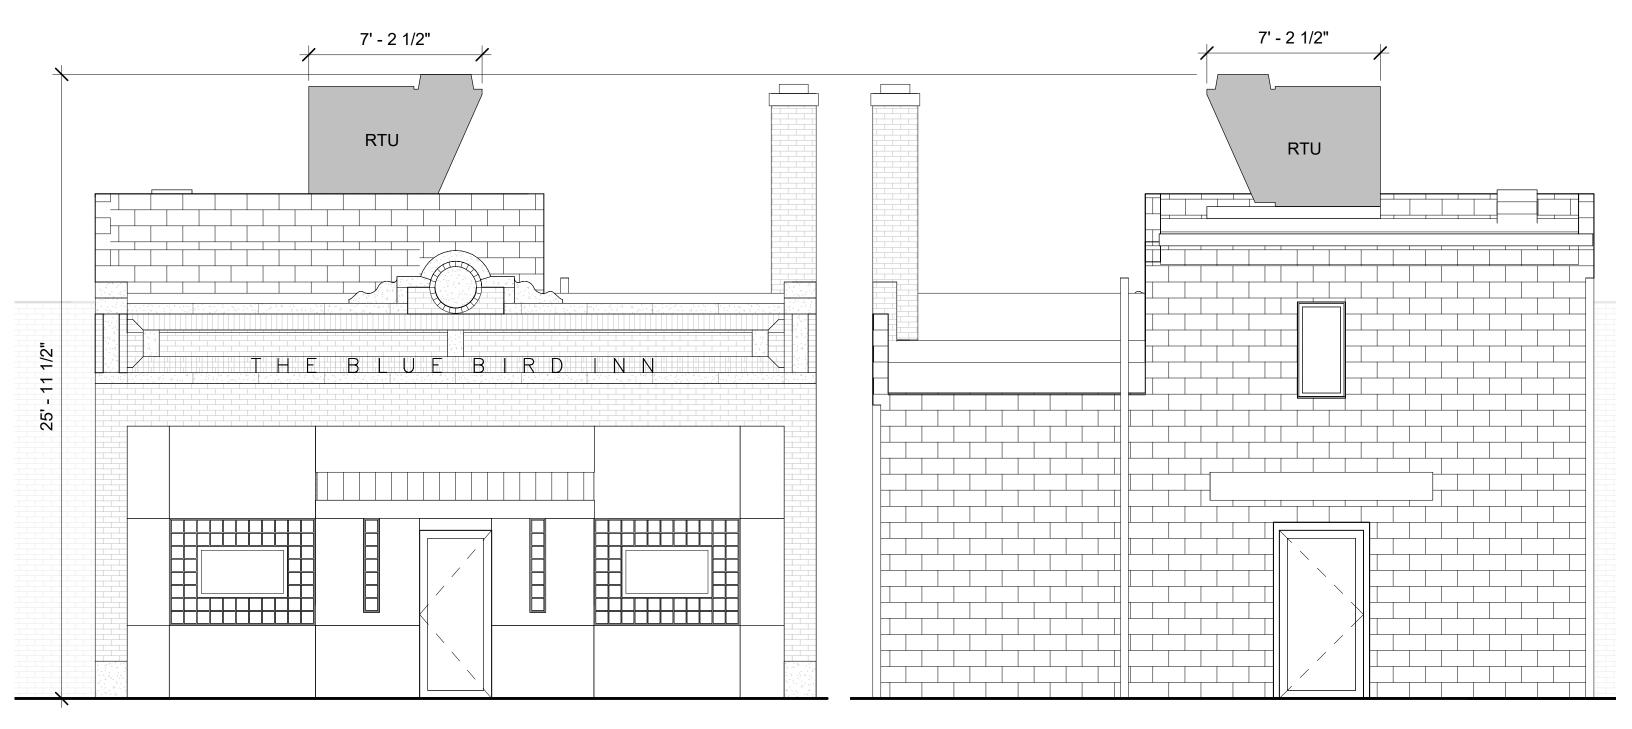




NORTH (STREET) ELEVATION W/ RTU ABOVE ADDITION






SOUTH (ALLEY) ELEVATION W/ RTU ABOVE ADDITION


1/4" = 1'-0"

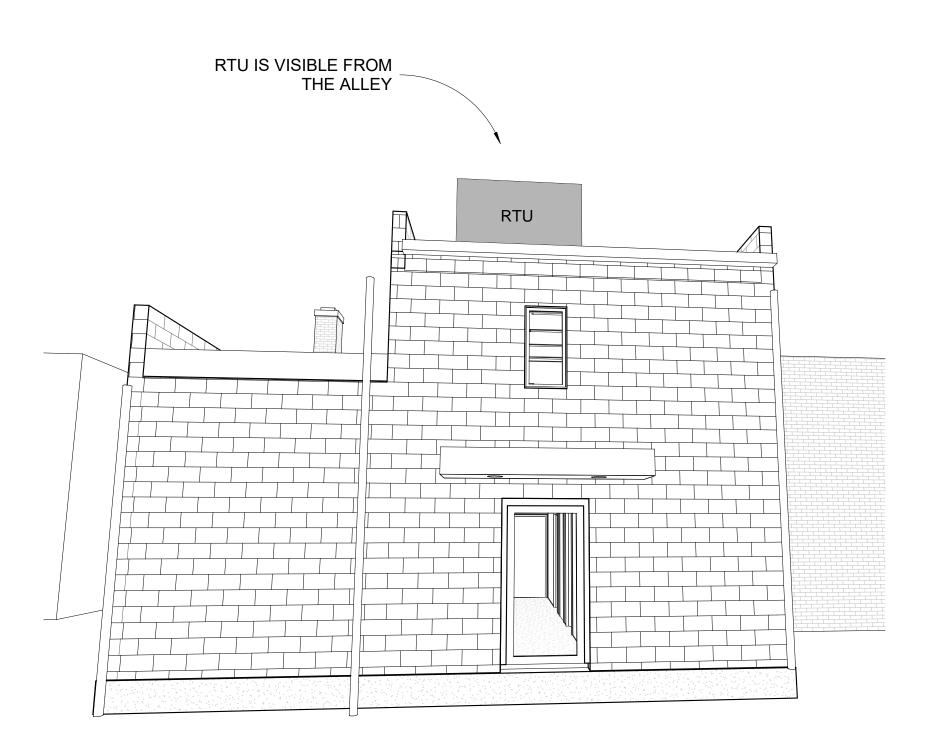

1 ALLEY VIEW (FROM MIDDLE OF ALLEY)

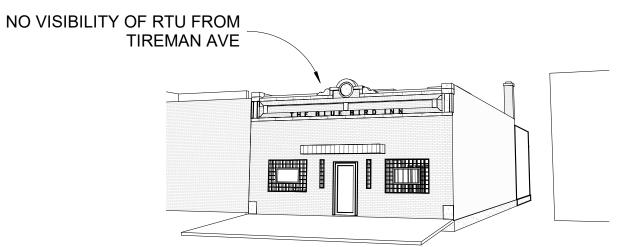


TIREMAN AVE VIEW (FROM SIDEWALK ACROSS STREET)

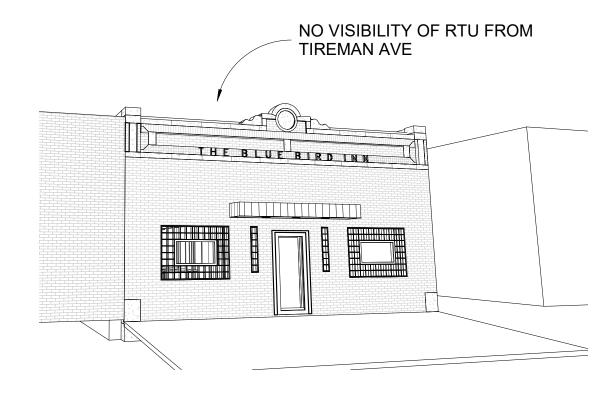

TIREMAN AVE VIEW (FROM MIDDLE OF STREET)



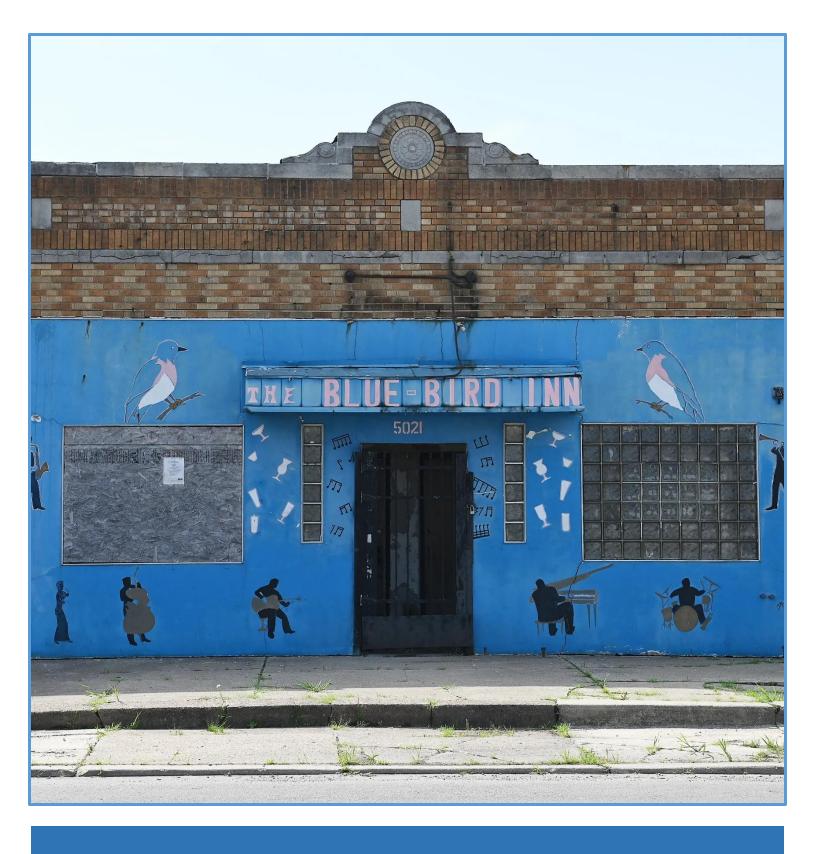

THE HISTORIC BLUE BIRD INN

Exterior Preservation Budget Detroit, Michigan







September 30, 2022

Detroit Sound Conservancy 440 Burroughs, Suite 195 Detroit, Michigan 48202

Attention: Mr. Jonah Raduns-Silverstein

projects@detroitsound.org

Regarding: Blue Bird Inn

Exterior Masonry Preservation

Detroit, Michigan

Dear Sir:

In answer to your request, we have reviewed the exterior masonry conditions of the historic Blue Bird Inn. Based on our onsite review, we have prepared a list of recommended work items and corresponding budgetary pricing. Please see the description of our proposed work activities outlined below.

Project General Conditions:

- 1. Mobilization, General Conditions, and Safety:
 - Consists of coordination and scheduling of work.
 - General labor for all clean-up, handling of materials, and site safety.
 - Assembling all required equipment and materials.
 - All aspects of safety, barricading, and proper signage.
 - Providing all equipment necessary to complete our scope of work.
 - Dumpsters and facilities.
 - Owner to provide power and water.
 - Exclusions:
 - Handling of any hazardous materials
 - Any permits required to access work areas
 - Window replacement or repair
 - o Repairs to the plaster storefront

North Elevation (Building Entrance):

2. Parapet Rebuild:

- From the top of the blue plaster wall, demo the existing masonry parapet and salvage the face brick to the highest extent possible.
- Clean and coat any exposed steel uncovered by the demolition of the parapet wall with a rust-inhibiting paint.
- Rebuild the parapet with a block back-up wall and salvaged face brick. We have budgeted to furnish new limestone banding and coping stones. We will salvage and reuse the decorative modillion/flower at the center of the parapet.

3. Brick Repointing:

- Remove all compromised mortar to a depth of at least one inch, or until sound material is achieved.
- Rinse all voids using clean water to remove any dust and/or debris.
- Repoint new mortar into the voids and properly tool each joint to a smooth and watertight finish.

4. Brick Replacement:

- Carefully remove heavily damaged brick that have cracked over time.
- Furnish and install brick with new mortar to match the existing wall.

5. Stone Column Base Replacement:

- Carefully remove damaged masonry area at the base of the columns that have cracked over time.
- Furnish and install a new limestone piece with new mortar.

West Elevation (Alley):

6. Brick Repointing:

- Remove all compromised mortar to a depth of at least one inch, or until sound material is achieved.
- Rinse all voids using clean water to remove any dust and/or debris.
- Repoint new mortar into the voids and properly tool each joint to a smooth and watertight finish.

7. Brick Replacement:

- Carefully remove heavily damaged brick that have cracked over time.
- Furnish and install brick with new mortar to match the existing wall.

South Elevation (Backside):

8. New Masonry Addition:

- Lay-out new masonry walls at the backside of the building. We have budgeted for a 15-ft long by 30-ft high addition.
- Furnish and install new CMU blocks and necessary reinforcement.
- Furnish and install a new brick veneer at the outside walls.
- Complete a full cleaning of the addition upon completion of the work.

9. Chimney Rebuild:


- Carefully remove the coping and the exterior wythe of brick down to the roofline.
- Furnish and install brick with new mortar to match the existing wall.
- Furnish and install a new coping and clean the surfaces of the chimney.

10. Brick Repointing:

- Remove all compromised mortar to a depth of at least one inch, or until sound material is achieved.
- Rinse all voids using clean water to remove any dust and/or debris.
- Repoint new mortar into the voids and properly tool each joint to a smooth and watertight finish.

II. Brick Replacement:

- Carefully remove heavily damaged brick that have cracked over time.
- Furnish and install brick with new mortar to match the existing wall.

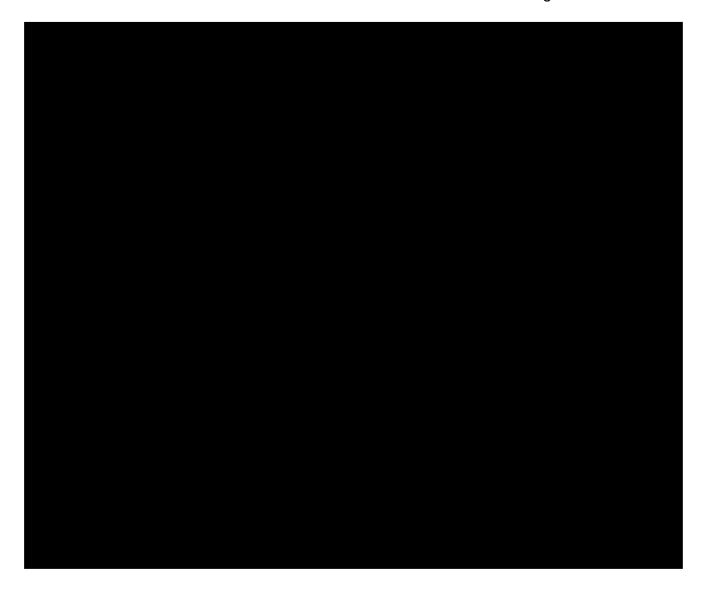







We appreciate the opportunity to partner with the Conservancy on the preservation of this historic building. Please contact our team with any questions or concerns relating to our proposal.

Respectfully,

RAM Construction Services of Michigan, Inc.

Dave Kramer DK/ah/22-032



August 1, 2022

Jonah Raduns-Silverstein
Director of Operations
Detroit Sound Conservancy
projects@detroitsound.org

RE: Blue Bird Inn - 5021 Tireman Detroit MI. Front elevation masonry facade restoration

- Mobilize the front elevation of the masonry facade with proper scaffolding and equipment.
- Remove all deteriorated stone from the front masonry facade including all stone belts, coping stone and ornate stone pieces.
- * Fabricate new limestone units and Install using proper methods back to its original profile.
- Remove all loose,missing or damaged brick units and replace with new brick units matching as close as possible.
- ❖ Tuck point all missing and deteriorated mortar joints of the masonry on the entire front elevation.
- Prepare control joints of new stone coping caps and install new backer rod and sealant.
- Wash all areas where work was performed.
- Clean up of the jobsite.



This proposal includes all labor, materials and taxes and will remain in effect for sixty (60) days from the above date.

Sincerely,

Pat Curry
JMD Building Restoration
pat.curry@imdbuildingrestoration.com



ESTIMATE Report ID: **223542** Job ID: 5021 tireman 7/24/2022

Lakeside Painting And Plaster Repair

C Williamson - Estimator

Cert #: United States License #: Mi

lakesideppr@gmail.com WWW.LAKESIDEPAINT.COM

Property

5021 Tireman St, Detroit, MI 48204

FRONT OF BUILDING

Description	QTY	UOM	PPU	Total
1 Small plaster crack repair - up to 1ft	7	EA		
2 Plaster crack repair - up to 5ft	1	EA		
3 plaster crack - up to 2ft	4	EA		
4 plaster crack - up to 3ft	3	EA		
5 stucco patch up to 5 SF	1	EA		
6 skim stucco	78	EA		
7 Apply primer to prepped walls	112	SF		
		Area		
		Sub		
		Estimat		
	Es	timate ⁻		
		-		

Signature: Date:



This information is an itemized estimate for repair to the property located at the above captioned address. This estimate has been prepared with the intention of restoring this property to its' "pre-damaged" condition. The scope of repair, as outlined in this estimate, has been formulated based upon non-destructive observation only. Therefore, only the items specifically mentioned here have been included in this estimate for repair.

It is our intention that this estimate be as thorough and accurate as possible. However, upon demolition of the affected areas, we reserve the right to make a re-evaluation of the damage. Should any hidden and/or additional damage be discovered or any other additional work or repair become necessary, for any reason, an addendum and/or modification to this document will be added to this estimate.

A deposit of 50% of the balance is required on the first day of job start.