DHDC 22-7735

APPROVAL DOCUMENT - POST AT WORK LOCATION

CITY OF DETROIT HISTORIC DISTRICT COMMISSION 2 WOODWARD, SUITE 808 DETROIT, MICHIGAN 48226

04/19/2022

CERTIFICATE OF APPROPRIATENESS

Timothy Flintoff 4545 Architecture 3011 W. Grand Boulevard, Suite 400 Detroit, MI 48202

RE: Application Number 22-7735; 1416-1444 Michigan Avenue; Corktown Historic District Project Scope: Erect Roof/Side Additions, Other Exterior Alterations

Dear Applicant,

At the Regular Meeting that was held on April 13, 2022 the Detroit Historic District Commission ("DHDC") reviewed the above-referenced application. Pursuant to Section 5(1) of the Michigan Local Historic District Act, as amended, being MCL 399.205 (1) and Sections 21-2-73/21-2-78 of the 2019 Detroit City Code; the DHDC hereby issues a Certificate of Appropriateness ("COA") for the following work, effective on April 19, 2022 as it meets the Secretary of Interior's Standards for Rehabilitation and the district's Elements of Design:

Erect roof/side additions, other exterior alterations, per submitted drawings, documents, and narrative.

Please retain this COA for your files and post it at the subject property until work is complete. It is important to note that approval by the DHDC does not waive the applicant's responsibility to comply with any other applicable ordinances or statutes. If you have any questions regarding the foregoing, please contact staff at 313-224-1762 or hdc@detroitmi.gov.

For the Commission:

Garrick B. Landsberg, Director Detroit Historic District Commission

THIS IS A 3-PAGE FORM - ALL INFORMATION IS REQUIRED FOR PROJECT REVIEW

HISTORIC DISTRICT COMMISSION PROJECT REVIEW REQUEST

DATE: 04/06/2022

City of Detroit - Planning & Development Department 2 Woodward Avenue, Suite 808 Detroit, Michigan 48226

PROPERTY INFORMATION					
ADDRESS(ES): 1444 Michigan Ave, Detroit, MI 48216 AKA:					
PARCEL ID: 06000405 HISTORIC DISTRICT: Corktown					
SCOPE OF WORK: Windows/ Walls/ Painting Roof/Gut Chimney Chimney Demolition Signage New Building Signage Signage Signage Roof/Gut Roof	Balcony Addition				
BRIEF PROJECT DESCRIPTION: Rooftop addition and roof deck, new garage at rear/side of building. Rooftop addition and roof deck, new garage at rear/side of building.					
APPLICANT IDENTIFICATION					
Property Owner/ Homeowner Contractor Tenant or Business Oc NAME: Timothy Flintoff COMPANY NAM	Architect/Engineer/Consultant 1E:4545 Architecture				
ADDRESS: 3011 W. Grand Blvd, Suite 4@ CITY: Detroit	STATE:MI ZIP: 48202				
PHONE: 313-450-4545 MOBILE: 248-320-6098	EMAIL: tim.flintoff@4545architectu				
PROJECT REVIEW REQUEST CHECKLIST					
Please attach the following documentation to your request: *PLEASE KEEP FILE SIZE OF ENTIRE SUBMISSION UNDER 30MB* Completed Building Permit Application (highlighted portions only)	NOTE: Based on the scope of work, additional documentation may be required.				
ePLANS Permit Number (only applicable if you've already applied for permits through ePLANS)	See www.detroitmi.gov/hdc for scope-				
Current Photographs: Including the front of the building & detailed photographs of the area(s) affected by the proposed work. All photographs must be labeled or captioned, e.g. "west wall", "second floor window," etc					
Description of existing conditions (including materials and design)					
Description of project (if replacing any existing material(s), include an explanation as to why replacementrather than repairof existing and/or construction of new is required)					
Detailed scope of work (formatted as bulleted list)					
Brochure/cut sheets for proposed replacement material(s) and/	or product(s), as applicable				

SUBMIT COMPLETED REQUESTS TO: HDC@DETROITMI.GOV

Upon receipt of this documentation, staff will review and inform you of the next steps toward obtaining your building

permit from the Buildings, Safety Engineering and Environmental Department (BSEtED) to perform the work.

P2 - BUILDING PERMIT APPLICATION

PROPERTY INFORMATION Address: 1444 Michigan Ave, Detroit, MI 48216 Floor: Suite#: Stories: 3 Lot(s): 1 Subdivision: Parcel ID#(s): 06000405 Total Acres: 0.134 Lot Width: 40' Lot Depth: 146' Current Legal Use of Property: Business Proposed Use: Business Are there any existing buildings or structures on this parcel? Yes PROJECT INFORMATION New Alteration ■ Addition Demolition Correct Violations **Permit Type:** Foundation Only Change of Use Temporary Use Other: (Original permit has been issued and is active) Revision to Original Permit #: **Description of Work** (Describe in detail proposed work and use of property, attach work list) renovate the interior of the 2nd floor to create an event space. Additionally, we are planning to construct a new 3rd floor expanding the approximately 750 sq.ft. 3rdfloor adding an additional 650 sq.ft. and creating a roof terrace with access to a 2ndterrace on the roof of the 3rd floor via an exterior stair. MBC use change ■ No MBC use change **Included Improvements** (Check all applicable; these trade areas require separate permit applications) Plumbing Fire Sprinkler System Fire Alarm HVAC/Mechanical Electrical Structure Type New Building Existing Structure Tenant Space Garage/Accessory Building Other: Size of Structure to be Demolished (LxWxH) N/A cubic ft. Construction involves changes to the floor plan? (e.g. interior demolition or construction to new walls) Use Group: B-Business Type of Construction (per current MI Bldg Code Table 601) V-B Estimated Cost of Construction \$ 946,000 Structure Use Residential-Number of Units: Office-Gross Floor Area Industrial-Gross Floor Area Commercial-Gross Floor Area: 8,060 Institutional-Gross Floor Area Other-Gross Floor Area Proposed No. of Employees: N/A List materials to be stored in the building: N/APLOT PLAN SHALL BE submitted on separate sheets and shall show all easements and measurements (must be correct and in detail). SHOW ALL streets abutting lot, indicate front of lot, show all buildings, existing and proposed distances to lot lines. (Building Permit Application Continues on Next Page) For Building Department Use Only Fees Due: DngBld? No Intake By: Permit Description: Current Legal Land Use: Proposed Use: Permit#: _____ Date Permit Issued: _____ Permit Cost: \$ _____ Zoning Grant(s): Zoning District: Lots Combined? Yes No (attach zoning clearance) Revised Cost (revised permit applications only) Old \$ _____ New \$ ____
 Structural:
 ______ Notes:
 _____ Notes: _____ Zoning: Date: _____ Notes: ____ Other:

P2 - BUILDING PERMIT

IDENTIFICATION (All Fields Required	l)			
Property Owner/Homeowner	roperty Own	er/Homeowne	er is Permit A	pplicant
Name: Anthony O'Donnell	Comp	any Name: _		
Address: 1444 Michigan Ave.	City: D	etroit	_ _{State:} MI	_zip: 48216
Phone: 313-378-0261	Mobile	e: <u>313-378-0</u>	261	
Driver's License #:	Email:	anthonytodo	onnell@gma	ail.com
Contractor Contractor is Permit A				
Representative Name:	Con	npany Name:		
Address:				
Phone: Mobile:		Email:		
City of Detroit License #:				
TENANT OR BUSINESS OCCUPANT	· Ten	ant is Permit A	pplicant	
Name: Phone:				
ARCHITECT/ENGINEER/CONSULTA Name: Timothy R. Flintoff Jr. State	Registration#	#: 1301064083	3 Expiration	Date: 04/21/2023
Address: 4545 Commonwealth St.	City: Di	- LIOIL	State: IVII	_Zip: 40200
Phone: 313-450-4545 Mobile: 248-	320-6098	Email: III	n.iiintoii@45458	architecture.com
HOMEOWNER AFFIDAVIT (Only r	required for res	idential permits	obtained by hor	meowner.)
I hereby certify that I am the legal owner and on this permit application shall be completed requirements of the City of Detroit and take for inspections related to the installation/work he other person, firm or corporation any portion	I by me. I am ull responsibi erein describe of the work o	familiar with table for all coded. I shall neith covered by this	he applicable e compliance ner hire nor su s building per	codes and , fees and ıb-contract to any mit.
Print Name: S	ignature:			Date:
Subscribed and sworn to before me this	day of	20A.D)	County, Michigan
Signature:		My Commis	ssion Expires:	
(Notary Public)				
PERMIT AF	PPLICANT S	IGNATURE		
I hereby certify that the information on this a restrictions that may apply to this construction certify that the proposed work is authorized to make this application as the property own all applicable laws and ordinances of jurisdic inspections are requested and conducted the previous inspection and that expired property of the previous inspection and that expired property is a property of the previous inspection and that expired property of the previous inspection and the property of the p	on and am average by the owner of the owner	vare of my res r of the record zed agent. Ful vare that a pe lays of the da	ponsibility the dand I have be the I agree to the principle of the princip	ereunder. I been authorized to conform to bire when no
Print Name: Timothy R. Flintoff Jr. S	ignature:			Date: 04/06/2022
(Permit Applicant)				
Driver's License #: F453793745714		iration: $09/1$		
Subscribed and sworn to before me this				County, Michigan
Signature: (Notary Public)	My Com	nmission Expir	es:	
Section 22a of the state construe	tion code s		072DA220 N/	ICI 125 1522 A


Section 23a of the state construction code act of 1972, 1972PA230, MCL 125.1523A, prohibits a person from conspiring to circumvent the licensing requirements of this state relating to persons who are to perform work on a residential building or a residential structure. Visitors of Section 23a are subject to civil fines.

This application can also be completed online. Visit detroitmi.gov/bseed/elaps for more information.



HISTORIC DISTRICT COMMISSION REVIEW & PERMIT PROCESS

SUBMIT COMPLETE APPLICATION TO HDC STAFF

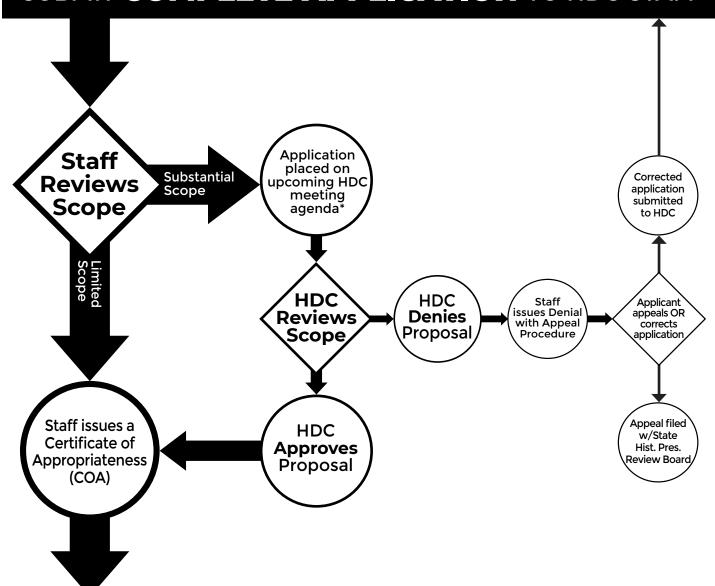

OBTAIN BUILDING PERMIT


FROM BUILDINGS, SAFETY ENGINEERING AND ENVIRONMENTAL DEPT. (BSEED)


FIND OUT MORE AT: WWW.detroitmi.gov/hdc

^{*} THE **COMMISSION MEETS REGULARY AT LEAST ONCE PER MONTH,** TYPICALLY ON THE SECOND WEDNESDAY OF THE MONTH.

(SEE WEBSITE FOR MEETING SCHEDULE/AGENDAS)



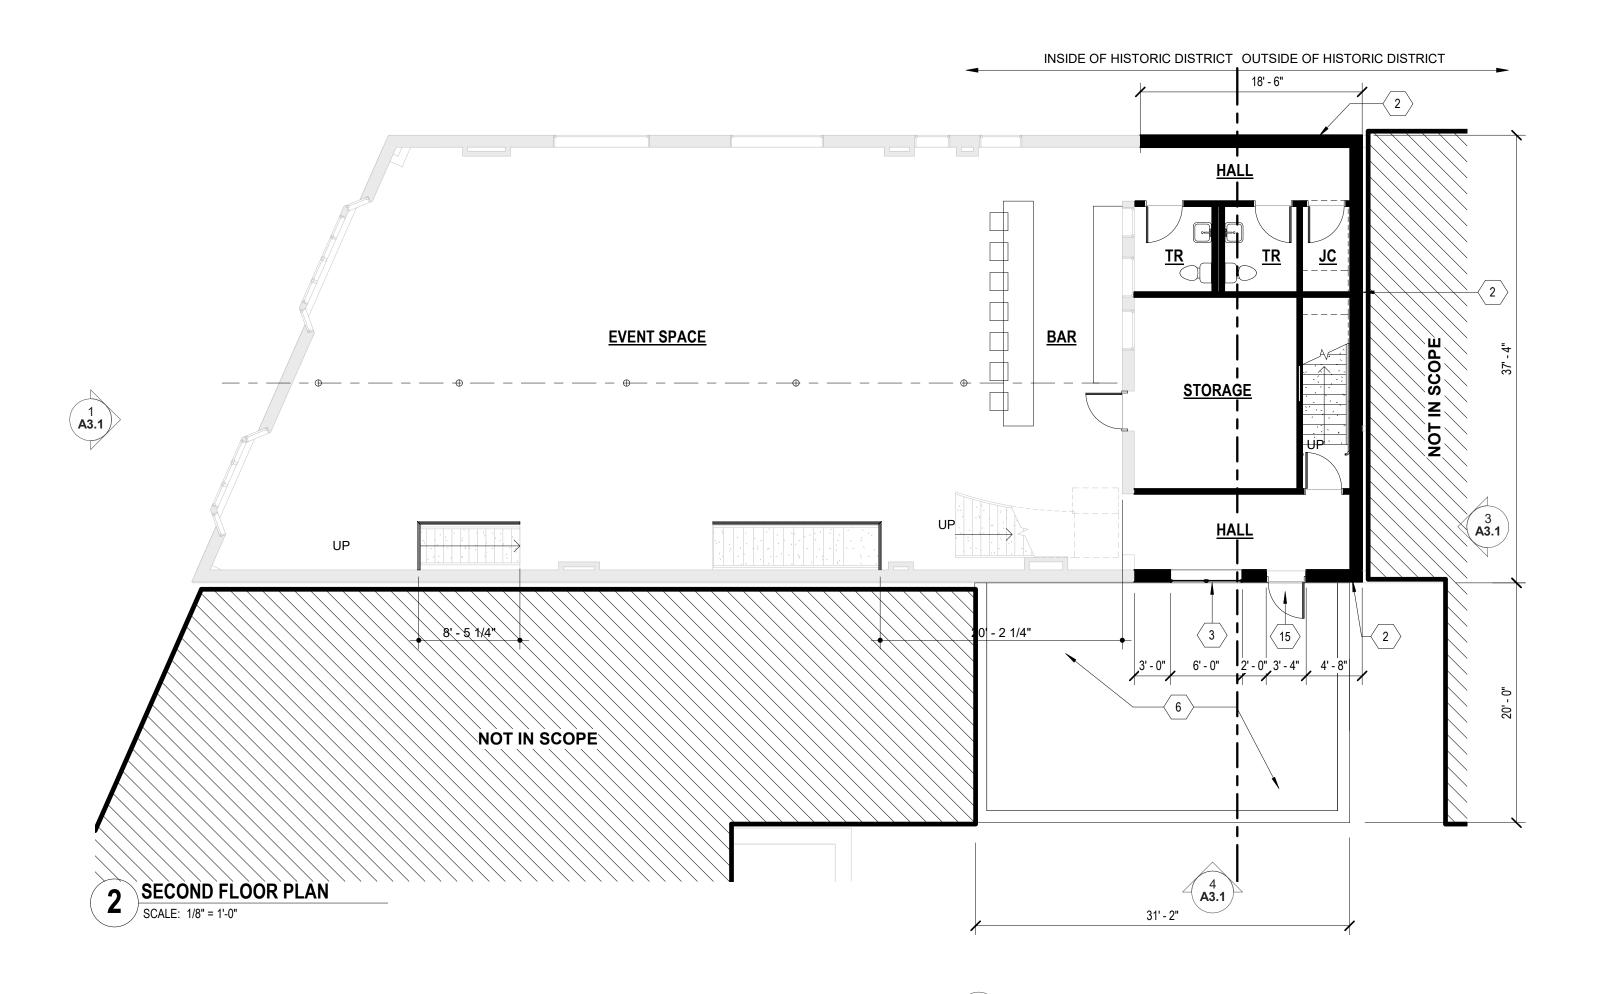

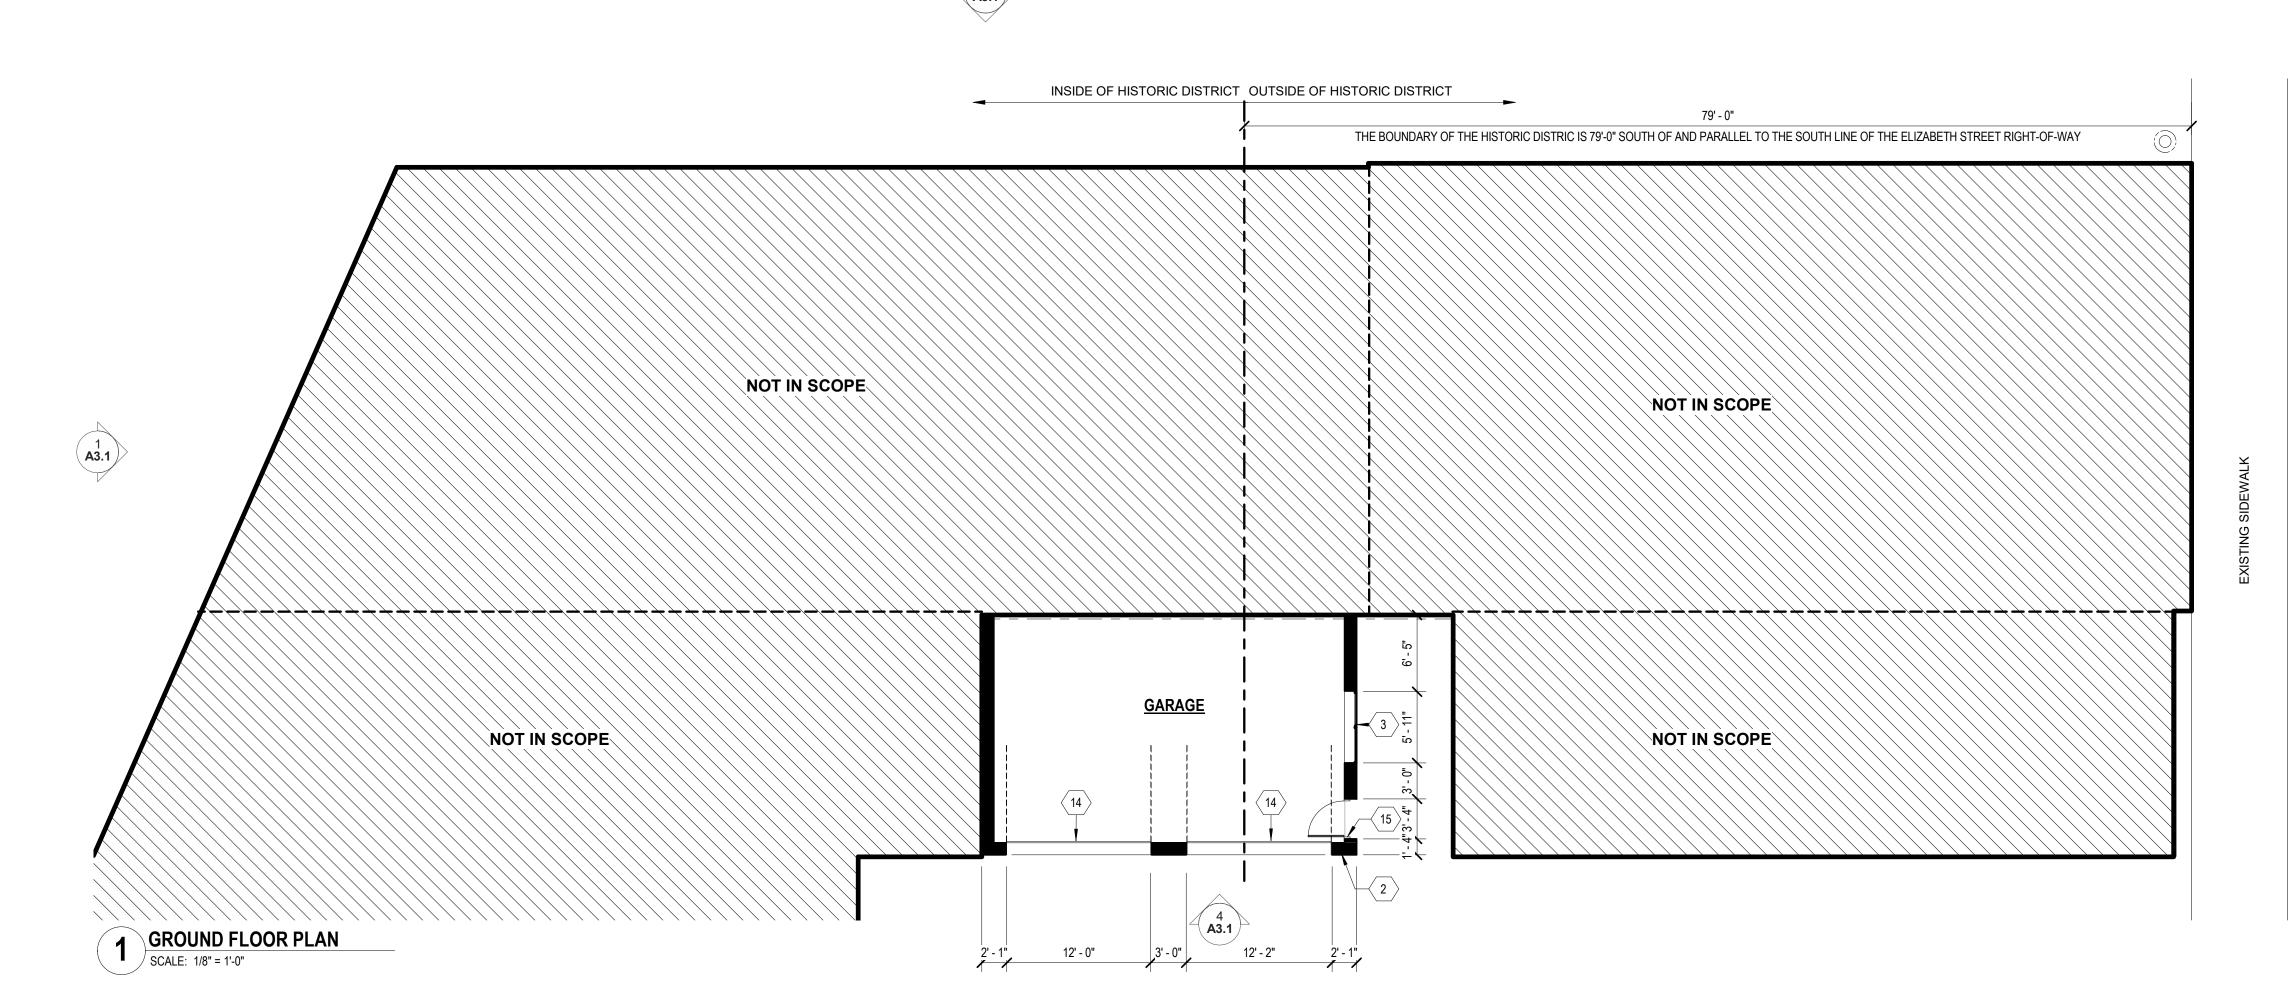

GENERAL PLAN NOTES:

- THIS DRAWING IS DIAGRAMMATIC AND SHOULD BE USED TO DETERMINE THE DESIGN INTENT. THE CONTRACTOR IS RESPONSIBLE FOR THE COMPLETE SET OF WORK AS INDICATED AND SHALL FIELD VERIFY ALL WORK, COORDINATE ALL DRAWINGS / NEW WORK AND SHALL NOTIFY ARCHITECT IMMEDIATELY OF ANY DISCREPANCIES IN THE DOCUMENTS BEFORE PROCEEDING. FAILURE TO DO SO WILL RESULT IN THE CONTRACTOR TAKING FULL RESPONSIBILITY AND LIABILITY FOR SAID DISCREPANCIES.
- CONTRACTOR TO VERIFY ALL DIMENSIONS IN FIELD. ANY DIMENSIONAL VARIANCES CAUSED BY ACTUAL WALL CONSTRUCTION OR LAYOUT MODIFICATIONS IN THE FIELD ARE RESPONSIBILITY OF CONTRACTOR.
- 3. WALL THICKNESS' ARE NOMINAL NOT ACTUAL DIMENSIONS. SEE FLOOR PLAN KEYNOTES FOR WALL CONSTRUCTION.
- 4. ALL WORK SHALL BE DONE IN ACCORDANCE WITH ALL LOCAL, STATE, COUNTY CODE REGULATIONS, O.S.H.A., AND THE AMERICAN WITH DISABILITIES ACT (ADA). REFER TO THE CODE PLAN FOR MORE INFORMATION.
- EXISTING WINDOWS AND EXTERIOR WALLS ARE NOT IN SCOPE. A SEPARATE FACADE REPAIR PACKAGE WILL BE SUBMITTED AT A LATER
- 6. INTERIOR LAYOUT IS SUBJECT TO CHANGE DURING DESIGN DEVELOPMENT.

NEW WORK KEY NOTES:

-PAINTED 1/2" GYP. BD. INTERIOR

(TYPLICAL THIS SHEET ONLY)

1 <u>NEW EXTERIOR WALL:</u>
-PAINTED HORIZONTAL LAP SIDING. BASIS OF DESIGN: JAMES HARDIE LAP SIDING COLOR: CHARCOAL GRAY -WEATHER BARRIER ON 1/2" PLYWOOD SHEATHING -2x6 WD STUDS. R-19 CAVITY INSULATION, MIN.

(ALIGN INTERIOR FACE OF WALL WITH ADJACENT EXISTING WALLS)

- NEW EXTERIOR WALL:
 -BRICK VENEER (USE SALVAGED EXISTING BRICK WHEN POSSIBLE) -2" AIR CAVITY -WEATHER BARRIER ON 1/2" PLYWOOD SHEATHING -2x6 WD STUDS. R-19 CAVITY INSULATION, MIN.
- (3) NEW FIBERGLASS WINDOWS. BASIS OF DESIGN: PELLA IMPERVIA DOUBLE HUNG WITH 12/1 SIMULATED DIVIDED LITE GRILLES.
- 5 NEW FIBERGLASS PATIO DOORS. BASIS OF DESIGN: PELLA IMPERVIA FRENCH PATIO DOORS WITH SIMULATED DIVIDED LITE
- NEW 3/4" SHEATHING ON EXISTING ROOF STRUCTURE. SLOPE TO
- TRAYS WITH METAL EDGE.
- REQUIRED BLOCKING IN ROOF FRAMING TO MEET MANUFACTURER REQUIREMENTS.
- PREFABRICATED CABLE GUARDRAIL. BASIS OF DESIGN: VIEWRAIL "SIGNATURE" CABLE RAIL.
- 12 NEW INTERIOR PARTITION
- NEW INSULATED GARAGE DOOR. FLAT PANEL WITH UPPER GLASS. COLOR: BLACK
- 15 NEW EXTERIOR METAL DOOR. COLOR: BLACK.

Issued for :

04/08/2022

Project:

Space

1440 Michigan Ave Event

4545 architecture

TIM.FLINTOFF@4545ARCHITECTURE.COM

3011 W. GRAND BLVD

DETROIT, MI 48202

SUITE 400

CONSULTANT:

Drawn by : Checked by:

Sheet Title: FLOOR PLANS

Project No.: 2020-023.MichAve

Sheet No.:

-PAINTED 1/2" GYP. BD. INTERIOR

COLOR: BLACK

4 NEW FIBERGLASS FIXED TRANSOM WINDOWS.

GRILLES AS SHOWN. COLOR: BLACK


6 NEW EPDM MEMBRANE ROOF ON SLOPED RIGID INSULATION ON NEW 3/4" SHEATHING ON EXISTING ROOF STRUCTURE. SLOPE TO EXISTING ROOF DRAINS


VEGETATED ROOF TRAY SYSTEM. BASIS OF DESIGN" LIVE ROOF


GLASS AND ALUMINUM RAILING. BASIS OF DESIGN: VIEWRAIL WITH ASCEND TALON SPIGOTS. CONTRACTOR TO COORDINATED

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VEGETATED ROOF TRAY SYSTEM. BASIS OF DESIGN" LIVE ROOF TRAYS WITH METAL EDGE.

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12 NEW INTERIOR PARTITION
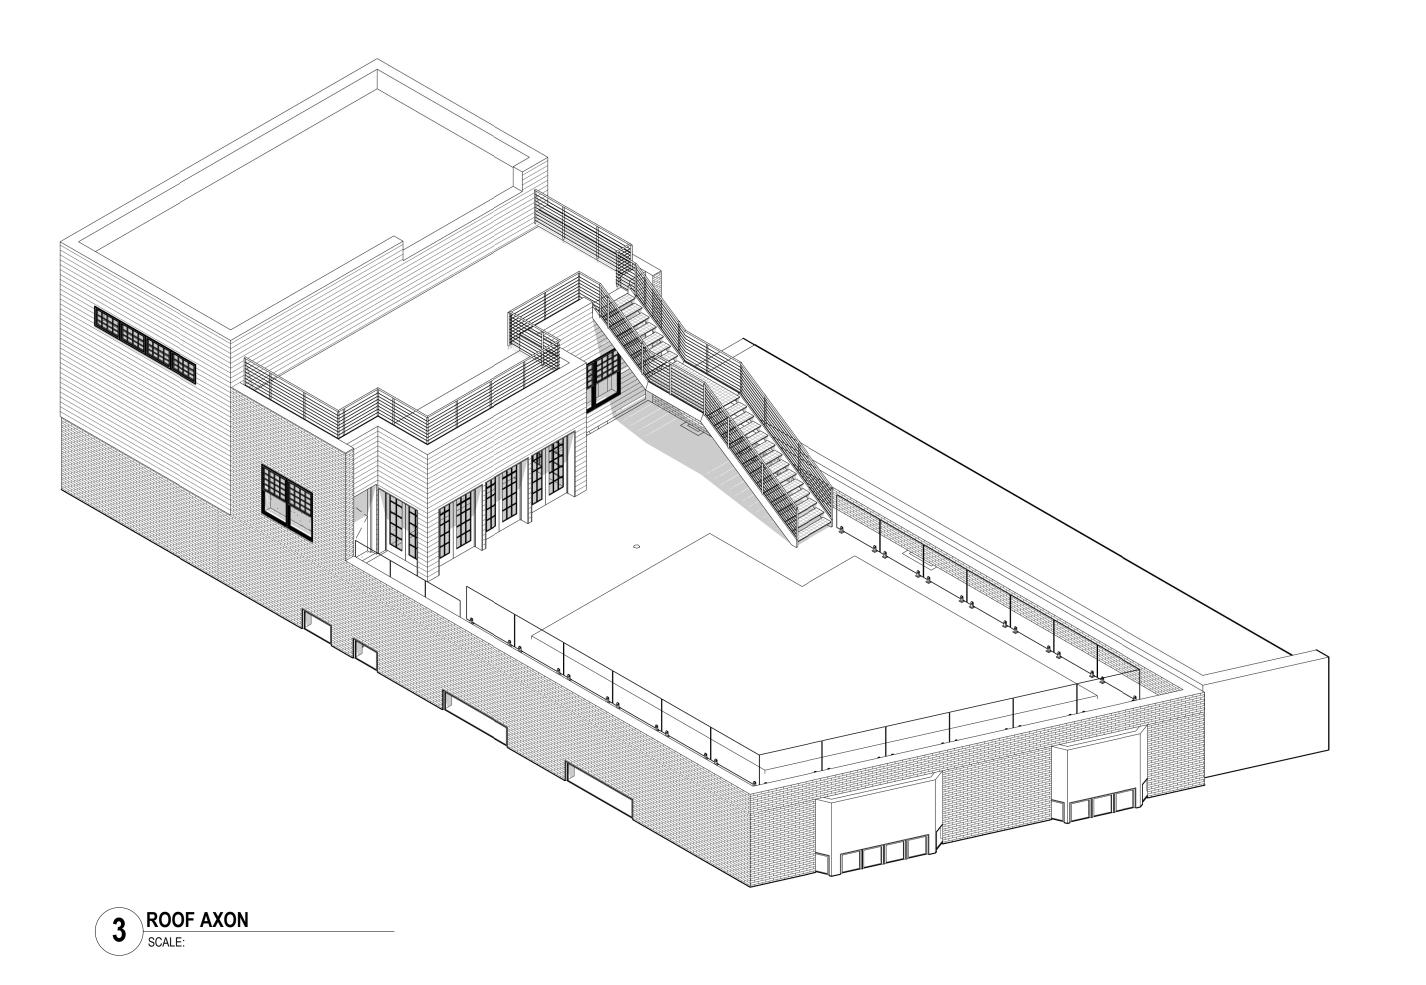
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3011 W. GRAND BLVD

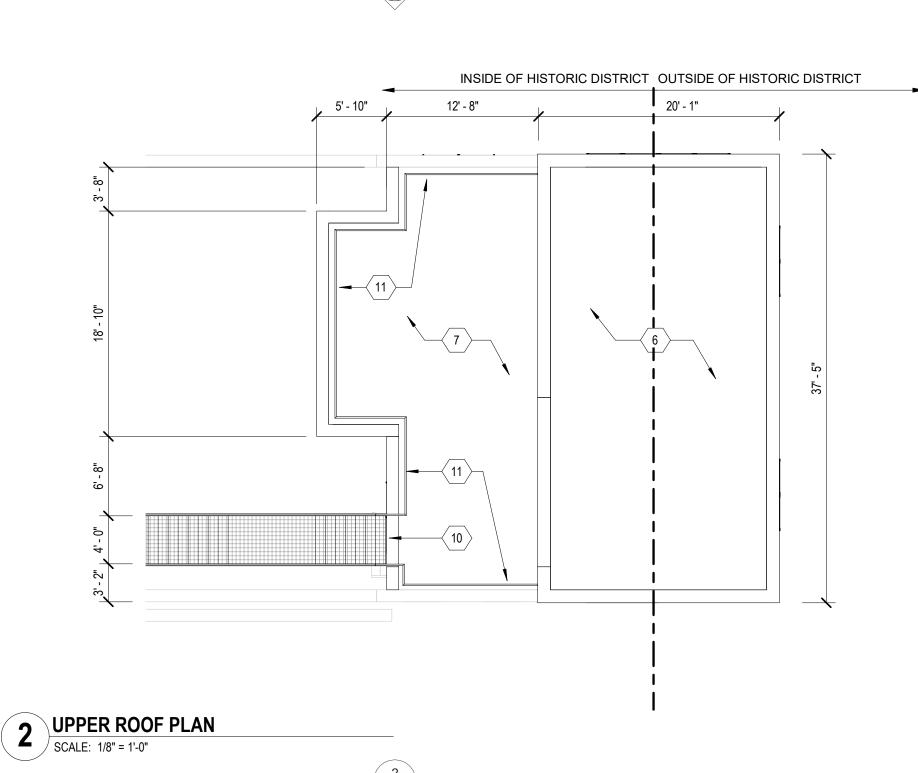SUITE 400

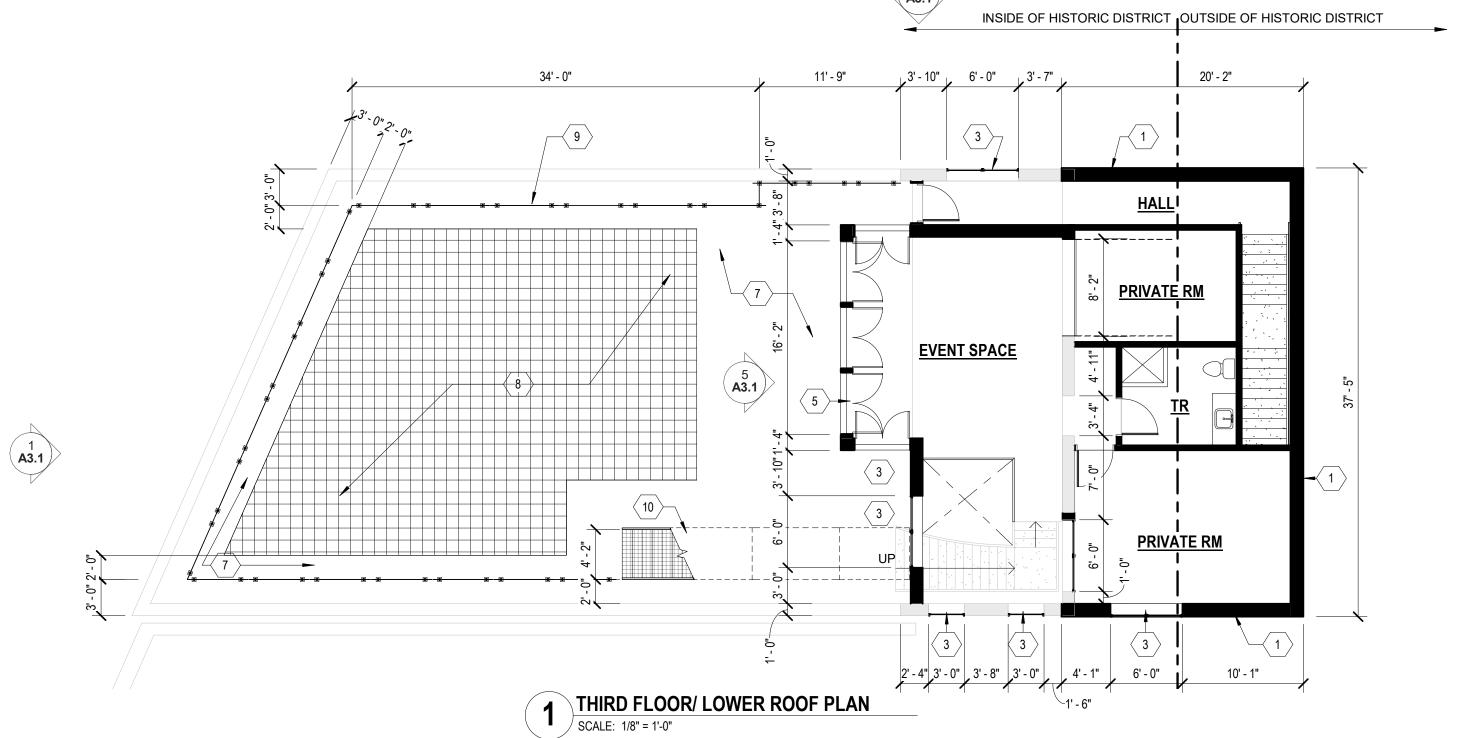CONSULTANT:

TIM.FLINTOFF@4545ARCHITECTURE.COM

DETROIT, MI 48202

1440 Michigan Ave Event


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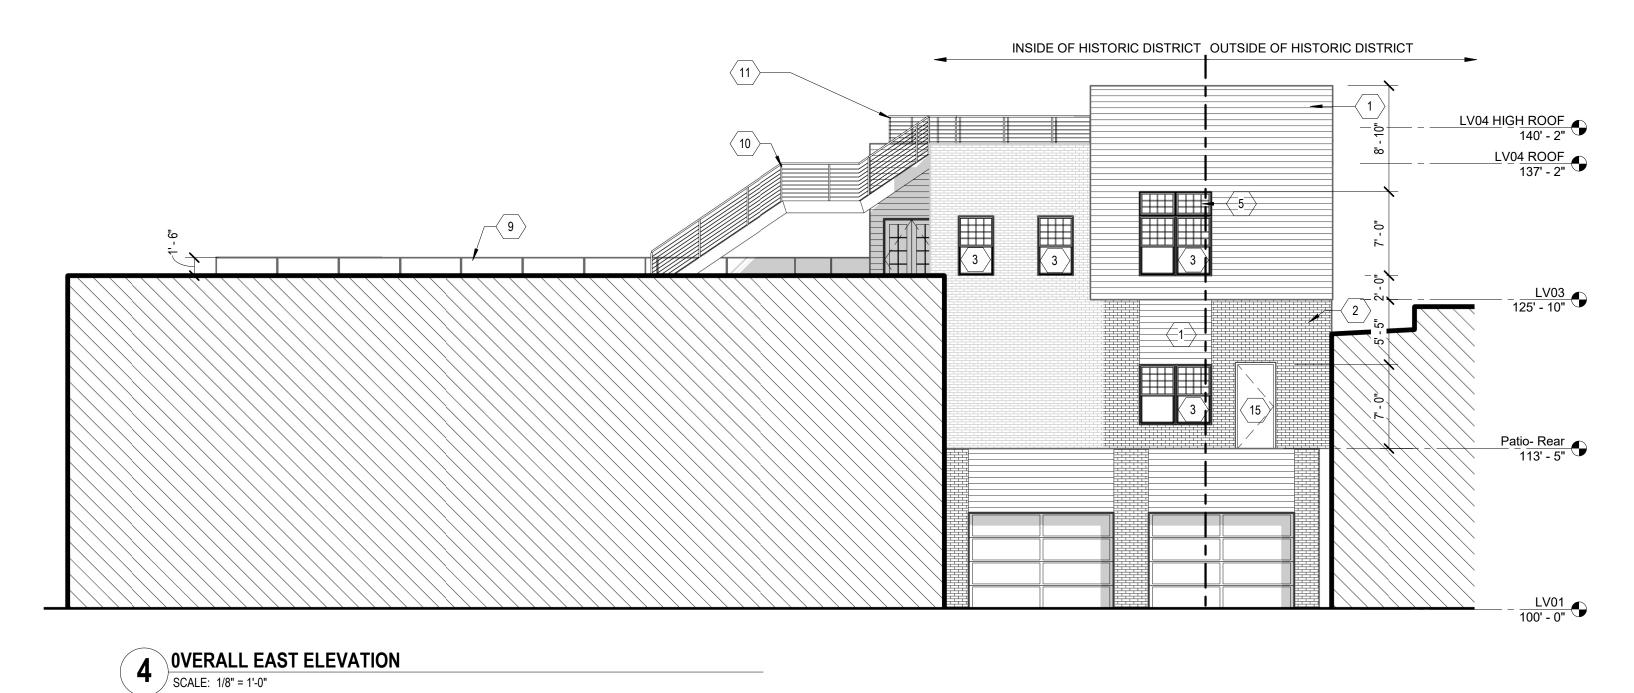
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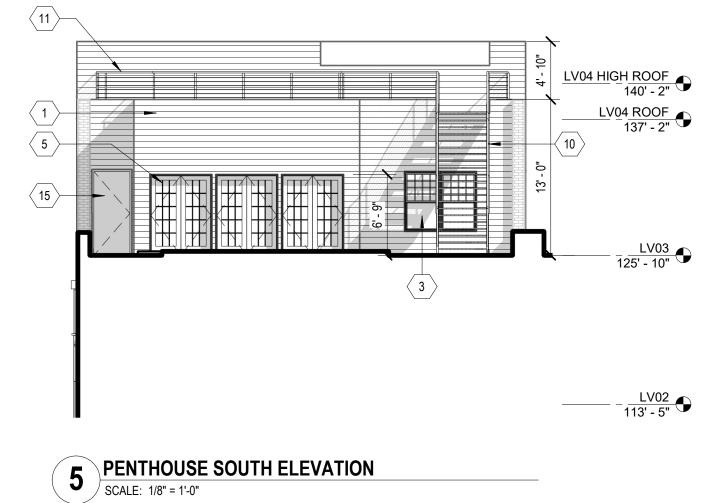
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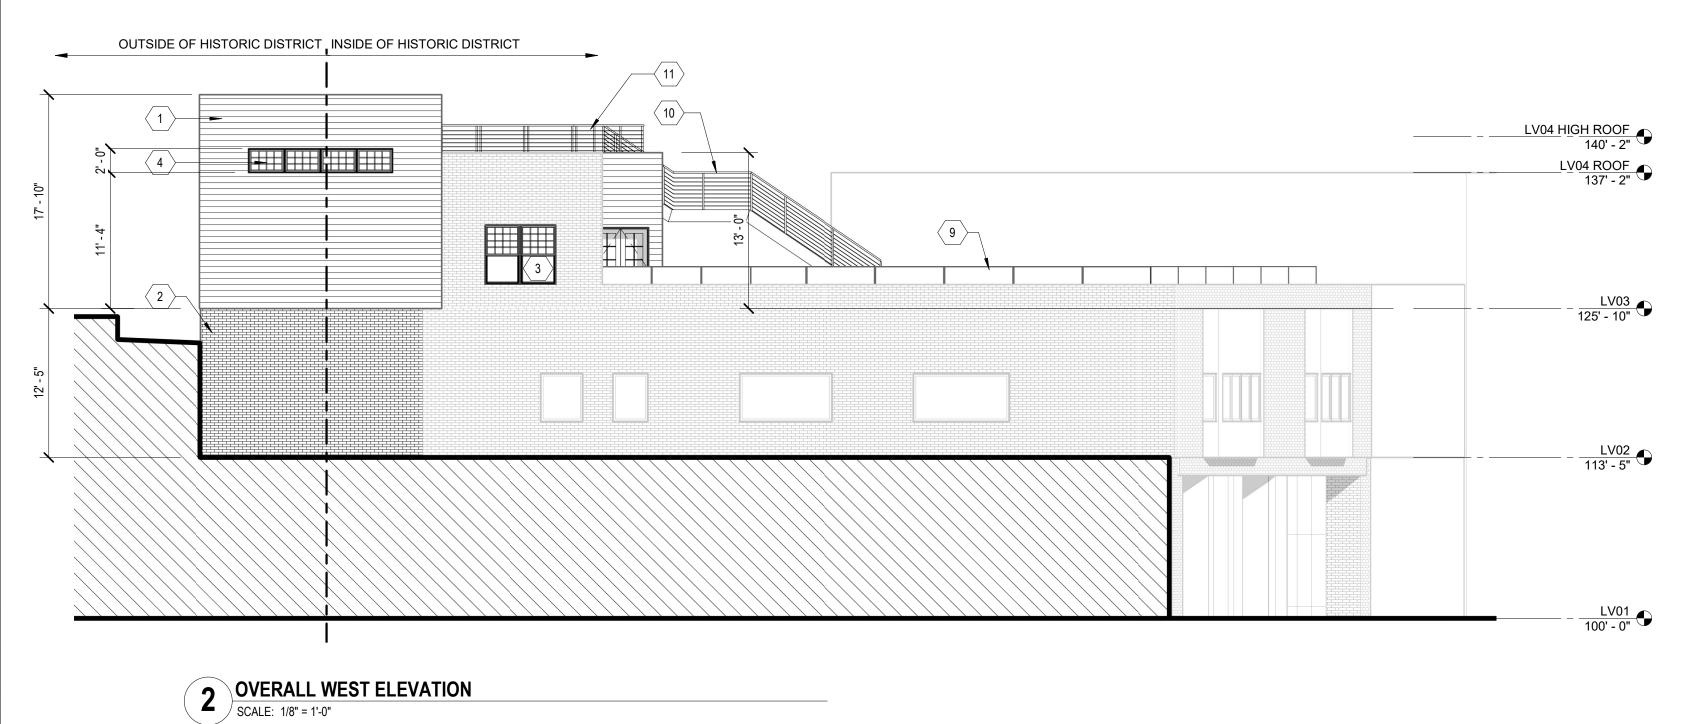
Project No.: 2020-023.MichAve


Sheet No.:







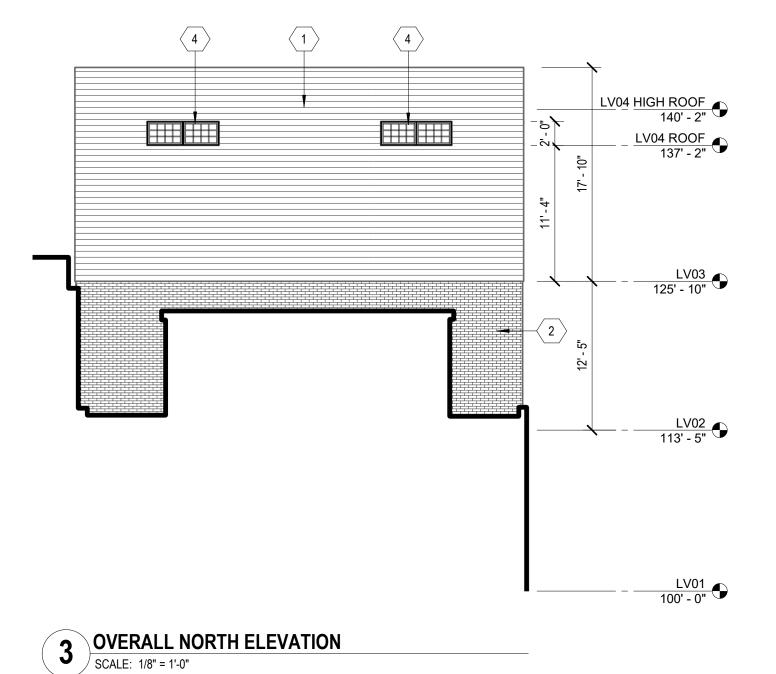

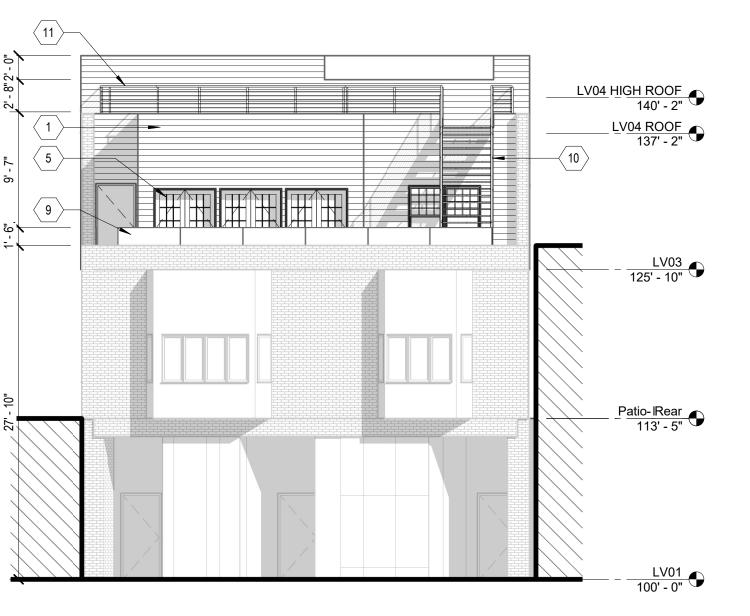

OVERALL SOUTH ELEVATION
SCALE: 1/8" = 1'-0"

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COLOR: BLACK

GRILLES AS SHOWN. COLOR: BLACK

EXISTING ROOF DRAINS

TRAYS WITH METAL EDGE.

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3011 W. GRAND BLVD SUITE 400 DETROIT, MI 48202

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TIM.FLINTOFF@4545ARCHITECTURE.COM

CONSULTANT:

Project:

Space

Issued for :

04/08/2022

1440 Michigan Ave Event

Drawn by :

Checked by: Sheet Title:

EXTERIOR ELEVATIONS

Project No.:

2020-023.MichAve

Sheet No.:



March 21, 2022

RE: 2225 Wabash St – New Construction Historic District Commission Submission

Narrative

1444 Michigan Ave is a 3 Story mixed use building on the north side of Michigan Ave. between Trumbull St and Eight St. The building footprint stretches to W. Elizabeth St with an additional store front facing onto Elizabeth St. The Michigan Ave. Façade has a large storefront at the street level with 2 commercial spaces and the 2nd floor is currently used as residential. The 3rd floor is set back from the street façade maintaining the consistent parapet heights of adjacent buildings.

Our proposal is to renovate the interior of the 2nd floor to create an event space. Additionally, we are planning to construct a new 3rd floor expanding the approximately 750 sq.ft. 3rd floor adding an additional 650 sq.ft. and creating a roof terrace with access to a 2nd terrace on the roof of the 3rd floor via an exterior stair.

Scope of Work

2nd floor:

- Interior renovation for event space
- replace windows on west elevation.

New Construction:

- 650 expansion of 3rd floor
- New windows/doors
- Roof terrace with planters and railing
- Exterior stair to 3rd floor roof terrace, parapet to be used as railing on 3rd floor roof terrace Extend existing interior stairs to provide egress from interior space of 3rd floor and roof terraces.

Design Style Responses

- 1. Height
 - a. The proposed structure is two at the street and 3 stories in the middle of the building, with a total height of approximately 27'-10" above grade (2 story). 44' to top of 3rd floor parapet, This height is constant with the adjacent properties which are also two or 3 stories tall.
- 2. Proportion of Front Façade
 - a. The front façade of the proposed structure is approximately 40'-0" wide, making it slightly wider than it is tall but an overall square in proportion. The south

portion of the front façade is consistent with the neighboring buildings maintaining a continuous street façade.

3. Proportion of Openings

a. The windows proposed for the structure are generally wood double style on the second and 3rd floors and store front on the ground floor. Individual windows are taller than they are wide and grouped together to form larger areas of glazing. On the front façade, the openings make up about 40% of the façade.

4. Rhythm of Solid to Void

a. Openings in the facades of the proposed structure are regular and ordered, like the existing Greek revival homes on either side of the proposed structure. Individual windows and groups of windows are placed directly above each other form the first to second floor.

5. Rhythm of Spacing of Buildings

a. The proposed structure matches the consistency of spacing with adjacent buildings, the 3rd floor is set back to minimize the impact at the street level and from the intersection of Michigan Ave. and Trumbull St..

6. Rhythm of Entrance and/or front porch projections

a. The proposed structure features a symmetric front entry for two commercial spaces and for the access to the $2^{nd}/3^{rd}$ floors.

7. Materials

a. The proposed structure is comprised of wood framing with a concrete foundation, and a flat roofs. The majority of the facades are clad in brick, the front façade ins clad in a buff color brick contrasting with the red brick on the remaining facades. main material concept is to create hierarchy and order by using the different materials to define zones that nest inside each other. The addtyion will be wrapped in brick on the sides and a portion of the rear wit the reaminder being clad in a contrasting shiplap siding.

8. Textures

a. Texture is at play in the relationship between the ship-lap wood siding, brick and window fenestration. The majority of the front façade is clad in horizontally oriented wood ship-lap siding. Nested within the field brick wings, windows and 3 pairs of French doors for the majority of the façade on the front face of the 3rd floor..

9. Colors

a. The color palette of the proposed structure has been kept neutral and natural in order to blend in with the existing homes on the block. The brick and roof, and painted wood ship-lap siding are all within a gray-scale pallet.

10. Architectural Details

a. The architectural details of the proposed structure are very simple in order to complement the existing modest homes on the block. The overall massing and roof shape are similar to adjacent historic homes, while the clean simplified detailing are more contemporary. In order to match the level of detail and visual interest of the existing homes, a concept of layering and texture is used to create depth and hierarchy in the facades. The vertically oriented wood ship-lap siding projects out from the wall slightly further than the horizontally oriented siding. Windows and metal panel are further inset from the wood siding, creating multiple layers of depth. While the facades do not feature much ornament, this layering of materials will create dynamic and interesting shadow lines on the façade. The overall effect is intended to be effective but subtly, as to not overwhelm the character of the adjacent existing buildings.

11. Roof Shapes

a. Similar to many existing buildings on the block, the proposed structure features a simple flat roof line

12. Wall of Continuity (setbacks)

a. The front setback of the proposed structure is similar to adjacent properties. This helps maintain the already established wall of continuity. In addition, the projection of the front porch and built-in planters along the front façade of the structure maintain the secondary wall of continuity created by the front porches of adjacent homes.

13. Landscape Features

a. The shallow front lawn of the proposed structure is grass turf, consistent with adjacent properties. More decorative bushes and flowering plants will be included in the built-in planter boxes that wrap the front and south facades. Vegetated screens are also proposed at the south-east corner of the structure, increasing the amount of decorative vegetation visible from the street. A simple concrete foot path extends from the sidewalk along the south façade to provide access to the entries of each unit.

14. Open space

a. The lot of this area a densely built to maintain a strong commercial storefront street wall.

15. Scale of Facades/Façade Elements

a. The overall structure is a similar scale to the existing homes on the block. The front elevation is fairly simple with few façade elements. Window groupings are always in the same plane as the overall façade. Window groupings are generally 3-4 windows wide, which is approximately one-quarter to one-third of the overall façade width.

16. Directional Expression of Front Elevation

a. The directional expression of the front elevation is generally vertical. The recessed store fronts and the 2nd floor bay windows create visual interest and draw you view to the front façade. The 3rd floor is set back far enough that visually from the street it will disappear.

17. Rhythm of Setbacks

a. The front setback of the proposed structure is consistent with adjacent properties on the block.

18. Lot Coverage

a. Lot Size: 5880 Square Feetb. Building Footprint: 5880

c. Percentage of lot Coverage: 1000%

19. Degree of Complexity in Façade

a. The proposed structure is very simple in massing and façade complexity. The façade uses a simple palate of 2 materials, organized in a way to provide hierarchy, depth and interest without relying on additional detail and applied architectural elements.

20. Orientation/Vistas/Views

a. The long axis of the proposed structure is oriented north-south with the front of the structure facing Michigan Ave. The event space and roof terrace are oriented to face south this gives opportunity for views and daylight to the event spaces.

21. Symmetric or asymmetric appearance

a. The appearance of the proposed structure is asymmetric to complement existing asymmetric homes on the block. Windows on the front façade are aligned to the north edge, while the recessed front entry is situated to the south side. This arrangement of openings along with the "nested" approach to materials creates a balanced composition.


22. General Character

a. Corktown is made up of modestly detailed small-scaled homes and commercial buildings on narrow lots creating a dense walkable neighborhood. The proposed structure follows the simple massing and closely spaced arrangement precedent set by the existing adjacent structures. The materials used for the proposed structure speak to the textural quality of the existing structures with the use of wood ship-lap siding and brick. The contemporary use of these material speak to the longevity of the neighborhood and the notion that Corktown structures are built to last. The buildings in Corktown were built over various periods of time, and are examples of many architectural styles. What makes the neighborhood cohesive is the attention to scale, proportion, and quality in each home regardless of style. While the proposed structure utilizes some contemporary elements, the overall scale, massing, and textural quality are inspired by and designed to compliment the overall Corktown character.

Exterior images:



Michigan Ave Facade

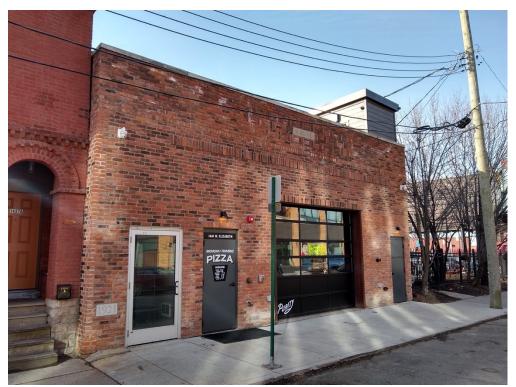

W. Elizabeth Façade



East Façade



West Façade



<u>West Façade</u>

